A.F.F.	ABOVE FINISH FLOOR	INFO.	INFORMATION
ADJ.	ADJUSTABLE	INSUL.	INSULATION
ALT.	ALTERNATE	JST.	JOIST
A.B.	ANCHOR BOLTS	L.L.	LIVE LOAD
&	AND	LONGINT.	LONGITUDINAL
ARCH.	ARCHITECTURAL	N.I.C.	NOT IN CONTRACT
(a),	AT	O.C.	ON CENTER
BM.	BEAM	OPP.	OPPOSITE
BM. PKT.	BEAM POCKET	O/	OVER
BRG.	BEARING	PTD.	PAINTED
BLK'G.	BLOCKING	PERF.	PERFORATED
BOT.	BOTTOM	PL.	PLATE
B.F.	BOTTOM OF FOOTING	PLY.	PLYWOOD
BLDG.	BUILDING	PROP. LINE	PROPERTY LINE
B.O.	BY OWNER	REINF.	REINFORCEMENT
CAB.	CABINET	RDWD.	REDWOOD
CLG.	CEILING	REQ'D.	REQUIRED
CL.	CENTER LINE	RESIL.	RESILIENT
C.T.	CERAMIC TILE	REV.	REVISED
CLR.	CLEAR	S.M.	SHEET METAL
COL.	COLUMN	SIM.	SIMILAR
CONC.	CONCRETE	S.F. OR SQ. FT.	SQUARE FEET
CONN.	CONNECTION	STD.	STANDARD
CONT.	CONTINUOUS	STL.	STEEL
DTL.	DETAIL	STDS.	STUDS
DBL.	DOUBLE	THK.	THICK
DWL.	DOWEL	TLT.	TOILET
E.W.	EACH WAY	T.F.	TOP OF FOOTING
ELEV. OR	ELEVATION	T.P.	TOP OF PLATE
EL.	EXISTING	T.L.	TOP OF LEDGE
EXIST'G	EXTERIOR	T.W.	TOP OF WALL
EXT.	FINISHED FLOOR	TOT.	TOTAL
F.F.	FLOOR DRAIN	T.B.	TOWEL BAR
F.D.	FLOOR	TRANSV.	TRANSVERSE
FLR.	FOOTING	TYP.	TYPICAL
FTG.	FOUNDATION	U.N.O.	UNLESS NOTED OTHE
FND.	GAUGE	V.I.F.	VERIFY IN FIELD
GA.	GLU-LAM	VERT.	VERTICAL
G.L.	GYPSUM WALL BOARD	V.W.C.	VINYL WALL COVERI
G.W.B.	GAS STUB	W.C.	WATER CLOSET
G.S.	HOSE BIB	W.H.	WATER HEATER
HB.	HEIGHT	W.P.	WATERPROOF
HT.	HOOK	W.R.	WATER RESISTANT
HK.	HORIZONTAL	WIN.	WINDOW

W/

WD.

HYDRANT

HORIZ.

HYD.

312 W Hyman Ave Powder Day Skiiing, LLC, David A Tarrab Mees

312 W Hyman Ave Lots P+Q, Block 46 Aspen CO 81611 USA/Pitkin County UGB, City of Aspen

PROJECT: Renovation, Energy Upgrades and Historic Preservation ADDRESS: 312 W Hyman Ave, Aspen, CO 81611

COUNTY: Pitkin County

PARCEL NUMBER: 2735-124-64-006 Interior Renovation and Energy Upgrades, IECC Compliance PROJECT DESCRIPTION:

Non-sprinklered

ZONING: R6 Medium Density Residential

CONSTRUCTION TYPE: OCCUPANCY GROUP: RESIDENTIAL FIRE PROTECTION: NUMBER OF STORIES: TWO

ELEVATION 100= 7901.36' SITE RS6 = 6000 SF

BUILDING

Currently Adopted COA I-Codes.

The client will conform with currently adopted IECC (Assemblies and Fenestration) and the updated land use code for Energy Efficiency on Earth Day 2020.

Snow-load: Up to 8000' Elevation, Elevation is 7901.36' Building 100' as per Civil = 7901.36', Garage = 7902.86'

Roof Duration = 1.0Seismic Design Category = B or C, as per Figure R301.2 (2) As per soil design category

Weathering probability for Concrete = Severe Termite Infestation Probability = None to slight Wind Speed = 115 mph (ultimate design) Wind Exposure = B or C, Section R301.2.1.4

Frost Depth = 36", up to 8000' Elevation Ice Barrier Underlayment = Required Mean Annual Temp = variable

Insulation = as per Minimum R-Values per 2021 IECC, Table 402.1.1 As per State House Bill 09-1091, CO alarms are required within 15 feet of all sleeping rooms

Project summary as per Land Use Code:

1. The historic building and the site remains key elements of the property and the new development does not compromise the visual integrity of the historic property; and

2. The new construction is reflective of the proportional patterns found in the historic building's forms, materials and openings, or the work removes later alterations and restores the historic building to its appearance during its period of

3. The project is compatible with the character of the neighborhood in which it is located; and

4. Historic outbuildings site and landscape features are retained and stabilized and restored, as appropriate.

The project conforms to City of Aspen Chapter 26: Title 26- Land Use Regulations

Part 400- Development Permit as of Right

Part 500- Supplementary Regulations





Relationship to the Neighborhood

1. CONTRACTOR TO COMPLY WITH CODES, LAWS, ORDINANCES, RULES, AND REGULATIONS OF PUBLIC AUTHORITIES GOVERNING THE WORK.

2. CONTRACTOR TO REVIEW DOCUMENTS, VERIFY DIMENSIONS AND FIELD CONDITIONS AND CONFIRM THAT WORK IS BUILDABLE AS SHOWN. CONTRACTOR TO REPORT ANY CONFLICTS OR OMISSIONS TO THE ARCHITECT FOR CLARIFICATION PRIOR TO PERFORMING ANY WORK IN QUESTION. 3. FOR SUBSTITUTIONS, REFER TO THE SPECIFICATIONS.

WITH

WOOD

4. DO NOT SCALE DRAWINGS. DIMENSIONS SHALL TAKE PRECEDENCE OVER SCALES SHOWN ON DRAWINGS, GENERAL CONTRACTOR SHALL VERIFY ALL DIMENSIONS, GRADES AND CONDITIONS AT

PRIOR TO COMMENCING THE WORK. 5. MAINTAIN DIMENSIONS MARKED 'CLEAR'. ALLOW FOR THICKNESS OF FINISHES.

6. CEILING HEIGHT DIMENSIONS ARE TO FINISHED SURFACES. 7. CONTRACTOR TO COORDINATE AND PROVIDE BACKING FOR MILLWORK AND ITEMS ATTACHED OR MOUNTED TO WALLS OR CEILINGS.

8. EXCEPT WHERE SHOWN IN DIMENSIONAL DETAIL, THE LOCATIONS OF PLUMBING, MECHANICAL EQUIPMENT, DUCTS, PIPING AND FITTINGS ARE ONLY APPROXIMATE. THE EXACT LOCATIONS SHALL BE

DETERMINED BY THE CONTRACTOR, SUBJECT TO APPROVAL BY THE ARCHITECT. 9. CONTRACTOR SHALL PROVIDE AND INSTALL ALL STIFFENERS, BRACING, BLOCKING, AND SUPPORTING BRACKETS REQUIRED FOR THE INSTALLATION OF ALL CASEWORK, TOILET ROOM

ACCESSORIES, FIXTURES AND PARTITIONS AND ALL WALL MOUNTED OR SUSPENDED MECHANICAL, ELECTRICAL OR MISCELLANEOUS EQUIPMENT AND FURNISHINGS. 10. ALL WORK PERFORMED SHALL COMPLY WITH THE CONTRACT DOCUMENTS, DRAWINGS,

SPECIFICATIONS, AND GEOTECHNICAL INVESTIGATION AND PAVEMENT RECOMMENDATIONS.

11. SPECIFICATIONS, BOUND SEPARATELY, ARE PART OF THE CONTRACT DOCUMENTS. 12. ALL MATERIALS AND WORKMANSHIP SHALL CONFORM TO THE DRAWINGS AND SPECIFICATIONS. IF

CONFLICT IS FOUND BETWEEN DRAWINGS, GENERAL NOTES AND SPECIFICATIONS, CONSULT THE ARCHITECT BEFORE PROCEEDING WITH THE WORK. 13. THE STRUCTURAL, MECHANICAL AND ELECTRICAL DRAWINGS ARE SUPPLEMENTARY TO THE

ARCHITECTURAL DRAWINGS. IT SHALL BE THE RESPONSIBILITY OF THE CONTRACTOR TO CHECK WITH THE ARCHITECTURAL DRAWINGS BEFORE THE INSTALLATION OF STRUCTURAL, MECHANICAL AND ELECTRICAL WORK. SHOULD THERE BE A DISCREPANCY BETWEEN THE ARCHITECTURAL DRAWINGS

THE CONSULTING ENGINEERS' DRAWINGS THAT WOULD CAUSE AN AWKWARD INSTALLATION, IT SHALL

BROUGHT TO THE ARCHITECT'S AND ENGINEERS' ATTENTION FOR CLARIFICATION PRIOR TO THE INSTALLATION OF SAID WORK.

14. GENERAL NOTES ARE NOT A SUBSTITUTE NOR A REPLACEMENT FOR THE PROJECT SPECIFICATIONS. THESE NOTES ARE INTENDED AS A GUIDE TO THE DESIGN AND/OR CONSTRUCTION REQUIREMENTS ESTABLISHED FOR THIS PROJECT.

15. NO CONTRACTOR SHOULD ATTEMPT TO BID OR CONSTRUCT ANY PORTION OF THE WORK WITHOUT CONSULTING THE PROJECT SPECIFICATIONS.

16. THE CONTRACTOR SHALL COORDINATE THE INTENT OF THE GENERAL NOTES WITH ALL TRADES



SHEET INDEX A001 Cover Sheet Improvement Survey V2 Topographic Survey Plat C.001 Title C.002 **Existing Conditions** C.003 **Demolition Plan** C.004 Grading Plan C.005 Basins C.006 Subbasins Drainage Layout

C.009 Utility Plan **Erosion Control** C.011 Details

Engineering & Drainage Report Engineering & Drainage Report Tree Removal and Mitigation

Drainage Profiles

L2.002 Proposed Landscape Plan General Notes and Typical Details S 1.0 Foundation Plan

S 1.1 Upper Level & Garage Roof Framing Plans

S1.2 Roof Framing Plan S2.0 Details

S2.1 Details SH-1 Shoring Plan

> Floor Area Calculations Z002 Floor Area Calculations Z003 Height Measurements Wall Demolition Calculations

Z005 Site Coverage Z006 Zoning Summary

Forestry Site Coverage Existing, HPC Approved, HPO Approved Existing, HPC Approved, HPO Approved

Existing, HPC Approved, HPO Approved HPC Approved and SAM Architectural Site Plan Contractor Site Plan CMP Main Level Proposed Plan Second Level Proposed Plan Roof Plan Proposed Main Level Existing Plan

Second Level Existing Plan Roof Plan Existing Main Level RCP

Second Level RCP Exterior Stairways Enlarged Interior Stairs Enlarged Elevations Proposed

Elevations Proposed A202 Existing Elevations Existing Elevations Garage Elevations

A300 **Building Sections** Interior Elevations Interior Elevations Interior Elevations Interior Elevations

A500 Schedules A501 Schedules Assemblies & Plan Details

Assemblies- Skylights, Fenestration A- E101 Electrical- Lamps

A- E102 Electrical- Exterior A - P100 Plumbing Narrative

cloud hill design. llc

Jeffrey H. Woodruff AIA, NCARB, LEED AP Cloud Hill Design, LLC Snowmass CO 81654 USA

INTEGRATED DESIGN TEAM

Civil Grading and Drainage Jay Engstrom, P.E. Crystal River Civil, LLC

Landscape Architect Jennifer M. Dolecki-Smith, RLA Escape Garden Design, LLC Structural Engineer Brian Rossiter, P.E.

Contractor Adam Rothberg Rothberg Development

bwr.pe



312 W Hyman Ave

312 W Hyman Ave Lots P+Q, Block 46 Aspen CO 81611 USA/ Pitkin County UGB, City of Aspen

312 W Hyman Ave Aspen CO 81611 USA

Powder Day Skiiing, LLC, David A Tarrab Mees

> Account # R000145 Parcel ID # 273512464006

08/22/21 COA- HPO Site Visit

02/26/22 COA- HPC Conceptual I

04/27/22 COA- HPC Conceptual II

07/27/22 COA- HPC Final

10/12/22 COA- City Council Call Up

04/12/23 COA- HPC Substantial

06/28/23 COA- Permit Submittal

07/29/24 COA- Building comments, #4

PROJECT NO: Project No. 116


MODEL FILE: 312_W_Hyman_07292024.pln


DRAWN BY: Jeffrey H Woodruff COPYRIGHT:


SHEET TITLE

Cover Sheet

IMPROVEMENT SURVEY PLAT LOTS P & Q - BLOCK 46, CITY AND TOWNSITE OF ASPEN SECTION 12, TOWNSHIP 10 SOUTH, RANGE 85 WEST OF THE 6TH PM COUNTY OF PITKIN, STATE OF COLORADO **LEGEND** -FOUND NO. 5 REBAR **E ELECTRICAL METER** G GAS METER ▼ TELEPHONE PEDESTAL △ ELECTRIC PEDESTAL ☐ CATV PEDESTAL SET FOUND NO. 5 REBAR & -PROPERTY DESCRIPTION: 1-1/4" ORANGE PLASTIC CAP PROP CORNER TNC PLS38215 ENCROACHMENT LOTS P AND Q, BLOCK 46, CITY AND TOWNSITE OF ASPEN. R.R.TIE WALL SCALE: 1" = 8' COUNTY OF PITKIN STATE OF COLORADO LOTP SCHEDULE B PART II TITLE EXCEPTIONS: 5976± SQ.FT. EXCEPTIONS 1 THROUGH 6 & 9 ARE STANDARD TITLE EXCEPTIONS. 10.) THIS PROPERTY IS SUBJECT TO EXCEPTIONS AND RESERVATIONS AS SET FORTH IN THE ACT AUTHORIZING THE ISSUANCE OF THE PATENT FOR THE CITY AND TOWNSITE OF ASPEN, DATED JANUARY 29, 1897 AND RECORDED ALLEYS, EXCEPT SUCH STREETS AND ALLEYS HERETOFORE VACATED: AND PROVIDING FOR THE FILING OF SAID MAI FIELD NOTES, AND SUPPLEMENTAL PLATS WITH THE CLERK AND RECORDER FOR PITKIN COUNTY (ORDINANCE NO. 6, SERIES OF 1959) DATED NOVEMBER 16, 1959, AND RECORDED DECEMBER 18, 1959, AS 12.) THIS PROPERTY IS SUBJECT TO ANY AND ALL NOTES, EASEMENTS AND RECITALS AS DISCLOSED ON THE OFFICIAL MAP OF THE CITY OF ASPEN, RECORDED DECEMBER 16, 1959 AS RECEPTION NO. 109023 13.) THIS PROPERTY IS SUBJECT TO ANY AND ALL NOTES, EASEMENTS AND RECITALS AS DISCLOSED ON THE WILLETS MAP NOVEMBER 12, 1969 IN PLAT BOOK 4 AT PAGE 27 AS RECEPTION NO. 137902. 14.) THIS PROPERTY IS SUBJECT TO TERMS, CONDITIONS, PROVISIONS, AGREEMENTS AND OBLIGATIONS SPECIFIED 2 - STORY FRAME HOUSE 312 WEST HYMAN AVENUE 13.) THIS PROPERTY IS SUBJECT TO ANY AND ALL NOTES, ENCROACHMENTS, EASEMENTS AND RECITALS AS DISCLOSED ON THE IMPROVEMENT & TOPOGRAPHIC SURVEY PLAT DATED FEBRUARY 1, 2019, AND RECORDE JANUARY 29, 2020 IN PLAT BOOK 127 AT PAGE 40 AS RECEPTION NO. 662367, INCLUDING BUT NOT LIMITED TO THE GRAVEL DRIVEWAY AND WOOD RETAINING WALL ONTO LOT R. 16.) THIS PROPERTY IS SUBJECT TO ANY EXISTING LEASES OR TENANCIES, AND ANY AND ALL PARTIES CLAIMING BY, THROUGH OR UNDER SAID LESSEES. **SURVEY NOTES:** 1. BASIS OF BEARINGS FOR THIS SURVEY IS A BEARING OF N75°09'11"W BETWEEN A FOUND NO. 5 REBARS AS 2. DATE OF FIELD SURVEY: JANUARY 15, 2019. AT THE TIME OF THE FIELD SURVEY THERE WAS 4"+ OF SNOW ON 3. LINEAR UNITS USED TO PERFORM THIS SURVEY WERE U.S. SURVEY FEET. 4. THIS SURVEY IS BASED ON THE OFFICIAL MAP OF THE CITY OF ASPEN DATED DECEMBER 18, 1959 AS RECEPTION NO. 109043, THE PLAT OF RESUBDIVIDED LOTS K, L, M, N, O, BLOCK 46 RECORDED JANUARY 15, 1982 IN PLAT —APPARENT BOOK 12 AT PAGE 54 AND CORNERS FOUND IN PLACE AS SHOWN HEREON. ENCROACHMENT WOOD RETAINING 5. THIS IMPROVEMENT SURVEY PLAT DOES NOT CONSTITUTE A TITLE SEARCH BY TRUE NORTH COLORADO, LLC, FOR ALL INFORMATION REGARDING EASEMENT, RIGHTS-OF-WAY AND/OR TITLE OF RECORD, TRUE NORTH COLORADO, LLC. RELIED UPON TITLE COMMITMENT NO. 20004656 ISSUED BY ATTORNEYS TITLE INSURANCE AGENCY OF ASPEN, LLC, EFFECTIVE DATE: APRIL 9, 2021. - FOUND NO. 5 REBAR 6. BEARINGS AND DISTANCES SHOWN HEREON ARE BASED ON FIELD MEASUREMENTS. BEARINGS AND DISTANCES SHOWN IN PARENTHESIS ARE OF RECORD SHOWN ON THE OFFICIAL MAP OF THE CITY OF ASPEN DATED NOVEMBER 16, 1959. GRAVEL SURVEYOR'S CERTIFICATION DRIVEWAY ENCROACHMENT I, RODNEY P. KISER, HEREBY CERTIFY TO POWDERDAYSKIING, LLC, ATTORNEYS TITLE INSURANCE AGENCY OF ASPEN, LLC DRIVEWAY & AND FIDELITY NATIONAL TITLE INSURANCE THAT THIS IS AN IMPROVEMENT SURVEY PLAT, AS DEFINED BY C.R.S. § **WOOD RETAINING** 38-51-102(9) AND THAT IT IS A MONUMENTED LAND SURVEY SHOWING THE LOCATION OF ALL STRUCTURES, VISIBLE UTILITIES, FENCES, HEDGES, OR WALLS SITUATED ON THE DESCRIBED PARCEL AND WITHIN FIVE FEET OF ALL BOUNDARIES OF SUCH PARCEL, ANY CONFLICTING BOUNDARY EVIDENCE OR VISIBLE ENCROACHMENTS, AND ALL EASEMENTS, FOUND NO. 5 REBAR UNDERGROUND UTILITIES, AND TUNNELS DESCRIBED IN ATTORNEYS TITLE INSURANCE AGENCY OF ASPEN, LLC AS AGENT FOR FIDELITY NATIONAL TITLE INSURANCE COMPANY'S COMMITMENT FOR TITLE INSURANCE, CASE NO. 20004656, DATED: APRIL 9, 2021, OR OTHER SOURCES AS SPECIFIED ON THE IMPROVEMENT SURVEY PLAT. RODNEY P. KISER LICENSED PROFESSIONAL LAND SURVEYOR COLORADO REGISTRATION NO. 38215 REVISED: APRIL 13, 2021: UPDATED TITLE COMMITMENT AND CERTIFICATION. REVISED: JANUARY 30, 2019: UPDATED TITLE COMMITMENT AND CERTIFICATION. CITY OF ASPEN IMPROVEMENT SURVEY PLAT SE CORNER -LOTS P & Q - BLOCK 46 CITY OF ASPEN BLOCK 46 COUNTY OF PITKIN - STATE OF COLORADO FOUND REBAR & 1-1/2' ALUMINUM CAP (NO STAMPING) TRUE NORTH COLORADO LLC. A LAND SURVEYING AND MAPPING COMPANY PO BOX 614 - 529 S. WILD HORSE DRIVE NEW CASTLE, COLORADO 81647 (970) 984-0474 A LAND SURVEYING AND MAPPING COMPANY www.truenorthcolorado.com NOTICE: ACCORDING TO COLORADO LAW YOU MUST COMMENCE ANY LEGAL PROJECT NO: **2019-10**4 ACTION BASED UPON ANY DEFECT IN THIS SURVEY WITHIN THREE YEARS AFTER YOU FIRST DISCOVER SUCH DEFECT. IN NO EVENT MAY ANY ACTION **SHEET** BASED UPON ANY DEFECT IN THIS SURVEY BE COMMENCED MORE THAN TEN YEARS FROM THE DATE OF CERTIFICATION SHOWN HEREON. SURVEYED 1 OF 1 DATE: JANUARY 18, 201

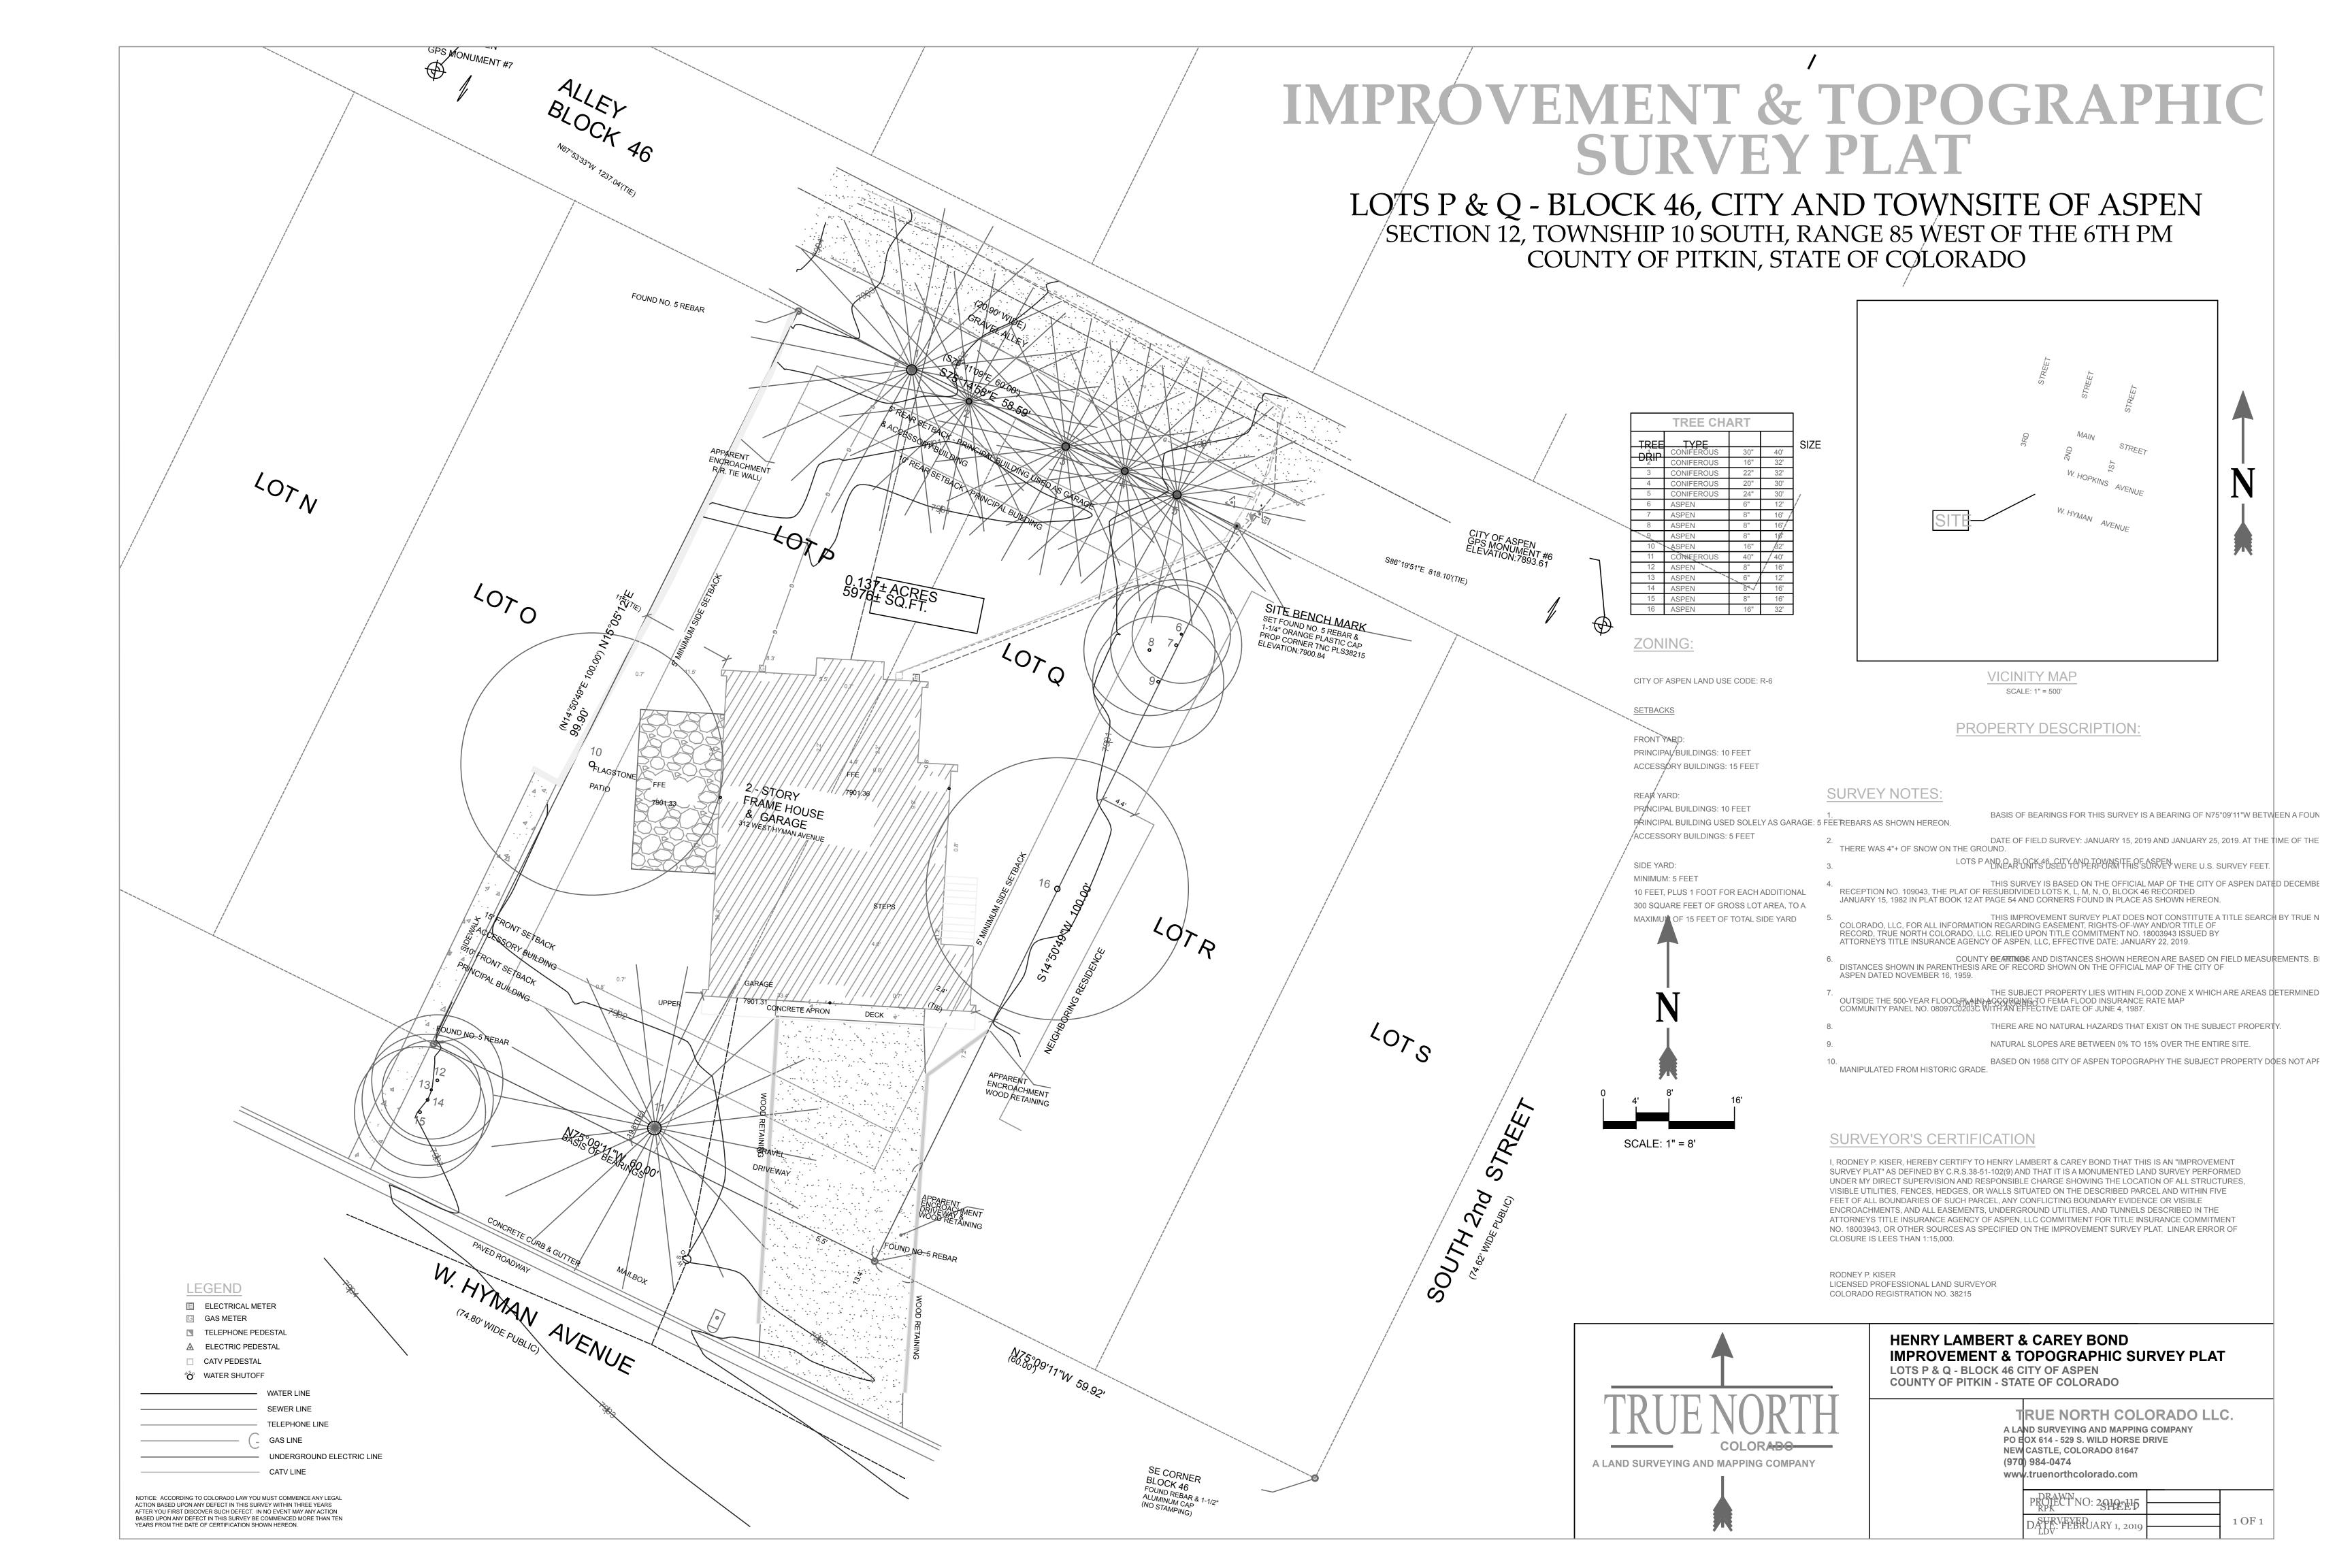

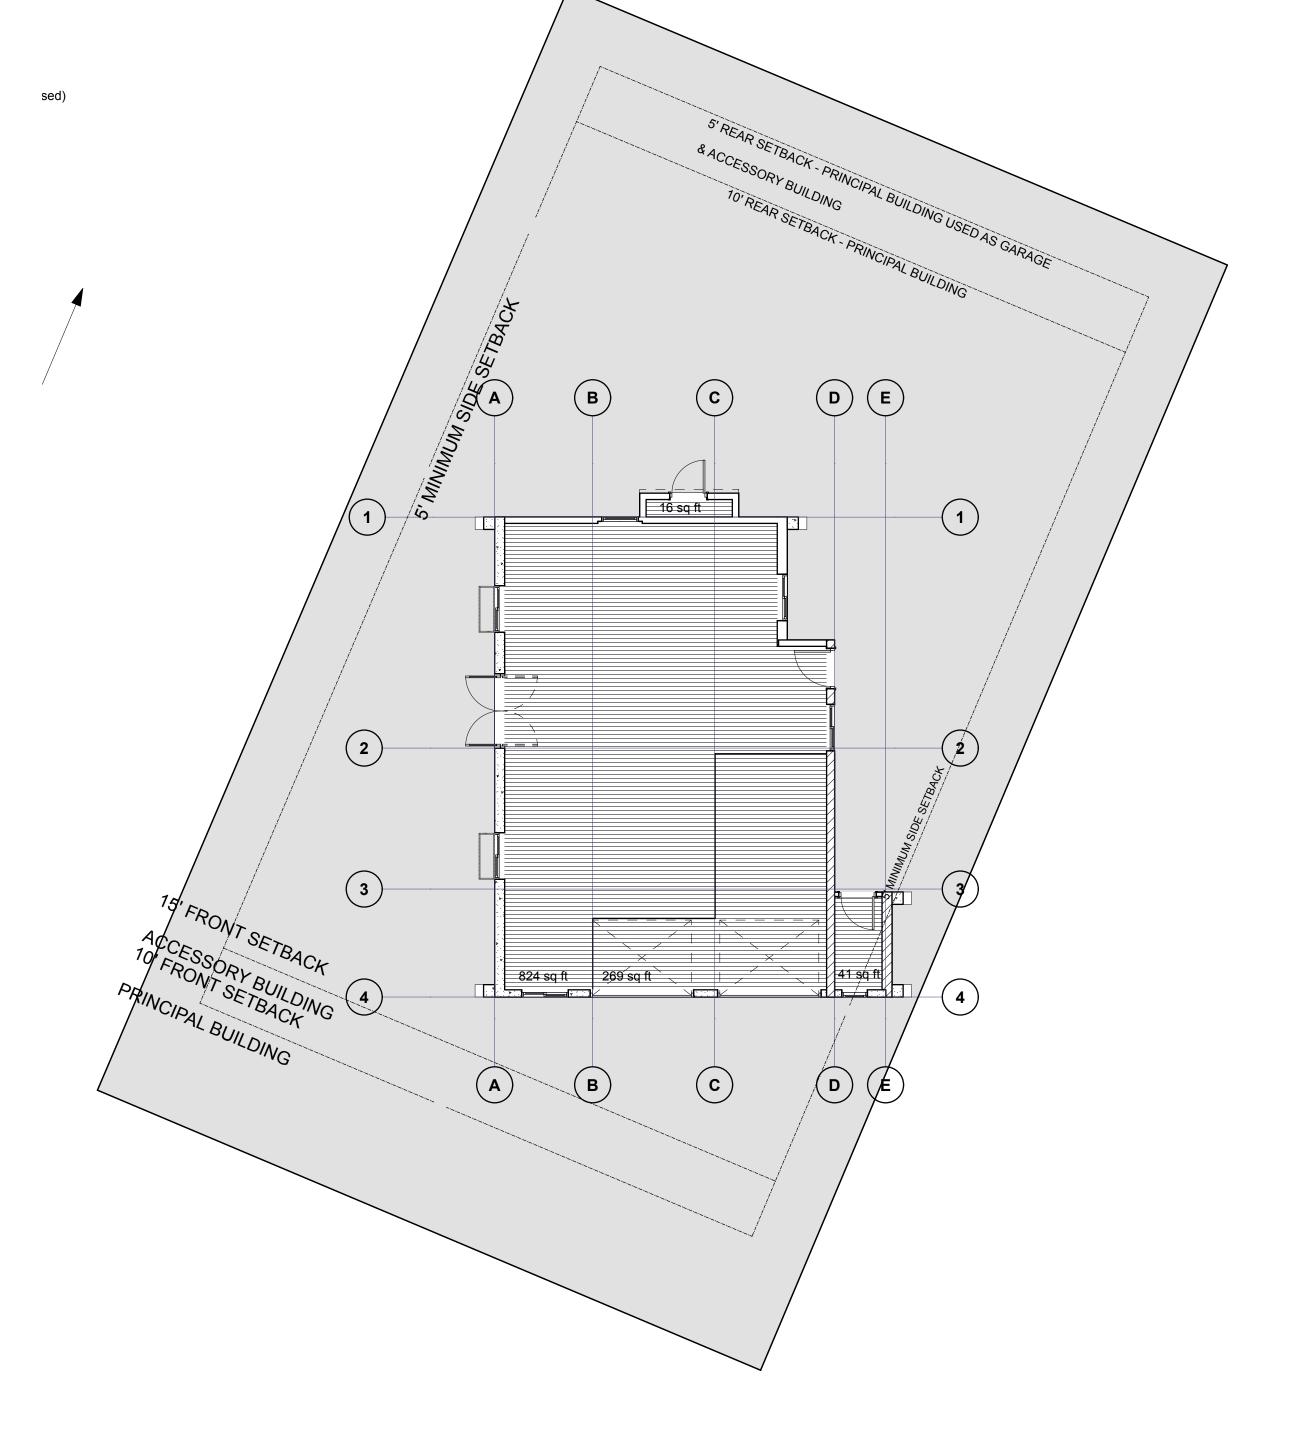

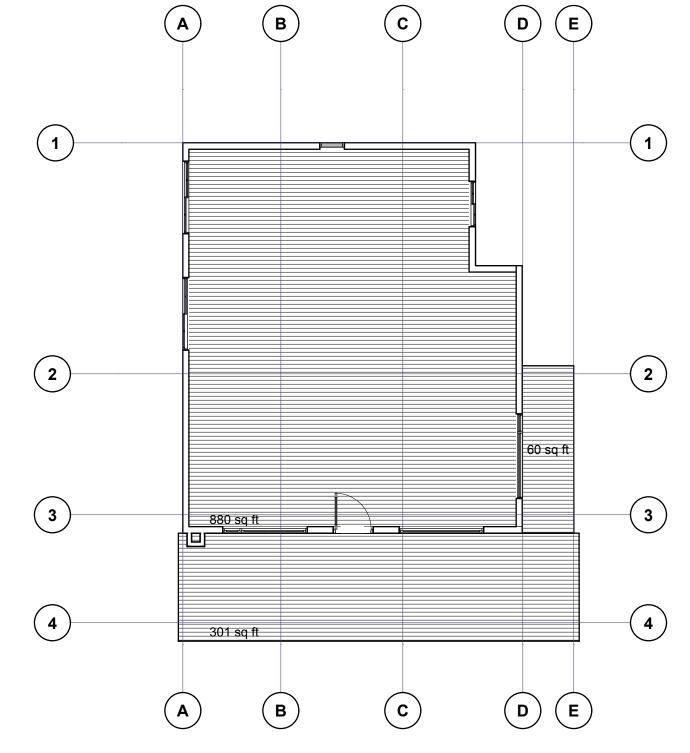


N


Z001

Existing Main Level Floor Area

SCALE: 1/8" = 1'-0"

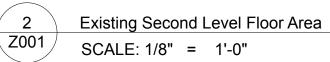

Floor Area Calculations				
City of Aspen 312 W Hyman Zoning Submissio	n			
Existing Main Level Floor Area Calculations				
Main Level Gross Floor Area (Sq Ft)	824	Garage is 269 Sq Ft, attached		
Main Level Countable Floor Area (Sq Ft)	1,091			
Existing Deck/Porch Floor Area Calculations	301	Exempt per 26.575.020.D5, Structural Stairs 60 Sq Ft		
Front Porch Gross Floor Area (Sq Ft)	301	Exempt per 15% of allowable, 15% of 3,240 = 486		
Deck/Porch Countable Floor Area (Sq Ft)	0			
Total Existing Floor Area Calculations				
Sub-grade Floor Area (Sq Ft)	0			
Lower Level Floor Area (Sq Ft)	880			
Main Level Floor Area (Sq Ft)	789	Subtracted Stairs at upper level		
Deck/Porch Floor Area (Sq Ft)	0			
Total Existing Floor Area (Sq Ft	1,669			

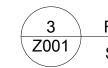

Floor Area Calculations Spring 2023

SCALE: 1' = 1'-0"

cloud hill design, llc

Jeffrey H. Woodruff AIA, NCARB, LEED AP Cloud Hill Design, LLC Snowmass CO 81654 USA

INTEGRATED DESIGN TEAM
Civil Grading and Drainage
Jay Engstrom, P.E.
Crystal River Civil, LLC

Landscape Architect Jennifer M. Dolecki-Smith, RLA Escape Garden Design, LLC

Structural Engineer Brian Rossiter, P.E. bwr.pe

Contractor Adam Rothberg Rothberg Development



312 W Hyman Ave Lots P+Q,

Block 46 Aspen CO 81611 USA/ Pitkin County UGB, City of Aspen

312 W Hyman Ave Aspen CO 81611 USA

Powder Day Skiiing, LLC, David A Tarrab Mees

Account # R000145 Parcel ID # 273512464006

08/22/21 COA- HPO Site Visit

04/27/22 COA- HPC Conceptual II

02/26/22 COA- HPC Conceptual I

07/27/22 COA- HPC Final

10/12/22 COA- City Council Call Up

04/12/23 COA- HPC Substantial

06/28/23 COA- Permit Submittal

07/29/24 COA- Building comments, #4

PROJECT NO: Project No. 116

MODEL FILE: 312_W_Hyman_07292024.pln

DRAWN BY: Jeffrey H Woodruff COPYRIGHT:

SHEET TITLE


Floor Area Calculations


Z001


Existing main level is 880'. New main level is 952 SF (north addition)

Existing main level is 824' + 264' garage (attached)

New main level is 1227' (garage converted to habitable space + north addition, garage exempt and detached)

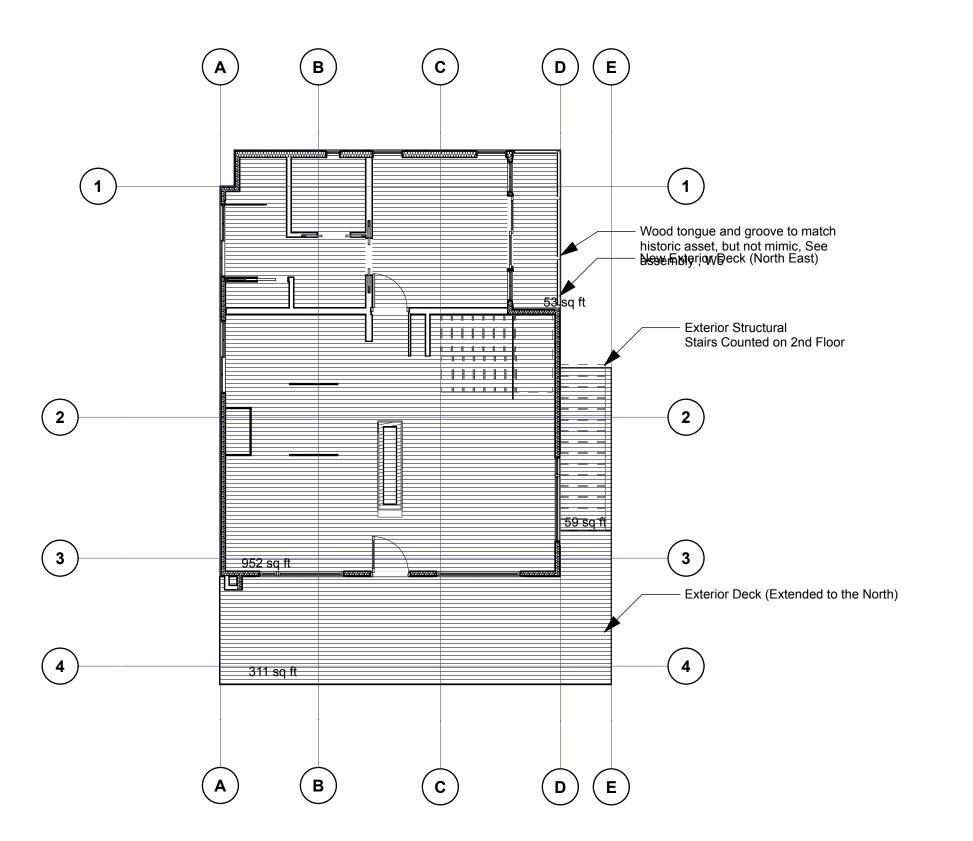

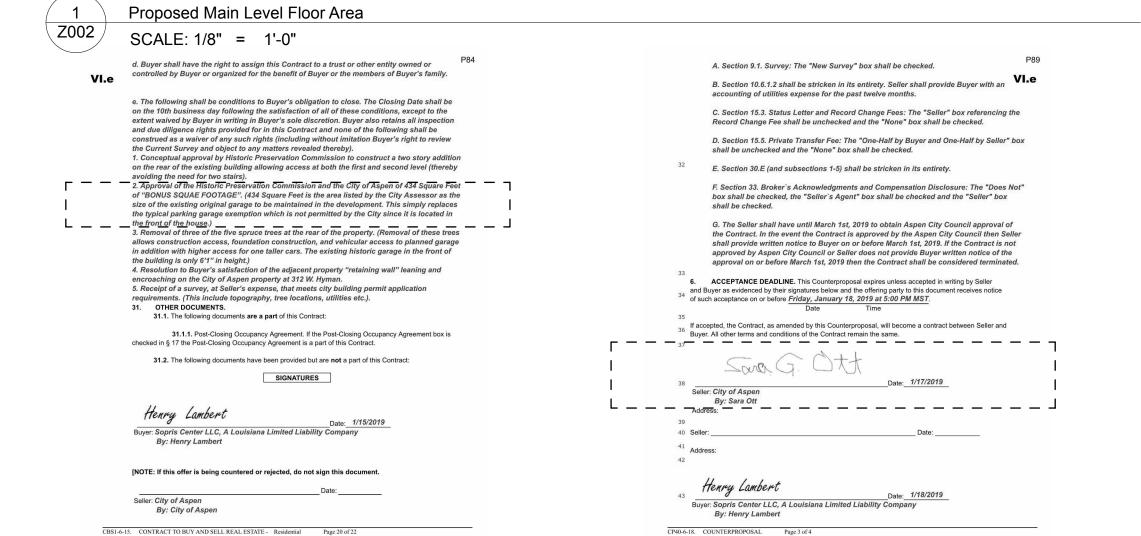

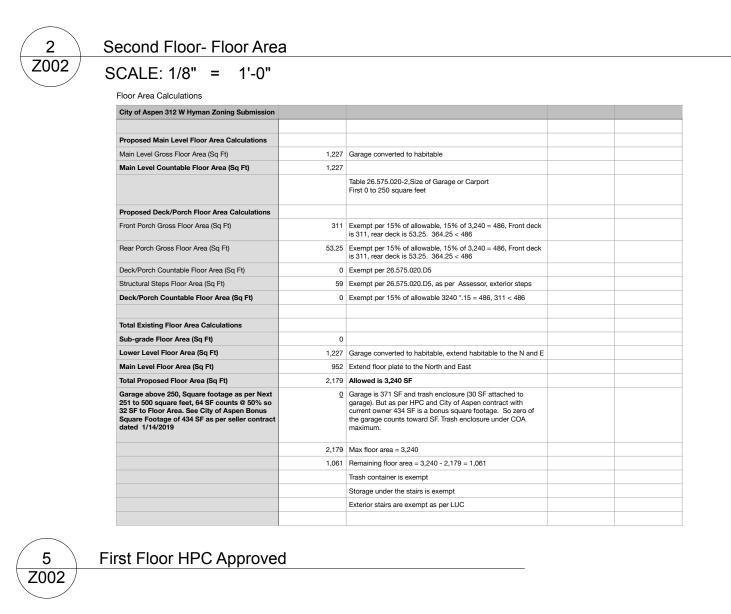

cloud hill design, llc

Jeffrey H. Woodruff AIA, NCARB, LEED AP Cloud Hill Design, LLC Snowmass CO 81654 USA

INTEGRATED DESIGN TEAM
Civil Grading and Drainage
Jay Engstrom, P.E.
Crystal River Civil, LLC

Landscape Architect
Jennifer M. Dolecki-Smith, RLA
Escape Garden Design, LLC
Structural Engineer
Brian Rossiter, P.E.
bwr.pe

Contractor Adam Rothberg Rothberg Development



312 W Hyman Ave Lots P+Q,

Block 46 Aspen CO 81611 USA/ Pitkin County UGB, City of Aspen

312 W Hyman Ave Aspen CO 81611 USA

Powder Day Skiiing, LLC, David A

Account # R000145 Parcel ID # 273512464006

08/22/21 COA- HPO Site Visit

·

02/26/22 COA- HPC Conceptual I

04/27/22 COA- HPC Conceptual II

07/27/22 COA- HPC Final

10/12/22 COA- City Council Call Up

04/12/23 COA- HPC Substantial

06/28/23 COA- Permit Submittal

07/29/24 COA- Building comments, #4

PROJECT NO: Project No. 116
MODEL FILE:

312_W_Hyman_07292024.pln

DRAWN BY: Jeffrey H Woodruff

COPYRIGHT:

SHEET TITLE

Floor Area Calculations

Z002

SHEET 27

Z002 ag

CTMeContracts.com - ©2019 CTM Software Corp.

agenda.council.regular.20190225 copy pages 65 - 90 page 20

agenda.council.regular.20190225 copy pages 65 - 90 page 25




INTEGRATED DESIGN TEAM
Civil Grading and Drainage
Jay Engstrom, P.E.
Crystal River Civil, LLC

Landscape Architect
Jennifer M. Dolecki-Smith, RLA
Escape Garden Design, LLC

Structural Engineer
Brian Rossiter, P.E.
bwr.pe

Contractor Adam Rothberg Rothberg Development

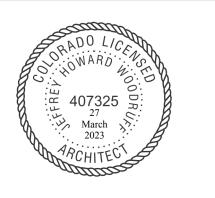

312 W Hyman Ave 312 W Hyman Ave Lots P+Q,

Block 46 Aspen CO 81611 USA/ Pitkin County UGB, City of Aspen

312 W Hyman Ave Aspen CO 81611 USA

Powder Day Skiiing, LLC, David A Tarrab Mees

Account # R000145 Parcel ID # 273512464006

08/22/21 COA- HPO Site Visit

02/26/22 COA- HPC Conceptual I

04/27/22 COA- HPC Conceptual II

07/27/22 COA- HPC Final

10/12/22 COA- City Council Call Up

04/12/23 COA- HPC Substantial

06/28/23 COA- Permit Submittal

07/29/24 COA- Building comments, #4

PROJECT NO: Project No. 116

MODEL FILE:

312_W_Hyman_07292024.pln

DRAWN BY: Jeffrey H Woodruff

COPYRIGHT:

SHEET TITLE

Height Measurements

Z003

SHEET 28


West Elevation Height


SCALE: 1/4" = 1'-0"


Wall Demolition				
Wall Label	Individual Wall Area (Sq Ft)	Area Reduced or Fenestration (Sq Ft)	Area of Wall to be Removed (Sq Ft)	
A- North Wall	535	69	390	
B- North Wall	39	24	15	
C- East Wall	95	10	85	
D- East Wall	20	0	20	
E- East Wall	72	11	61	
F- East Wall	456	67	0	
G- South Wall	598	194	0	
I- West Wall	647	111	67	
Roof Demolition (Area of Roof for two Skylights)	1295	0	22	
Wall Surface Area Total (Sq Ft)	3757			
Area Reduced for Fenestration (Sq Ft)		486		
Area Used for Demo Calculation			660	
Demolition Totals				
Roof and Wall Area Used for Demo Calculation (Sq Ft)			660	
Surface Area to be Removed (Sq Ft)				
Total			660	


Exposed Wall Legend

Existing Wall to Remain Wall Area to be Removed Area Reduced for Fenestration

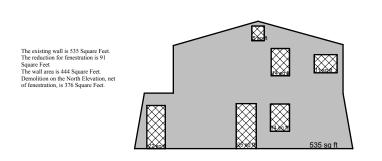


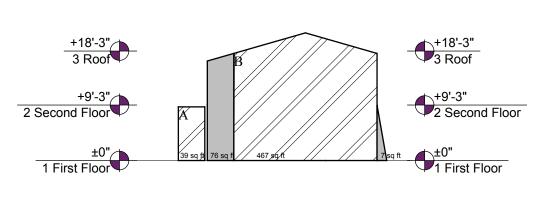


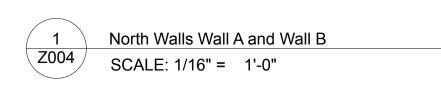

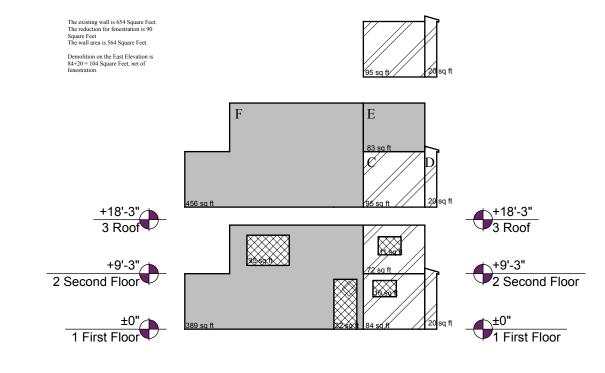


East Walls Wall C and Wall D and Wall E SCALE: 1/16" = 1'-0"

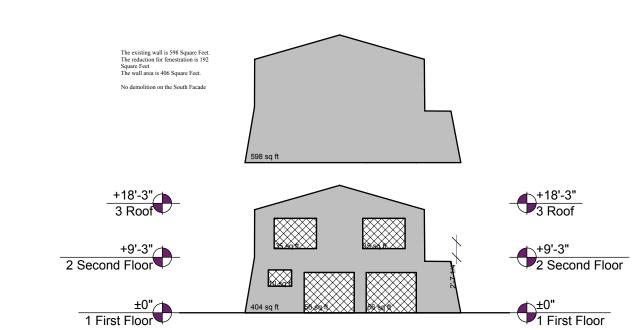

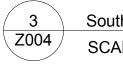

South Walls G SCALE: 1/16" = 1'-0"

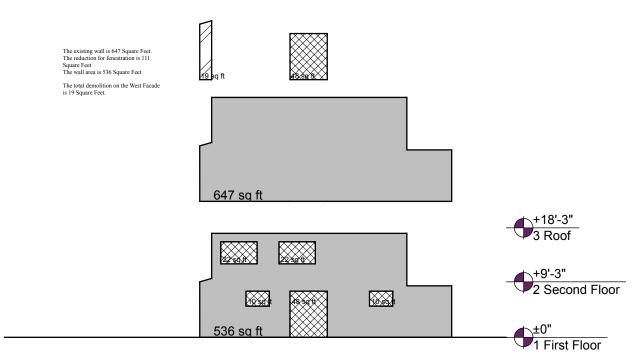

West Wall I SCALE: 1/16" = 1'-0"


cloud hill design. Ilc

Jeffrey H. Woodruff AIA, NCARB, LEED AP Cloud Hill Design, LLC Snowmass CO 81654 USA

INTEGRATED DESIGN TEAM Civil Grading and Drainage Jay Engstrom, P.E. Crystal River Civil, LLC

Landscape Architect Jennifer M. Dolecki-Smith, RLA Escape Garden Design, LLC Structural Engineer Brian Rossiter, P.E. bwr.pe

Contractor Adam Rothberg Rothberg Development

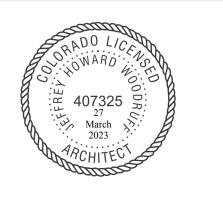

312 W Hyman Ave 312 W Hyman Ave Lots P+Q, Block 46 Aspen CO 81611 USA/ Pitkin County UGB, City of Aspen

312 W Hyman Ave Aspen CO 81611 USA

Powder Day Skiiing, LLC, David A Tarrab Mees

Account # R000145 Parcel ID # 273512464006

08/22/21 COA- HPO Site Visit

02/26/22 COA- HPC Conceptual I 04/27/22 COA- HPC Conceptual II

07/27/22 COA- HPC Final

10/12/22 COA- City Council Call Up

04/12/23 COA- HPC Substantial

06/28/23 COA- Permit Submittal

07/29/24 COA- Building comments, #4

PROJECT NO: Project No. 116 MODEL FILE:


312_W_Hyman_07292024.pln DRAWN BY: Jeffrey H Woodruff COPYRIGHT:

SHEET TITLE

Wall Demolition Calculations


Z004

SHEET 29

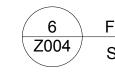


Floor Area Calculations Spring 2023

SCALE: 1' = 1'-0"

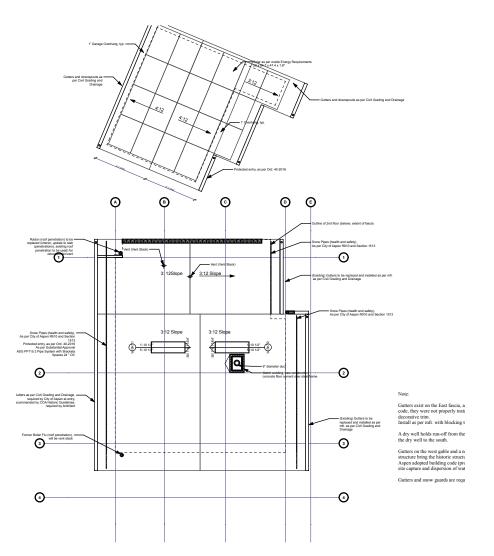

Roof- Plan Shows Demo of Roof for Skylights as per table SCALE: 1/16" = 1'-0"

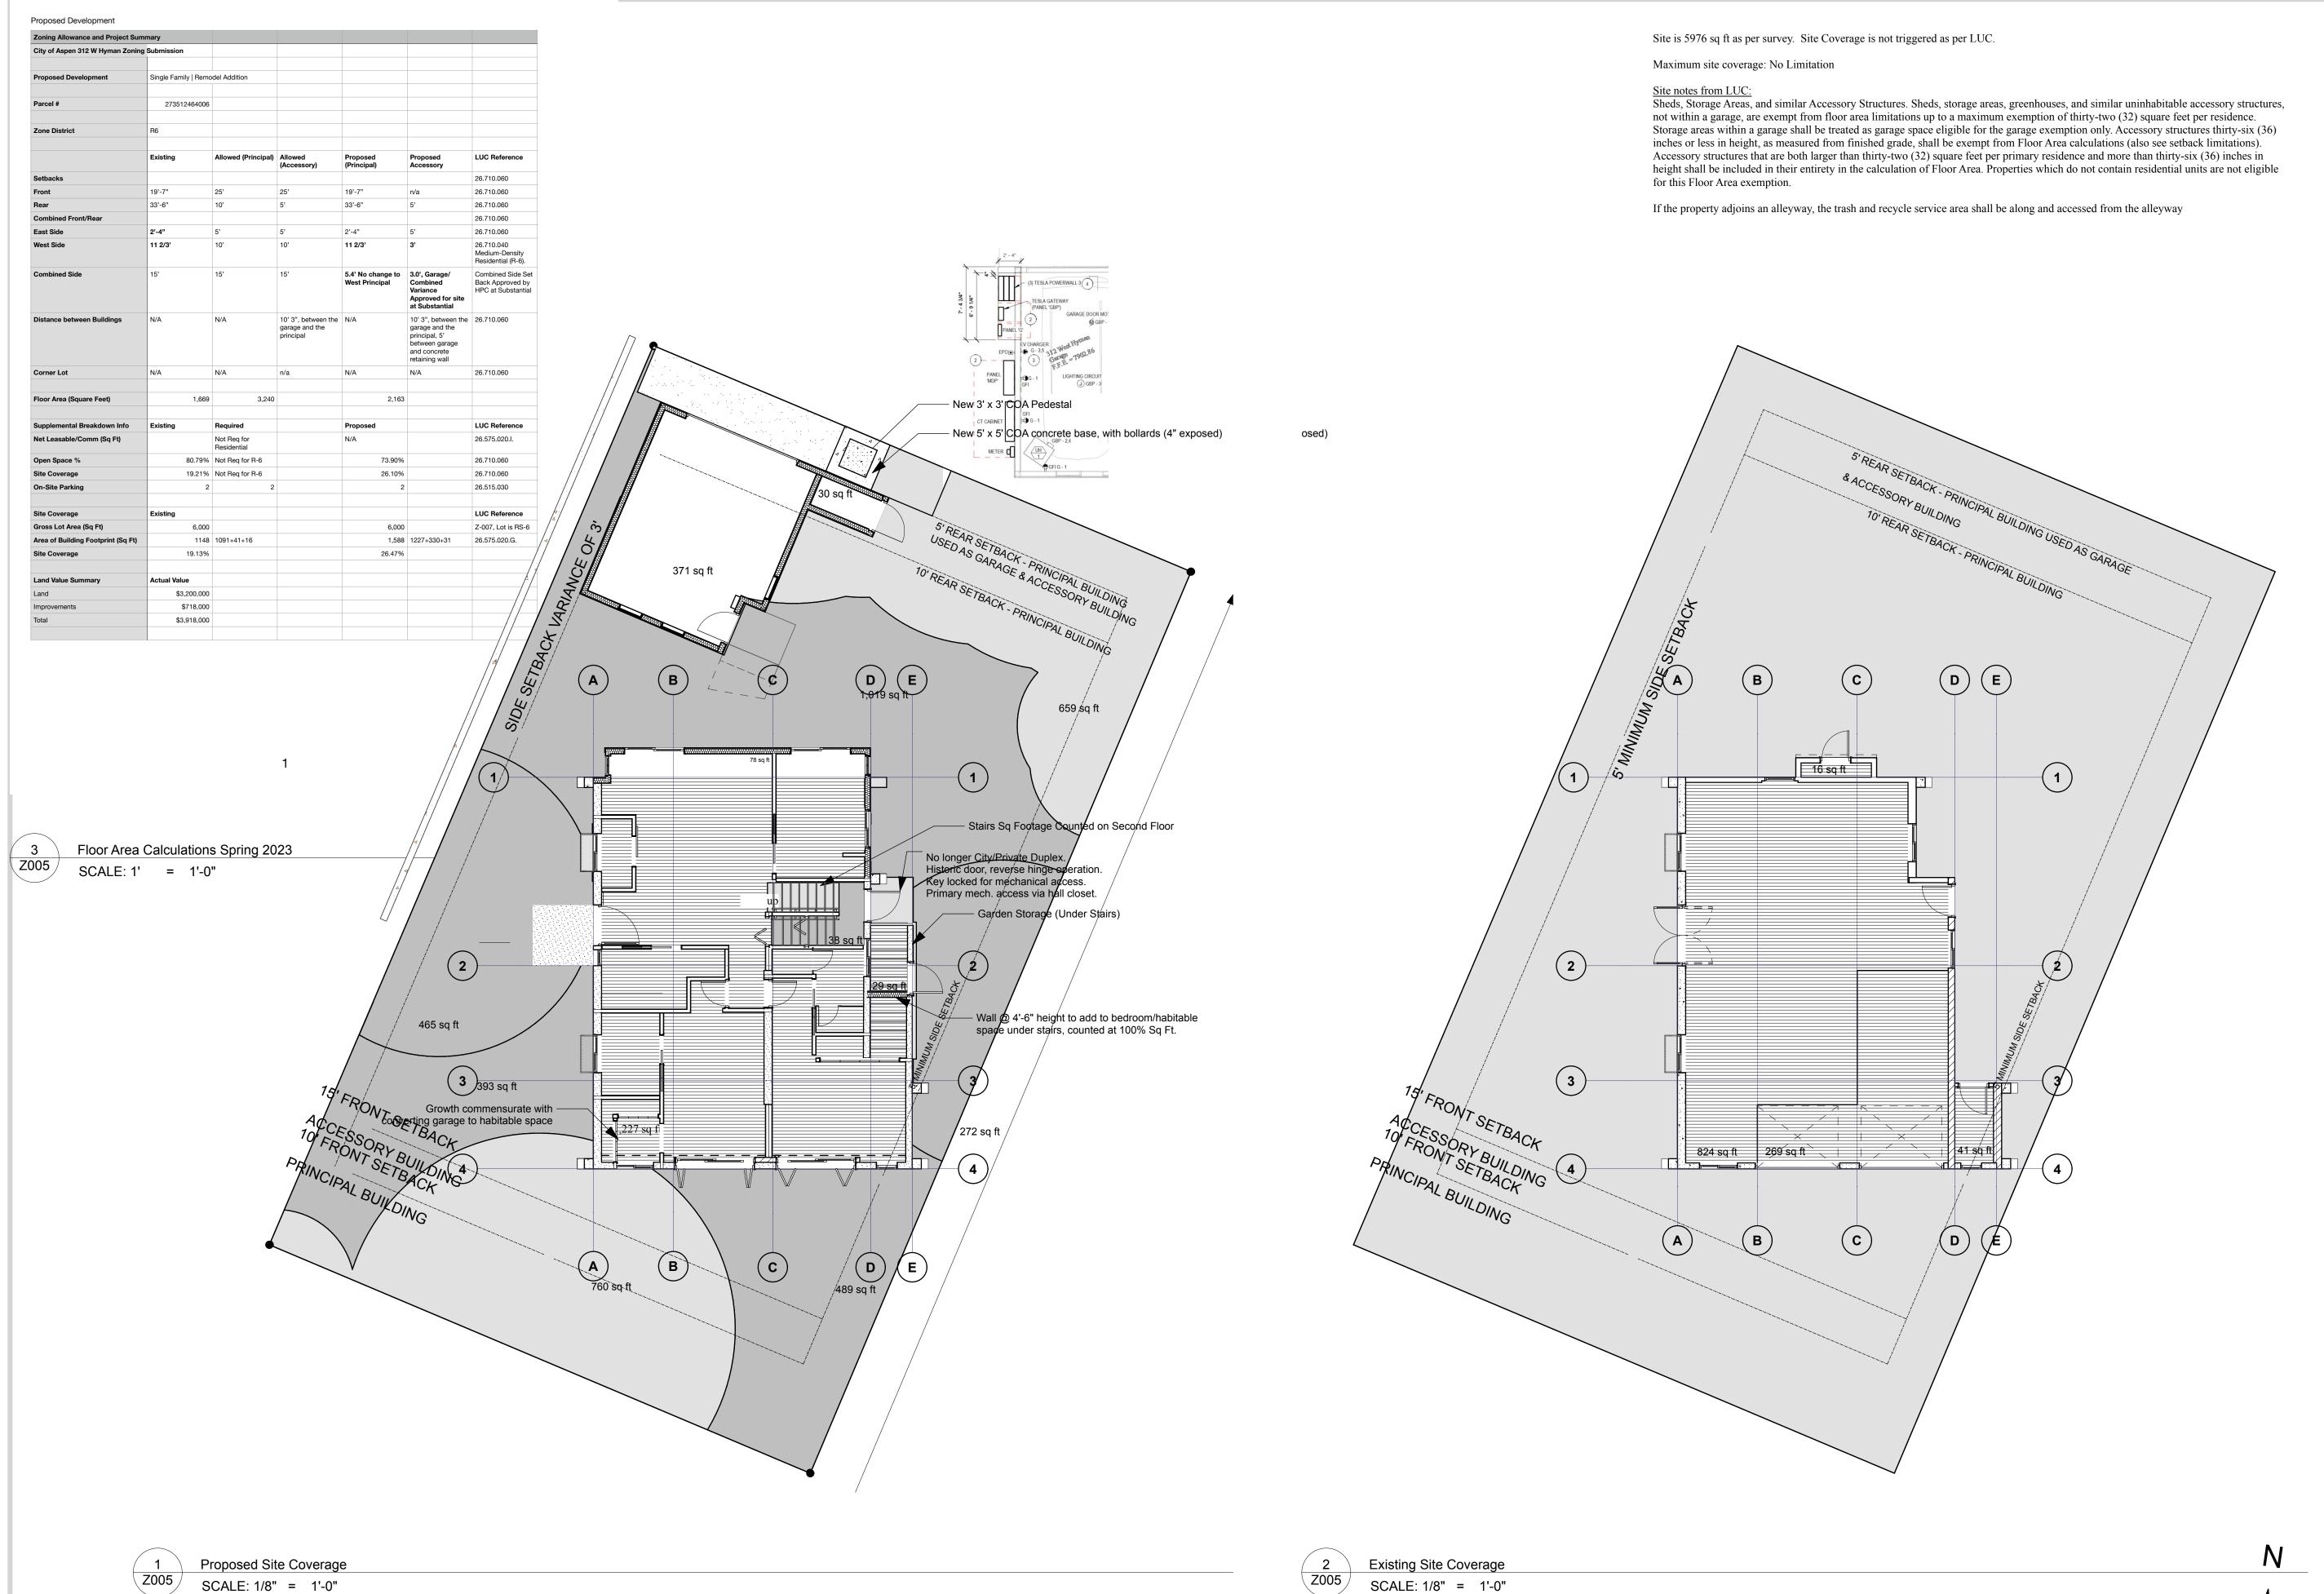



INTEGRATED DESIGN TEAM

Civil Grading and Drainage Jay Engstrom, P.E. Crystal River Civil, LLC

Landscape Architect Jennifer M. Dolecki-Smith, RLA Escape Garden Design, LLC

Structural Engineer Brian Rossiter, P.E. bwr.pe

Contractor Adam Rothberg Rothberg Development



312 W Hyman Ave 312 W Hyman Ave Lots P+Q,

312 W Hyman Ave Lots P+Q, Block 46 Aspen CO 81611 USA/ Pitkin County UGB, City of Aspen

312 W Hyman Ave Aspen CO 81611 USA

Powder Day Skiiing, LLC, David A Tarrab Mees

Account # R000145 Parcel ID # 273512464006

08/22/21 COA- HPO Site Visit

04/27/22 COA- HPC Conceptual II

02/26/22 COA- HPC Conceptual I

07/27/22 COA- HPC Final

10/12/22 COA- City Council Call Up

04/12/23 COA- HPC Substantial

06/28/23 COA- Permit Submittal

07/29/24 COA- Building comments, #4

PROJECT NO: Project No. 116

MODEL FILE: 312_W_Hyman_07292024.pln

DRAWN BY: Jeffrey H Woodruff COPYRIGHT:

SHEET TITLE

Site Coverage

Z005

cloud hill design. Ilc

Jeffrey H. Woodruff AIA, NCARB, LEED AP Cloud Hill Design, LLC Snowmass CO 81654 USA


INTEGRATED DESIGN TEAM
Civil Grading and Drainage

Civil Grading and Drainage Jay Engstrom, P.E. Crystal River Civil, LLC

Landscape Architect Jennifer M. Dolecki-Smith, RLA Escape Garden Design, LLC

Structural Engineer Brian Rossiter, P.E. bwr.pe

Contractor Adam Rothberg Rothberg Development

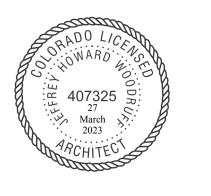

312 W Hyman Ave Lots P+Q, Block 46 Aspen CO 81611 USA/

Pitkin County UGB, City of Aspen

312 W Hyman Ave Aspen CO 81611 USA

Powder Day Skiiing, LLC, David A Tarrab Mees

Account # R000145 Parcel ID # 273512464006

08/22/21 COA- HPO Site Visit

02/26/22 COA- HPC Conceptual I

04/27/22 COA- HPC Conceptual II

07/27/22 COA- HPC Final

10/12/22 COA- City Council Call Up

04/12/23 COA- HPC Substantial

07/29/24 COA- Building comments, #4

06/28/23 COA- Permit Submittal

PROJECT NO: Project No. 116

MODEL FILE: 312_W_Hyman_07292024.pln

DRAWN BY: Jeffrey H Woodruff
COPYRIGHT:

SHEET TITLE

Zoning Summary

Z006

SHEET 31

Proposed Development

Zoning Allowance and Project Summary City of Aspen 312 W Hyman Zoning Submission Single Family | Remodel Addition **Proposed Development** 273512464006 Parcel # R6 **Zone District** Existing Allowed (Principal) Allowed Proposed Proposed **LUC Reference** (Principal) Accessory (Accessory) 26.710.060 Setbacks 19'-7" 25' 25' 19'-7" n/a 26.710.060 Front 33'-6" 10' 33'-6" 5' 26.710.060 26.710.060 **Combined Front/Rear** 26.710.060 2'-4" **East Side** 2'-4" 11 2/3' 11 2/3' 26.710.040 **West Side** Medium-Density Residential (R-6). 5.4' No change to 3.0', Garage/ Combined Side Set **Combined Side** 15' 15' Combined West Principal Back Approved by HPC at Substantial Variance Approved for site at Substantial 10' 3", between the N/A 10' 3", between the 26.710.060 Distance between Buildings N/A N/A garage and the garage and the principal, 5' principal between garage and concrete retaining wall N/A N/A 26.710.060 **Corner Lot** N/A n/a N/A 1,669 3,240 2,179 Floor Area (Square Feet) Existing Proposed **Supplemental Breakdown Info** Required **LUC Reference** Net Leasable/Comm (Sq Ft) Not Req for N/A 26.575.020.I. Residential Open Space % 80.79% Not Req for R-6 73.90% 26.710.060 19.21% Not Req for R-6 26.10% 26.710.060 **Site Coverage On-Site Parking** 26.515.030 2 **LUC Reference Site Coverage** Existing Gross Lot Area (Sq Ft) 6,000 6,000 Z-007, Lot is RS-6 Area of Building Footprint (Sq Ft) 1148 1091+41+16 1,588 | 1227+330+31 26.575.020.G. 19.13% 26.47% Site Coverage Actual Value Land Value Summary \$3,200,000 Land \$718,000 Improvements \$3,918,000 Total

RS-6 Site Total 6000 SF

Tree Protection Zone/Pervious Space

680.25 SF North/East Trees South State Tree 760.25 SF Tree Site Coverage 1,440.50 SF Tree Site % 24.01%

Impervious Site Coverage

1210.75 SF Chalet 330.00 SF Garage 32.25 SF Enclosure 1573.00 Build out site Build out site % 26.21%

Pervious Open Space

1020.75 SF 488.75 SF South East 392.75 SF South West 464.75 SF * West Tree 271.75 SF * East Tree 2638.75 Open Space 43.98% Open Space%

Pavers/skirt

~5.80%

* East and West Deciduous trees counted toward open space

North West Garage/Trash Enclosure

^o Aligned with existing site disturbance, the railroad tie retaining wall

° Leaves the largest open space in the backyard ° No/little impact to trees #3, #4 and #5 and no impact to Aspens along East property line

O Does not interfere with existing utilities (maybe gas, but not

^o Benefits to house across alley (north), views to Shadow Mountain

o Minor negative to St Moritz, but ridge line is 12'-6" and grade steps down 3' grade (from the property line to the NE corner of the garage) and 6' retaining wall, so impact is negligible to St Moritz

Obistance between the Garage and the Residence is 11', goes to 12' with the 2.5' side setback

° Keep all trees, gravel between the alley and the garage Obistance between the property line and Tree #1 is 15'-7", if the neighboring retaining wall is plum and does not encroach on the West property line.

cloud hill design. Ilc


Jeffrey H. Woodruff AIA, NCARB, LEED AP Cloud Hill Design, LLC Snowmass CO 81654 USA

INTEGRATED DESIGN TEAM

Civil Grading and Drainage Jay Engstrom, P.E. Crystal River Civil, LLC

Landscape Architect Jennifer M. Dolecki-Smith, RLA Escape Garden Design, LLC Structural Engineer Brian Rossiter, P.E. bwr.pe

Contractor Adam Rothberg Rothberg Development

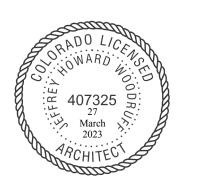

312 W Hyman Ave

312 W Hyman Ave Lots P+Q, Block 46 Aspen CO 81611 USA/ Pitkin County UGB, City of Aspen

312 W Hyman Ave Aspen CO 81611 USA

Powder Day Skiiing, LLC, David A Tarrab Mees

Account # R000145 Parcel ID # 273512464006

08/22/21 COA- HPO Site Visit

02/26/22 COA- HPC Conceptual I

04/27/22 COA- HPC Conceptual II

07/27/22 COA- HPC Final

10/12/22 COA- City Council Call Up

04/12/23 COA- HPC Substantial

06/28/23 COA- Permit Submittal

07/29/24 COA- Building comments, #4

PROJECT NO: Project No. 116

MODEL FILE:

312_W_Hyman_07292024.pln

DRAWN BY: Jeffrey H Woodruff COPYRIGHT:

SHEET TITLE

Forestry Site Coverage

Z008

SHEET 32

First Floor- Tree SCALE: 1/8" = 1'-0"

EXISTING

APPROVED HPC RESO #5 2023

APPROVED BY HPO/S&M 10.18.23



Jeffrey H. Woodruff AIA, NCARB, LEED AP Cloud Hill Design, LLC Snowmass CO 81654 USA

INTEGRATED DESIGN TEAM Civil Grading and Drainage Jay Engstrom, P.E. Crystal River Civil, LLC

Landscape Architect Jennifer M. Dolecki-Smith, RLA Escape Garden Design, LLC

Contractor Adam Rothberg Rothberg Development

Structural Engineer Brian Rossiter, P.E. bwr.pe



312 W Hyman Ave 312 W Hyman Ave Lots P+Q,

Block 46 Aspen CO 81611 USA/ Pitkin County UGB, City of Aspen

312 W Hyman Ave Aspen CO 81611 USA

Powder Day Skiiing, LLC, David A Tarrab Mees

Account # R000145 Parcel ID # 273512464006

08/22/21 COA- HPO Site Visit

02/26/22 COA- HPC Conceptual I

04/27/22 COA- HPC Conceptual II 07/27/22 COA- HPC Final

10/12/22 COA- City Council Call Up

04/12/23 COA- HPC Substantial

06/28/23 COA- Permit Submittal

07/29/24 COA- Building comments, #4

PROJECT NO: Project No. 116


MODEL FILE: 312_W_Hyman_07292024.pln

DRAWN BY: Jeffrey H Woodruff COPYRIGHT:


SHEET TITLE

Existing, HPC Approved, **HPO Approved**


SHEET 33

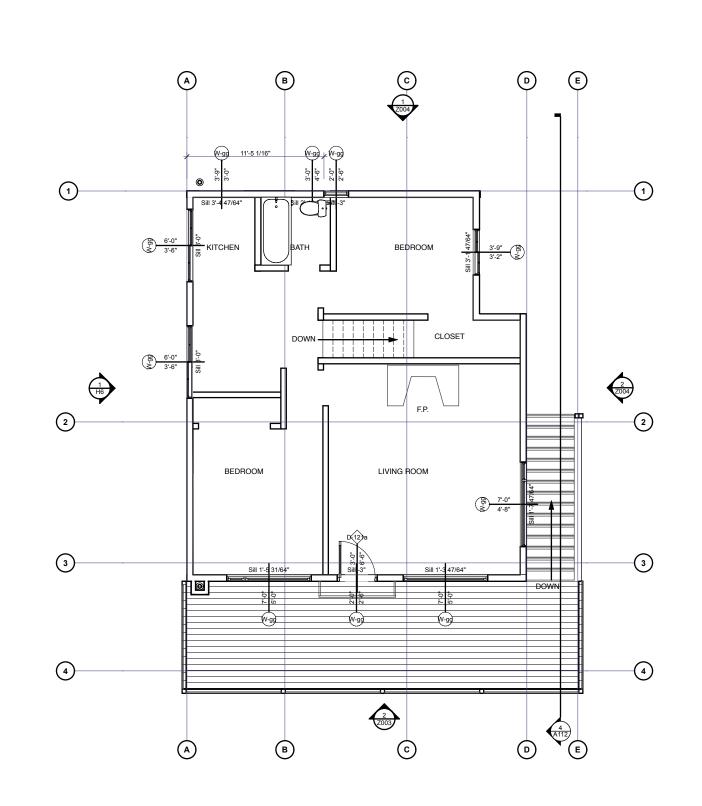


SCALE: 1/8" = 1'-0"

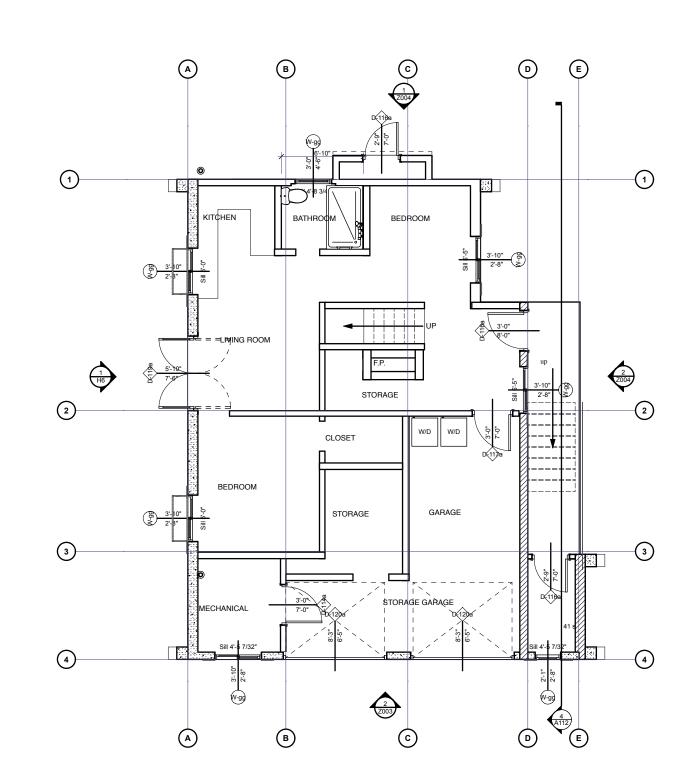


1. First Floor

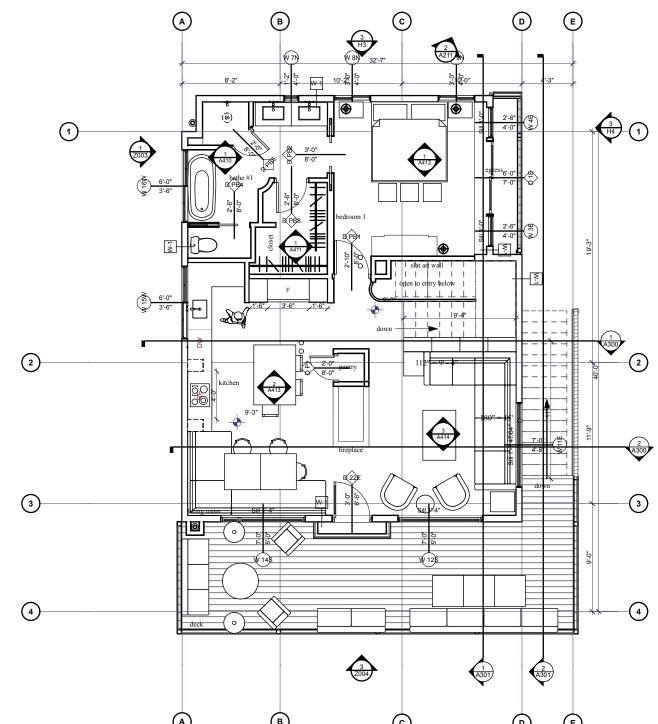

Amendment

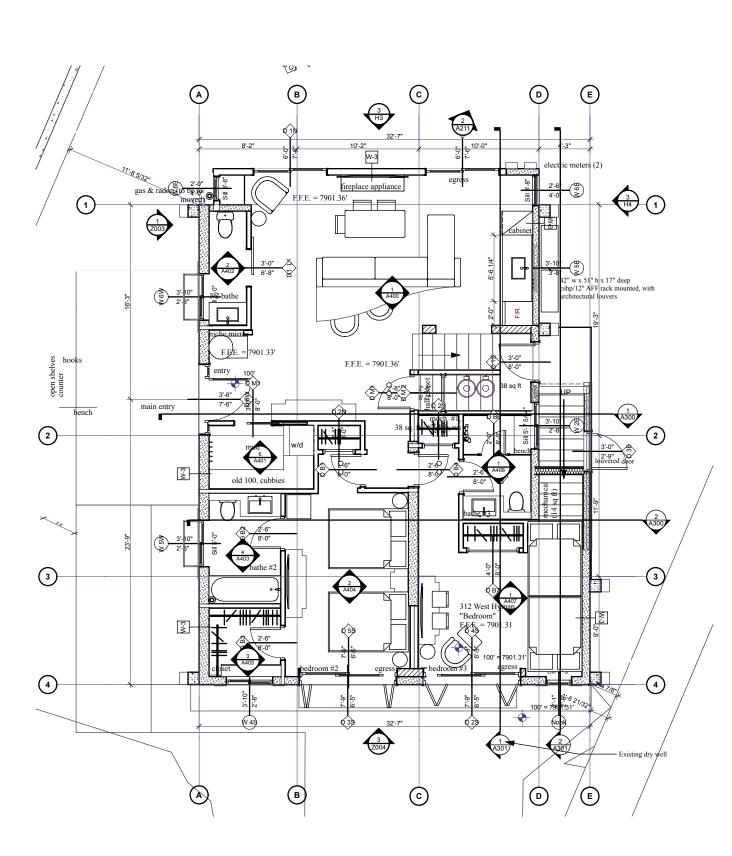

Amendment SCALE: 1/8" = 1'-0"

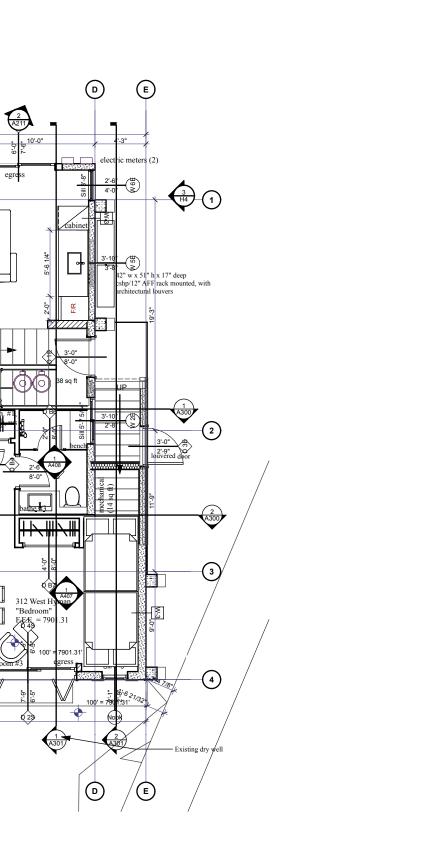

First Floor

2. Second Floor SCALE: 1/8" = 1'-0"

A

В

(D)

hooks now melt, pre wire t with its its solar s serie controller, now the ling mat)

Civil Grading and Drainage Jay Engstrom, P.E. Crystal River Civil, LLC Landscape Architect Jennifer M. Dolecki-Smith, RLA Escape Garden Design, LLC Structural Engineer Brian Rossiter, P.E. bwr.pe

INTEGRATED DESIGN TEAM

Contractor Adam Rothberg Rothberg Development



312 W Hyman Ave
312 W Hyman Ave Lots P+Q,
Block 46 Aspen CO 81611 USA/
Pitkin County UGB, City of Aspen

312 W Hyman Ave Aspen CO 81611 USA

Powder Day Skiiing, LLC, David A Tarrab Mees

Account # R000145 Parcel ID # 273512464006

08/22/21 COA- HPO Site Visit

02/26/22 COA- HPC Conceptual I

04/27/22 COA- HPC Conceptual II

07/27/22 COA- HPC Final

10/12/22 COA- City Council Call Up

04/12/23 COA- HPC Substantial

06/28/23 COA- Permit Submittal

07/29/24 COA- Building comments, #4

PROJECT NO: Project No. 116

MODEL FILE: 312_W_Hyman_07292024.pln DRAWN BY: Jeffrey H Woodruff

SHEET TITLE


COPYRIGHT:

Existing, HPC Approved, **HPO Approved**

H2


SHEET 34

APPROVED HPC RESO #5 2023

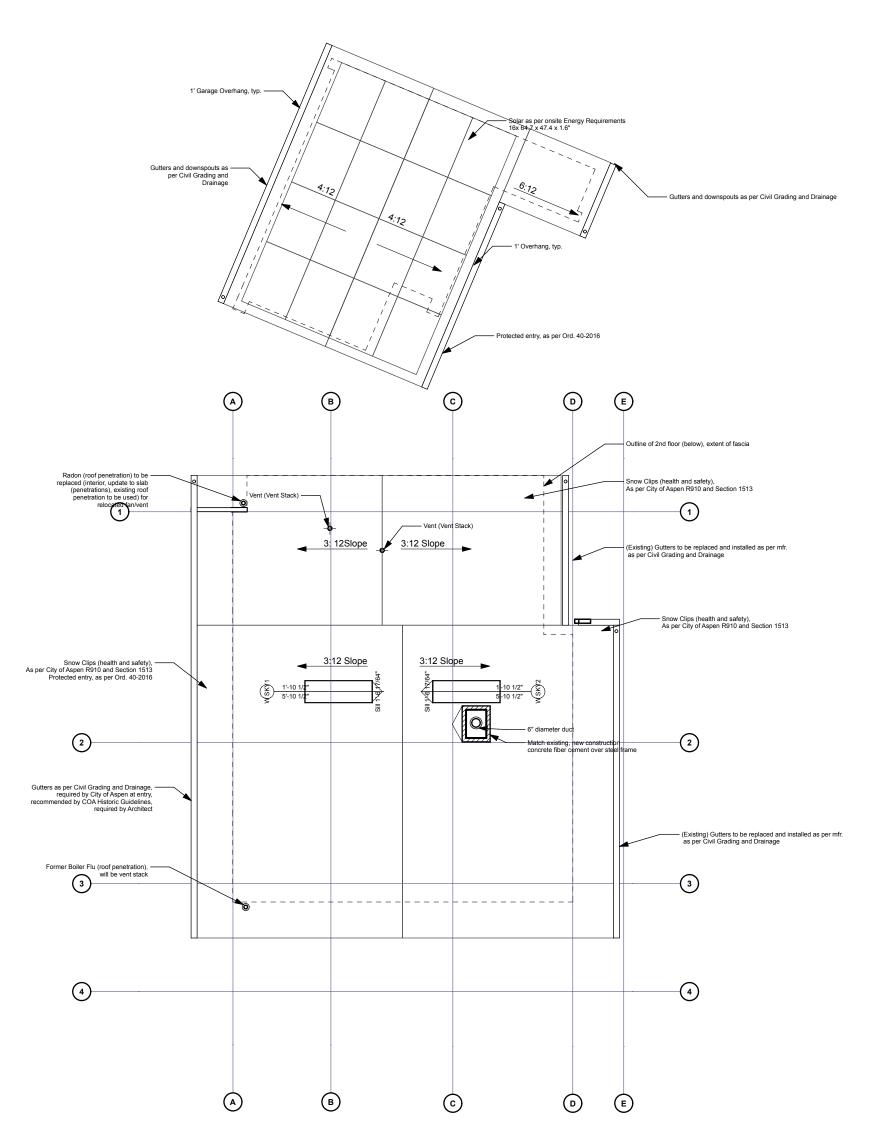

Roof Existing SCALE: 1/8" = 1'-0"

EXISTING

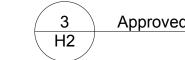

HPO Approved

A


Protected entry, as per Ord. 40-2016
As per Substantial Approval
ASG PP115 2 Pipe System with Brackets
Spaces 24 " OC

Former Boiler Flu (roof penetration), — will be vent stack

APPROVED BY

Gutters and downspouts as —— per Civil Grading and Drainage

HPO/S&M 10.18.23

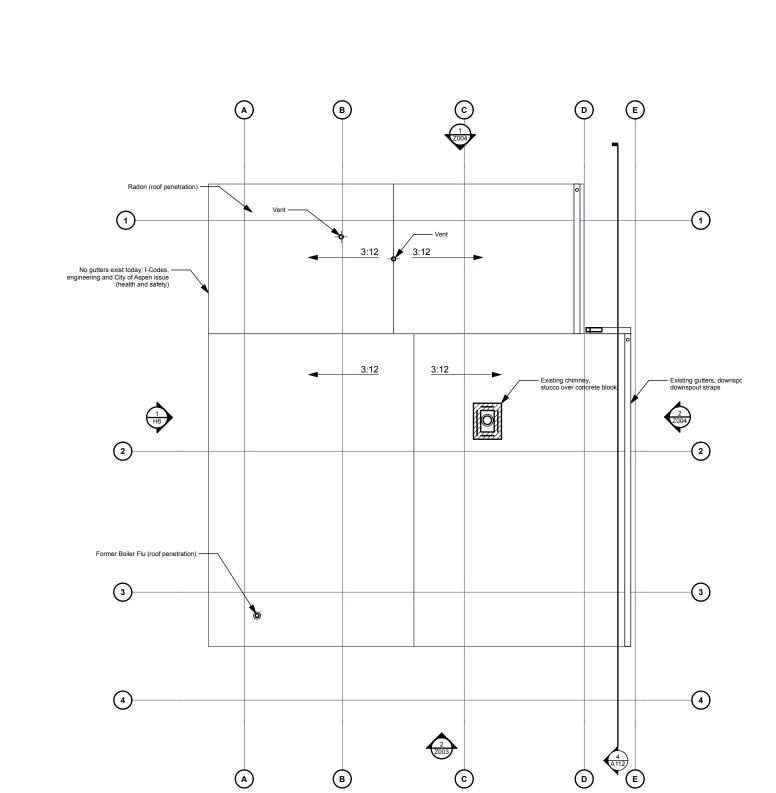


(D) (E)

(

©

3: 12Slope 3:12 Slope

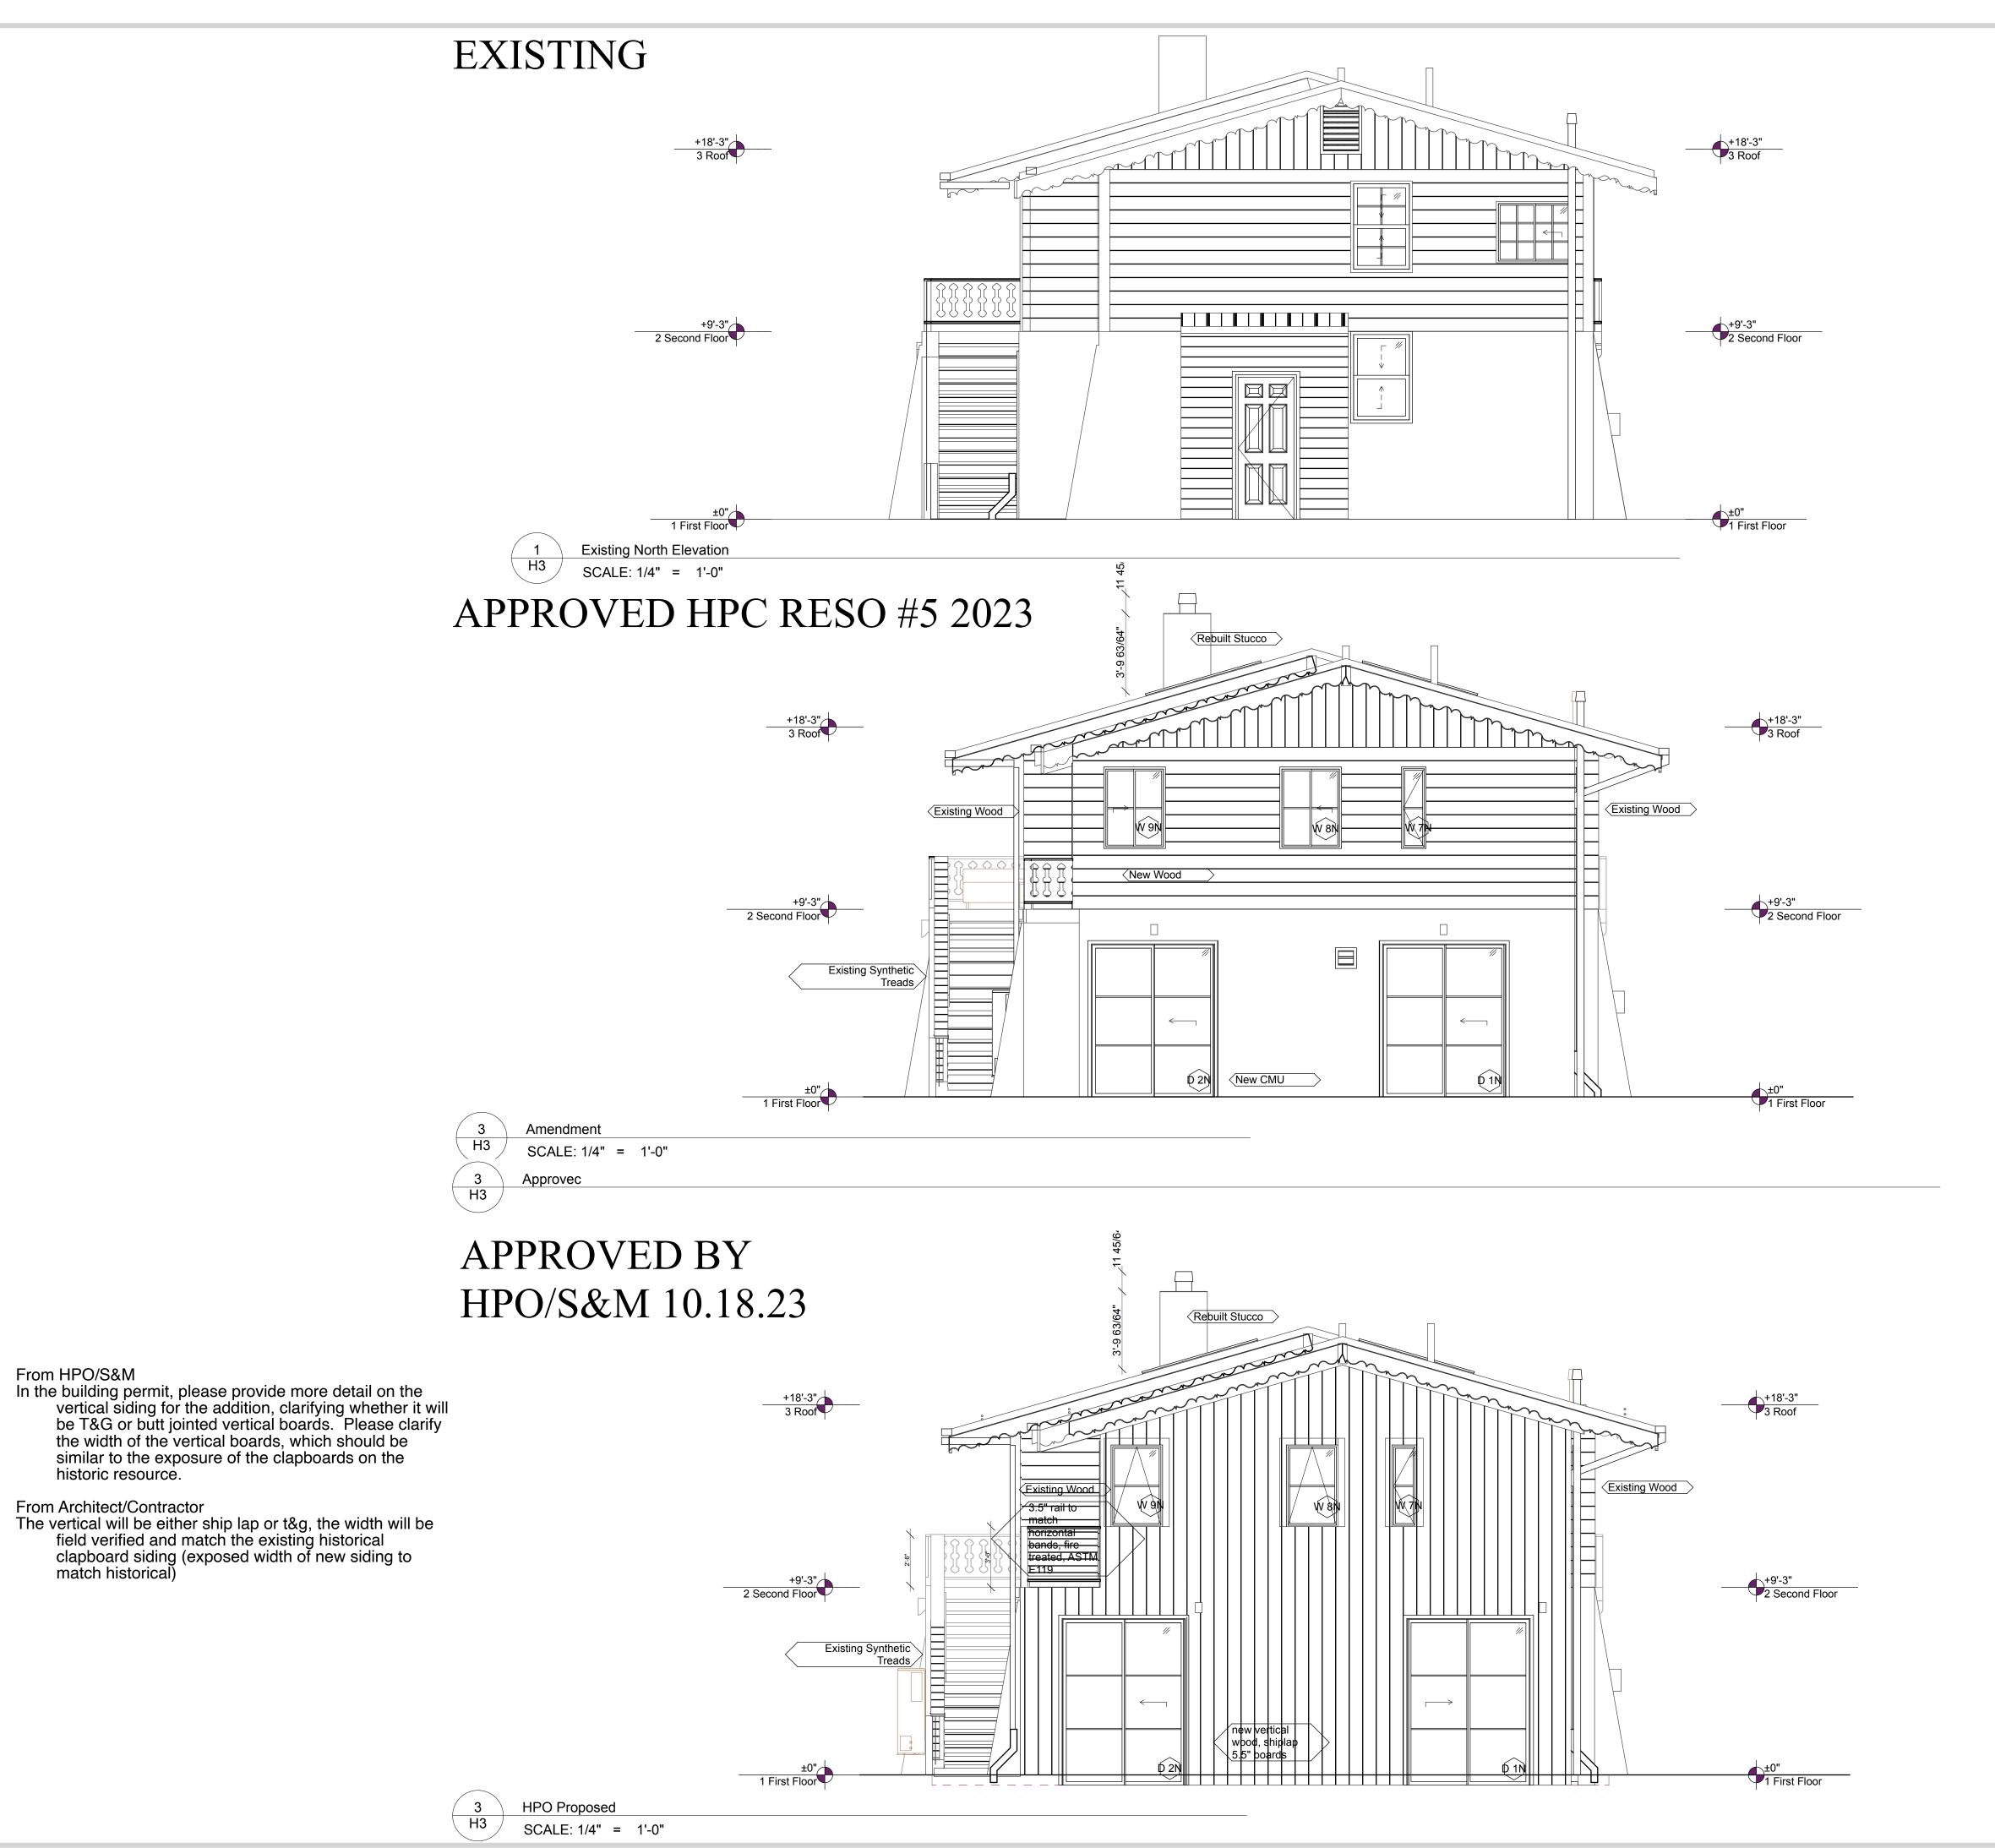

cloud hill design. Ilc

Jeffrey H. Woodruff AIA, NCARB, LEED AP Cloud Hill Design, LLC Snowmass CO 81654 USA

INTEGRATED DESIGN TEAM Civil Grading and Drainage Jay Engstrom, P.E. Crystal River Civil, LLC

Landscape Architect Jennifer M. Dolecki-Smith, RLA Escape Garden Design, LLC

Structural Engineer Brian Rossiter, P.E. bwr.pe

Contractor Adam Rothberg Rothberg Development



312 W Hyman Ave 312 W Hyman Ave Lots P+Q,

Block 46 Aspen CO 81611 USA/ Pitkin County UGB, City of Aspen

312 W Hyman Ave Aspen CO 81611 USA

Powder Day Skiiing, LLC, David A **Tarrab Mees**

> Account # R000145 Parcel ID # 273512464006

08/22/21 COA- HPO Site Visit

02/26/22 COA- HPC Conceptual I

04/27/22 COA- HPC Conceptual II

07/27/22 COA- HPC Final

10/12/22 COA- City Council Call Up

04/12/23 COA- HPC Substantial

06/28/23 COA- Permit Submittal

07/29/24 COA- Building comments, #4

PROJECT NO: Project No. 116 MODEL FILE:

312_W_Hyman_07292024.pln DRAWN BY: Jeffrey H Woodruff COPYRIGHT:

SHEET TITLE

Existing, HPC Approved, **HPO** Approved

H3

SHEET 35

From HPO/S&M

historic resource.


From Architect/Contractor

In the building permit, please clearly detail how historic materials will be retained on the upper level of the northeast façade, while accommodating the doors and windows being added at the new bedroom deck.

Contractor to remove and retain, historical wood from north, east and west facades. architect and contractor to select best historic wood for northeast facade, over new building wrap, after new fenestration installed, etc.

HPO Approved

SCALE: 1/4" = 1'-0"

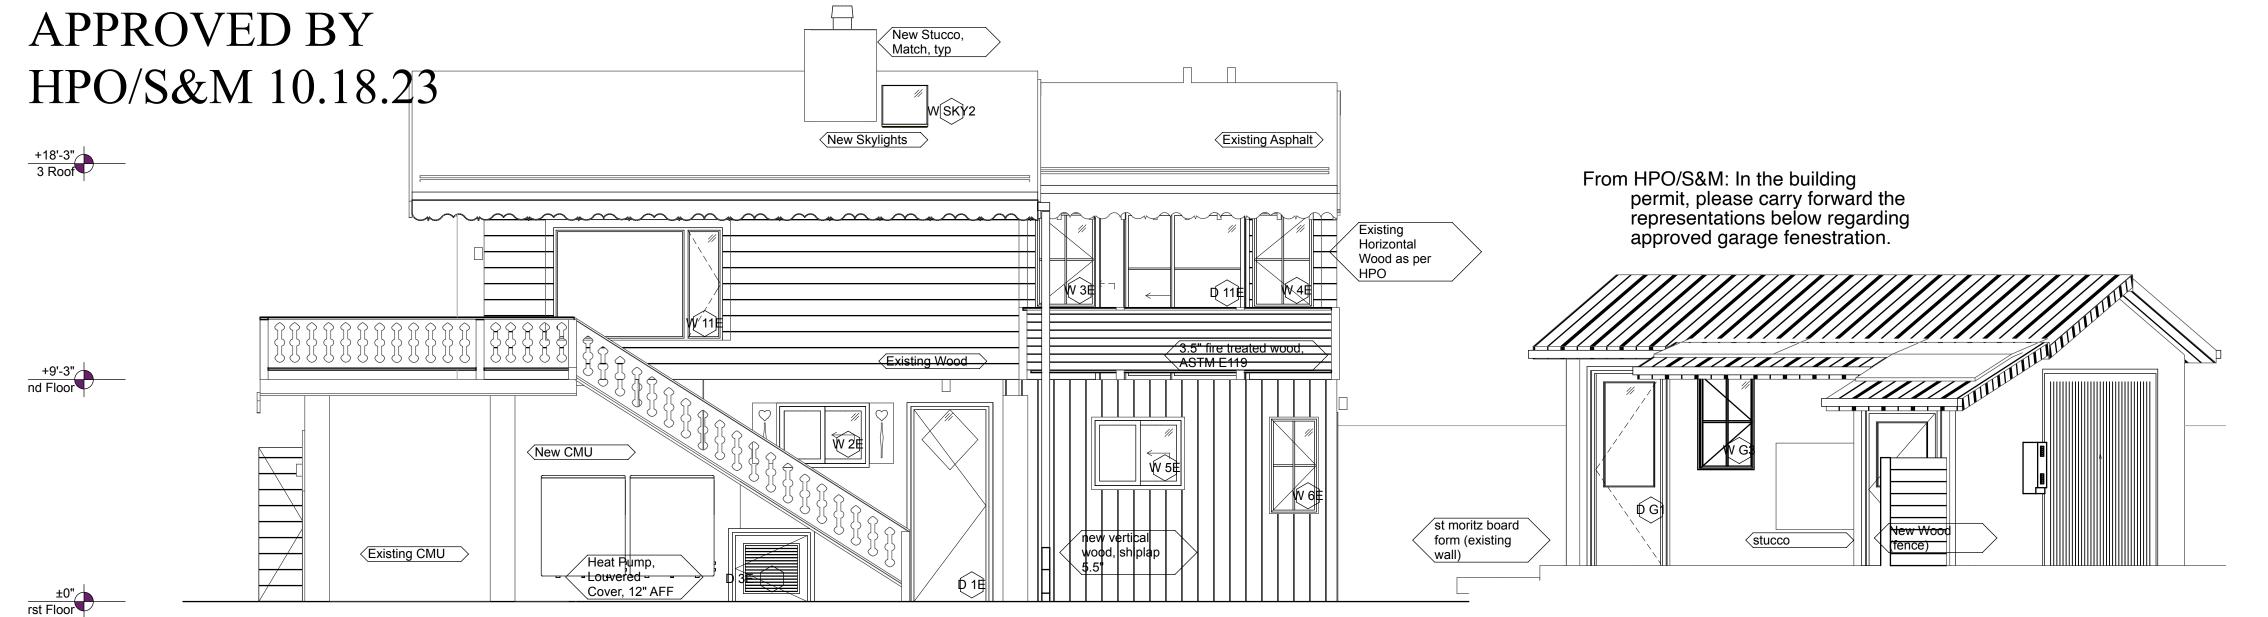



Jeffrey H. Woodruff AIA, NCARB, LEED AP Cloud Hill Design, LLC Snowmass CO 81654 USA

INTEGRATED DESIGN TEAM
Civil Grading and Drainage
Jay Engstrom, P.E.
Crystal River Civil, LLC

Landscape Architect Jennifer M. Dolecki-Smith, RLA Escape Garden Design, LLC

Structural Engineer Brian Rossiter, P.E. bwr.pe

Contractor Adam Rothberg Rothberg Development



312 W Hyman Ave 312 W Hyman Ave Lots P+Q,

312 W Hyman Ave Lots P+Q, Block 46 Aspen CO 81611 USA/ Pitkin County UGB, City of Aspen

312 W Hyman Ave Aspen CO 81611 USA

Powder Day Skiiing, LLC, David A Tarrab Mees

> Account # R000145 Parcel ID # 273512464006

08/22/21 COA- HPO Site Visit

,

02/26/22 COA- HPC Conceptual I

04/27/22 COA- HPC Conceptual II

07/27/22 COA- HPC Final

10/12/22 COA- City Council Call Up

04/12/23 COA- HPC Substantial

06/28/23 COA- Permit Submittal

07/29/24 COA- Building comments, #4

PROJECT NO: Project No. 116

MODEL FILE:
312_W_Hyman_07292024.pln

DRAWN BY: Jeffrey H Woodruff COPYRIGHT:

SHEET TITLE


Existing, HPC Approved, HPO Approved

H4

Existing Exterior @ Garage Door, convert to shutters @ bedrooms as per basics of wood conservation (remove paint)



Existing Exterior Stucco Over CMU @ Main Level

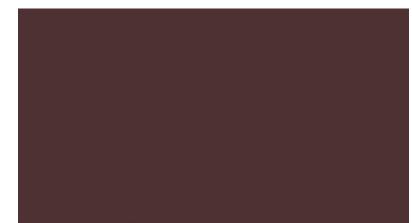

Existing Maroon (Painted Wood), as per basics of wood conservation (remove paint)



Existing Green Exterior (Painted Wood) as per basics of wood conservation (remove paint)




Existing Chalet Materials



Existing Exterior @ Living Level, as per basics of wood conservation (remove paint)



Existing Exterior @ Eave, as per basics of wood conservation (remove paint)

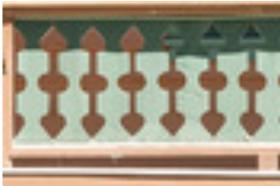

Existing Exterior Banister @ Living Level Deck



Existing Recycled Decking @ Living Level Deck



Existing Chalet Materials



New Exterior Cladding




New Garage Roofing, Copper Cote T-Lock, Berridge (Grey or Brown to work with new stucco garage)



New Exterior Windows at Addition (only). Existing are double pane IGUs with E272, same glass as new)



Proposed Chalet Materials

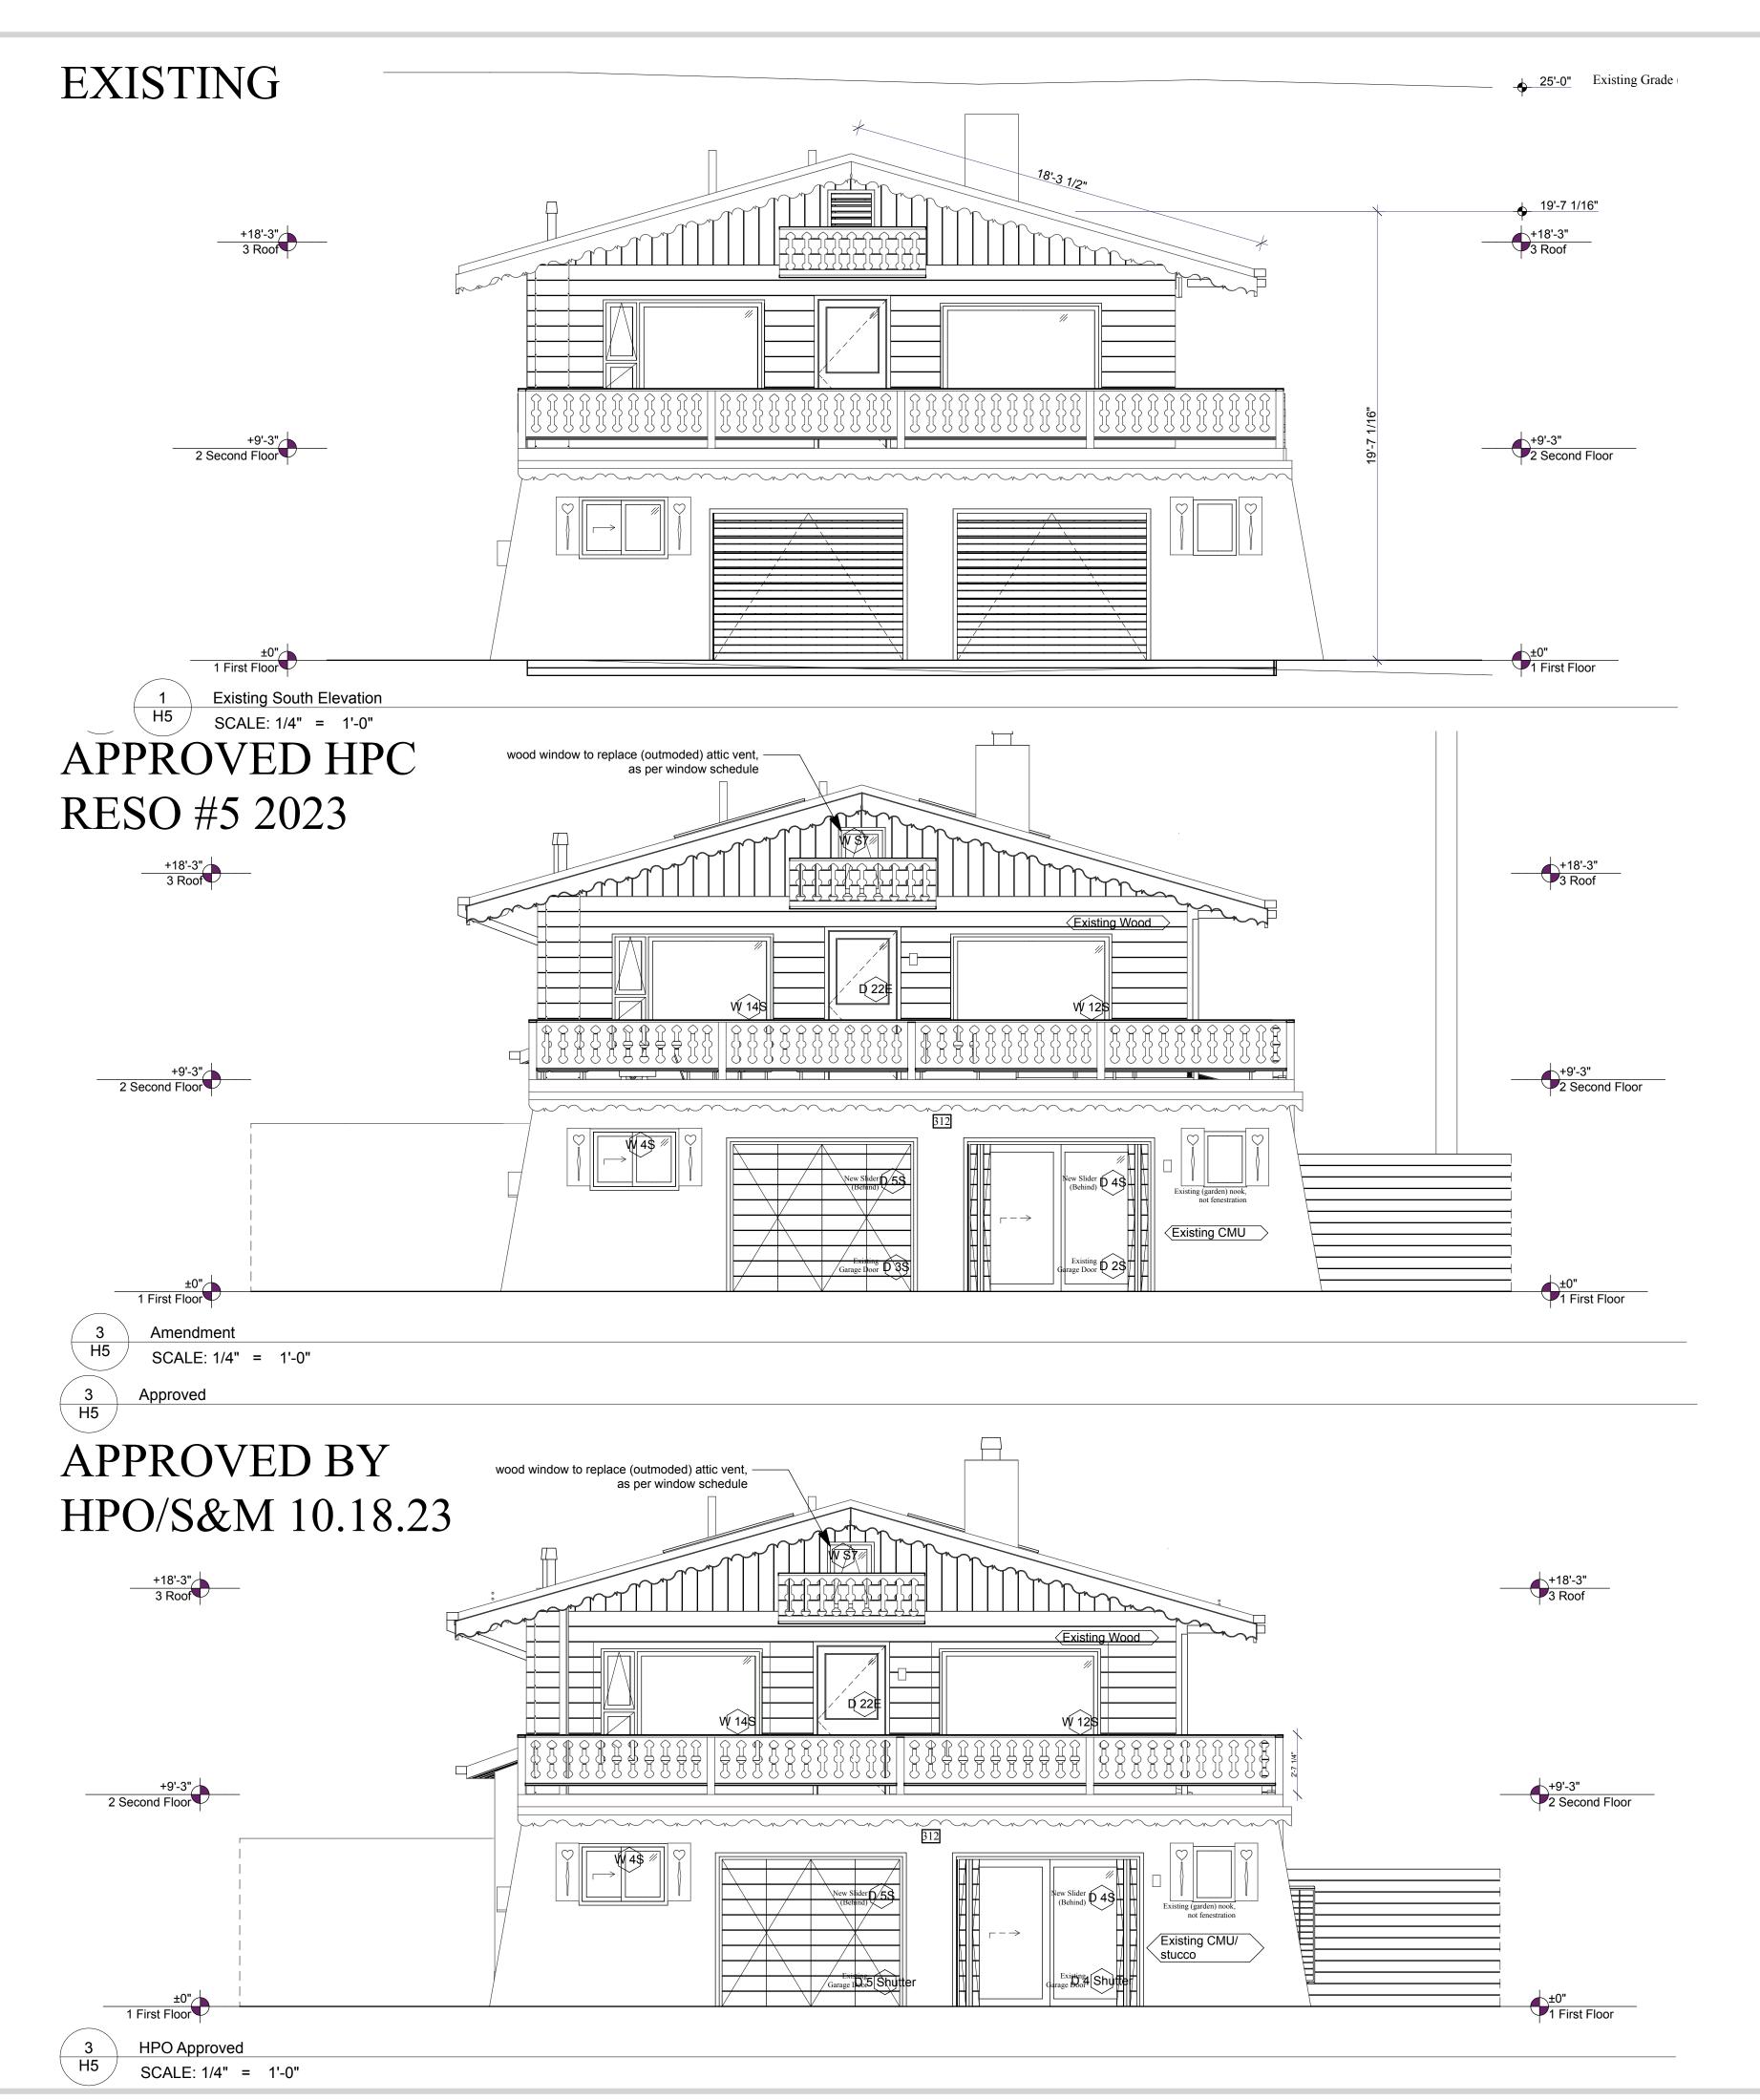




INTEGRATED DESIGN TEAM Civil Grading and Drainage Jay Engstrom, P.E. Crystal River Civil, LLC

Landscape Architect Jennifer M. Dolecki-Smith, RLA Escape Garden Design, LLC Structural Engineer Brian Rossiter, P.E. bwr.pe

Contractor Adam Rothberg Rothberg Development

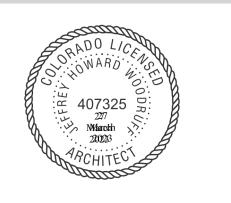

312 W Hyman Ave 312 W Hyman Ave Lots P+Q,

Pitkin County UGB, City of Aspen 312 W Hyman Ave Aspen CO 81611 USA

Block 46 Aspen CO 81611 USA/

Powder Day Skiiing, LLC, David A

Tarrab Mees Account # R000145

Parcel ID # 273512464006

08/22/21 COA- HPO Site Visit

02/26/22 COA- HPC Conceptual I

04/27/22 COA- HPC Conceptual II

07/27/22 COA- HPC Final

10/12/22 COA- City Council Call Up

04/12/23 COA- HPC Substantial

07/29/24 COA- Building comments, #4

06/28/23 COA- Permit Submittal

PROJECT NO: Project No. 116 MODEL FILE:

312_W_Hyman_07292024.pln DRAWN BY: Jeffrey H Woodruff COPYRIGHT:

SHEET TITLE

Existing, HPC Approved, **HPO Approved**

H5




INTEGRATED DESIGN TEAM
Civil Grading and Drainage
Jay Engstrom, P.E.
Crystal River Civil, LLC

Landscape Architect
Jennifer M. Dolecki-Smith, RLA
Escape Garden Design, LLC

Structural Engineer
Brian Rossiter, P.E.
bwr.pe

Contractor Adam Rothberg Rothberg Development

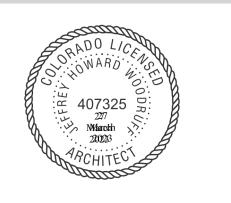

312 W Hyman Ave 312 W Hyman Ave Lots P+Q,

Block 46 Aspen CO 81611 USA/ Pitkin County UGB, City of Aspen

312 W Hyman Ave Aspen CO 81611 USA

Powder Day Skiiing, LLC, David A Tarrab Mees

> Account # R000145 Parcel ID # 273512464006

08/22/21 COA- HPO Site Visit

02/26/22 COA- HPC Conceptual I

04/27/22 COA- HPC Conceptual II

07/27/22 COA- HPC Final

10/12/22 COA- City Council Call Up

04/12/23 COA- HPC Substantial

07/29/24 COA- Building comments, #4

06/28/23 COA- Permit Submittal

PROJECT NO: Project No. 116

MODEL FILE:

312_W_Hyman_07292024.pln

DRAWN BY: Jeffrey H Woodruff


COPYRIGHT:

SHEET TITLE


Existing, HPC Approved, HPO Approved


H6

3 First Floor HPC Approved
H7 SCALE: 6" = 1'-0"

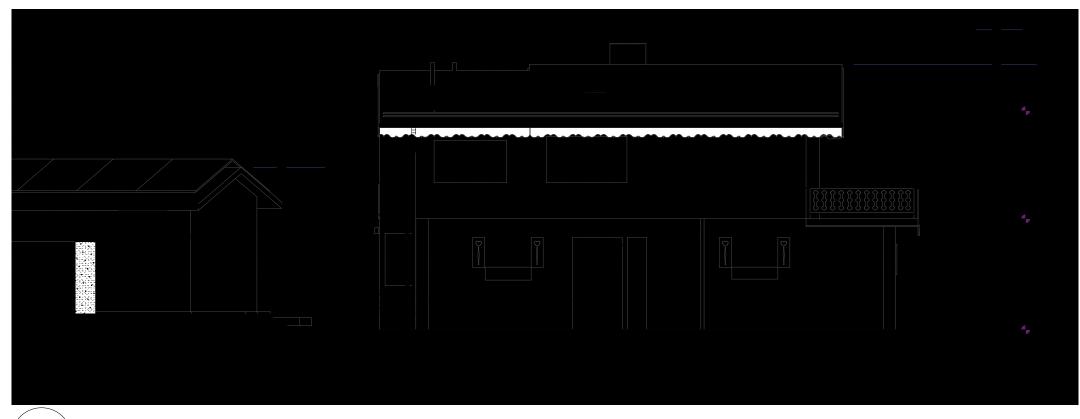

6 First Floor HPC Approved
H7 SCALE: 6" = 1'-0"

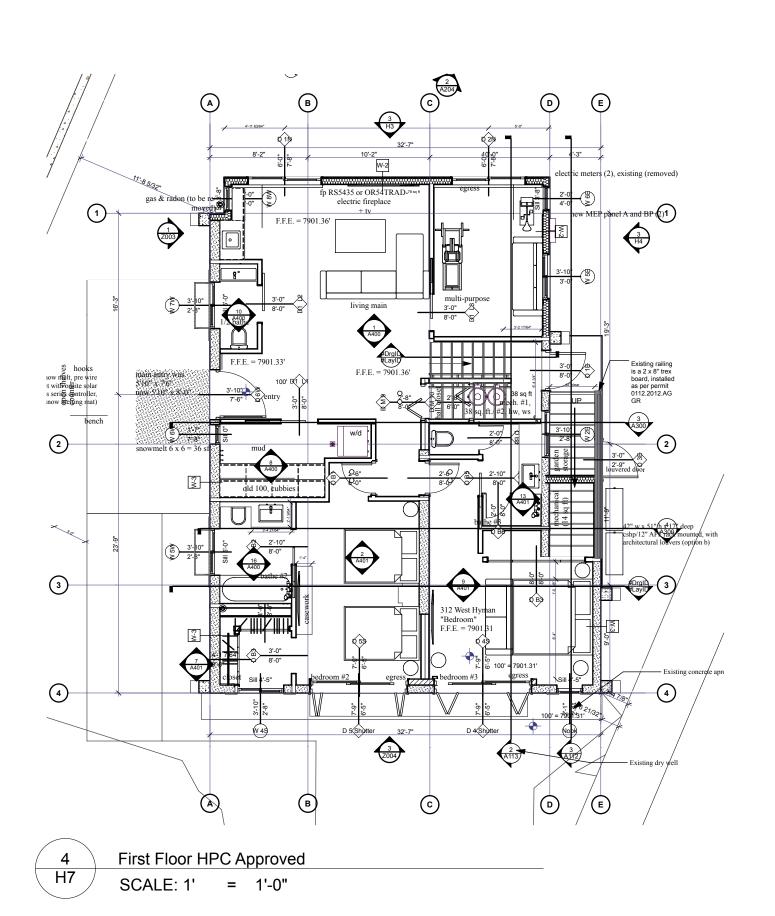


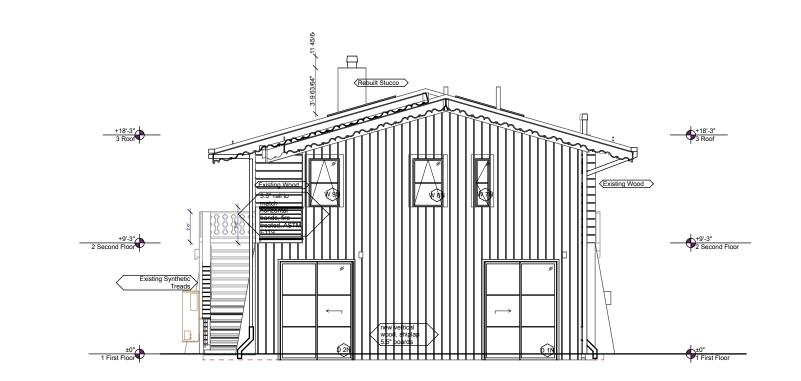

3 HPO SAM Proposed
H7 SCALE: 1/8" = 1'-0"



3 HPO Approved
H7 SCALE: 1/8" = 1'-0"

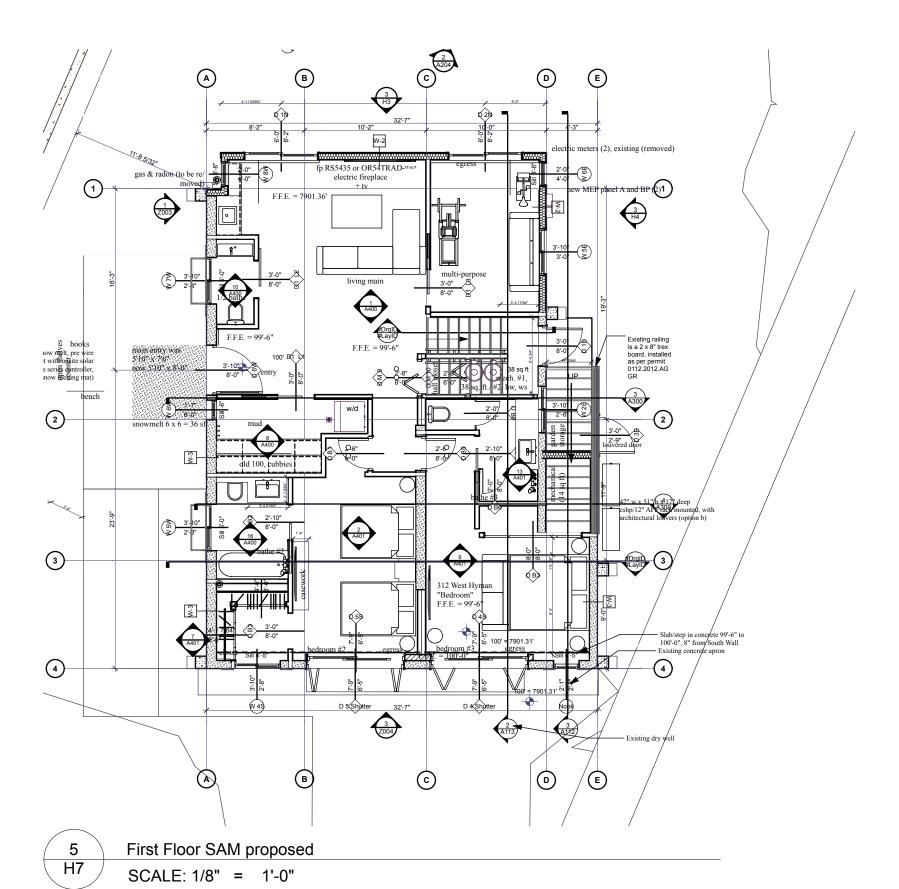


cloud hill design, llc

Jeffrey H. Woodruff AIA, NCARB, LEED AP Cloud Hill Design, LLC Snowmass CO 81654 USA

INTEGRATED DESIGN TEAM
Civil Grading and Drainage
Jay Engstrom, P.E.
Crystal River Civil, LLC

Landscape Architect Jennifer M. Dolecki-Smith, RLA Escape Garden Design, LLC Structural Engineer Brian Rossiter, P.E. bwr.pe

Contractor Adam Rothberg Rothberg Development

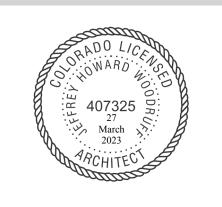

312 W Hyman Ave Lots P+Q,

Block 46 Aspen CO 81611 USA/ Pitkin County UGB, City of Aspen

312 W Hyman Ave Aspen CO 81611 USA

Powder Day Skiiing, LLC, David A Tarrab Mees

Account # R000145 Parcel ID # 273512464006

08/22/21 COA- HPO Site Visit

02/26/22 COA- HPC Conceptual I

04/27/22 COA- HPC Conceptual II

07/27/22 COA- HPC Final

10/12/22 COA- City Council Call Up

04/12/23 COA- HPC Substantial

06/28/23 COA- Permit Submittal

07/29/24 COA- Building comments, #4

PROJECT NO: Project No. 116

MODEL FILE:
312_W_Hyman_07292024.pln

DRAWN BY: Jeffrey H Woodruff

SHEET TITLE

COPYRIGHT:

HPC Approved and SAM

H7

Architectural Site Plan

SCALE: 1/8" = 1'-0"



Jeffrey H. Woodruff AIA, NCARB, LEED AP Cloud Hill Design, LLC Snowmass CO 81654 USA

INTEGRATED DESIGN TEAM
Civil Grading and Drainage

Civil Grading and Drainage Jay Engstrom, P.E. Crystal River Civil, LLC

Landscape Architect
Jennifer M. Dolecki-Smith, RLA
Escape Garden Design, LLC

Structural Engineer
Brian Rossiter, P.E.
bwr.pe

Contractor
Adam Rothberg
Rothberg Development



312 W Hyman Ave

312 W Hyman Ave Lots P+Q, Block 46 Aspen CO 81611 USA/ Pitkin County UGB, City of Aspen

312 W Hyman Ave Aspen CO 81611 USA

Powder Day Skiiing, LLC, David A Tarrab Mees

> Account # R000145 Parcel ID # 273512464006

08/22/21 COA- HPO Site Visit

02/26/22 COA- HPC Conceptual I
04/27/22 COA- HPC Conceptual II

07/27/22 COA- HPC Final

10/12/22 COA- City Council Call Up

04/12/23 COA- HPC Substantial

06/28/23 COA- Permit Submittal

07/29/24 COA- Building comments, #4

PROJECT NO: Project No. 116

MODEL FILE: 312_W_Hyman_07292024.pln

DRAWN BY: Jeffrey H Woodruff COPYRIGHT:

SHEET TITLE

Architectural Site Plan

A101




INTEGRATED DESIGN TEAM

Civil Grading and Drainage Jay Engstrom, P.E. Crystal River Civil, LLC

Landscape Architect Jennifer M. Dolecki-Smith, RLA Escape Garden Design, LLC

Structural Engineer Brian Rossiter, P.E. bwr.pe

Contractor Adam Rothberg Rothberg Development

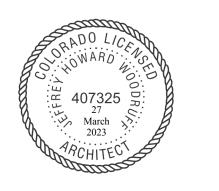

312 W Hyman Ave 312 W Hyman Ave Lots P+Q, Block 46 Aspen CO 81611 USA/ Pitkin County UGB, City of Aspen

312 W Hyman Ave Aspen CO 81611 USA

Powder Day Skiiing, LLC, David A Tarrab Mees

Account # R000145 Parcel ID # 273512464006

08/22/21 COA- HPO Site Visit

02/26/22 COA- HPC Conceptual I

04/27/22 COA- HPC Conceptual II

07/27/22 COA- HPC Final

10/12/22 COA- City Council Call Up

04/12/23 COA- HPC Substantial

06/28/23 COA- Permit Submittal

07/29/24 COA- Building comments, #4

PROJECT NO: Project No. 116

MODEL FILE: 312_W_Hyman_07292024.pln

DRAWN BY: Jeffrey H Woodruff COPYRIGHT:


SHEET TITLE

Contractor Site Plan CMP

A102

SHEET 41

CMP Site Plan

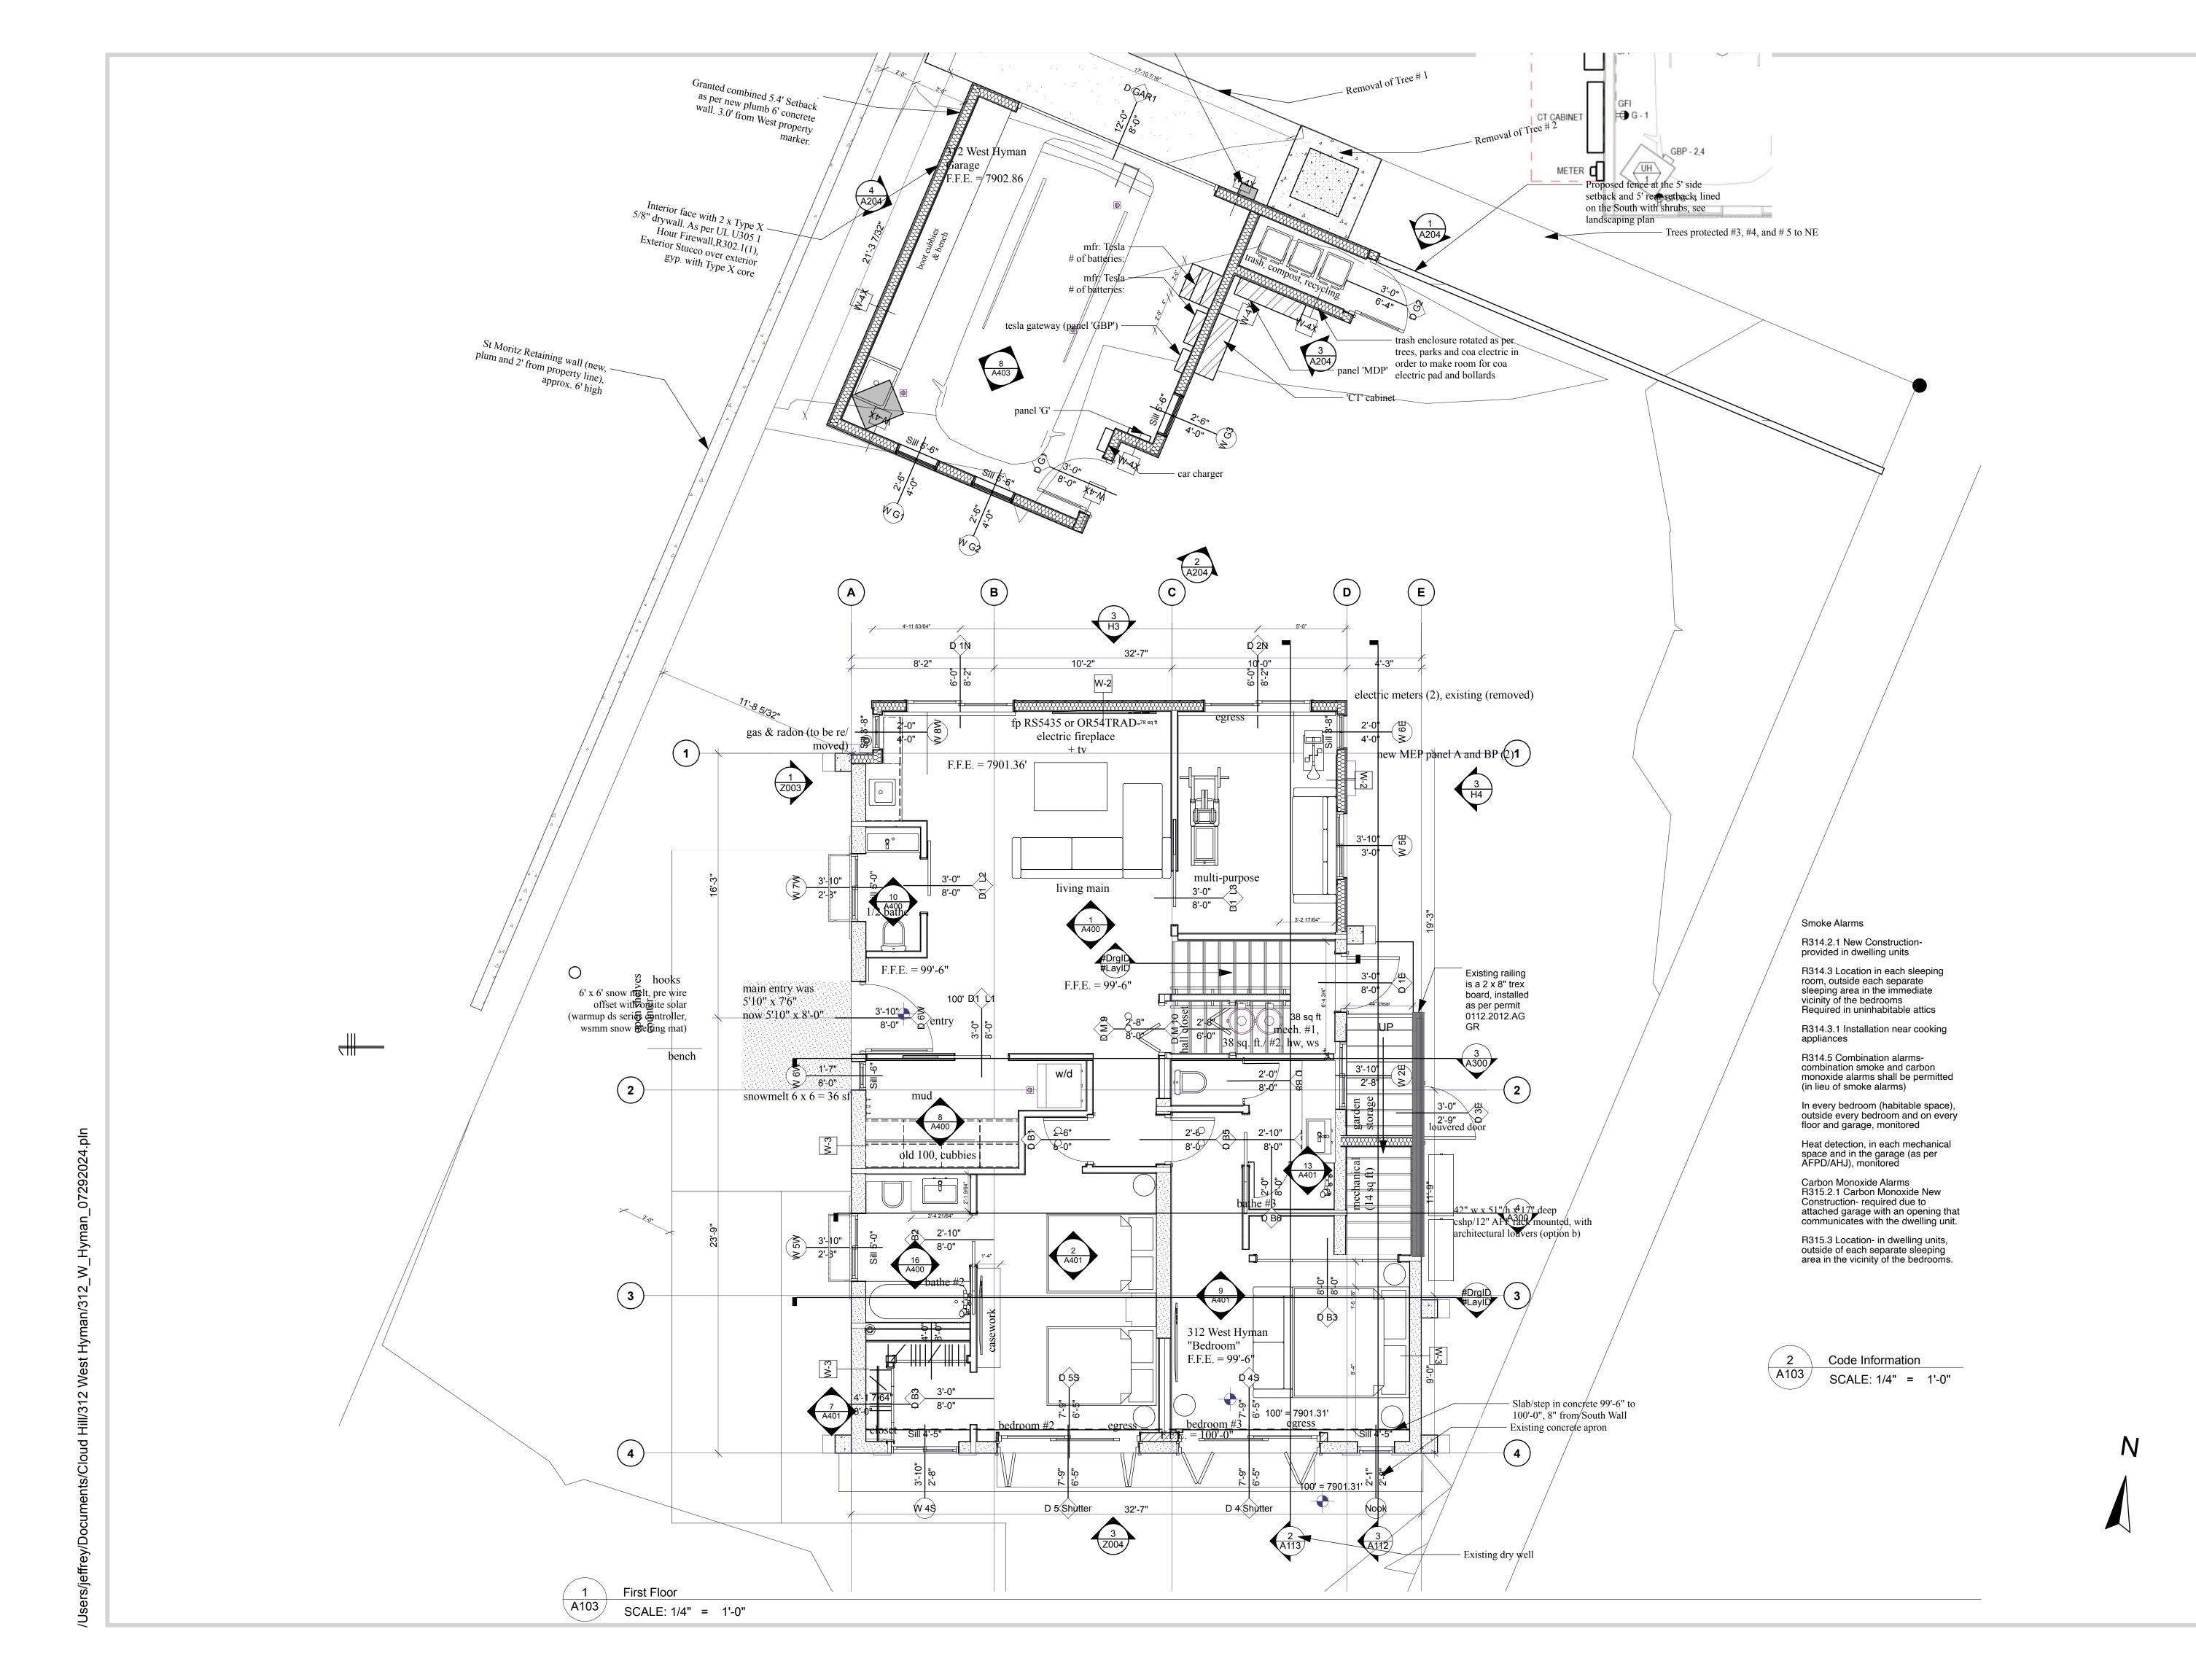



INTEGRATED DESIGN TEAM
Civil Grading and Drainage
Jay Engstrom, P.E.
Crystal River Civil, LLC

Landscape Architect
Jennifer M. Dolecki-Smith, RLA
Escape Garden Design, LLC

Structural Engineer
Brian Rossiter, P.E.
bwr.pe

Contractor Adam Rothberg Rothberg Development



312 W Hyman Ave 312 W Hyman Ave Lots P+Q,

312 W Hyman Ave Lots P+Q, Block 46 Aspen CO 81611 USA/ Pitkin County UGB, City of Aspen

312 W Hyman Ave Aspen CO 81611 USA

Powder Day Skiiing, LLC, David A Tarrab Mees

> Account # R000145 Parcel ID # 273512464006

08/22/21 COA- HPO Site Visit

,

02/26/22 COA- HPC Conceptual I

04/27/22 COA- HPC Conceptual II

07/27/22 COA- HPC Final

10/12/22 COA- City Council Call Up

04/12/23 COA- HPC Substantial

06/28/23 COA- Permit Submittal

07/29/24 COA- Building comments, #4

PROJECT NO: Project No. 116

MODEL FILE:
312_W_Hyman_07292024.pln

DRAWN BY: Jeffrey H Woodruff

SHEET TITLE

COPYRIGHT:

Main Level Proposed Plan

A103

INTEGRATED DESIGN TEAM Civil Grading and Drainage Jay Engstrom, P.E. Crystal River Civil, LLC Landscape Architect Jennifer M. Dolecki-Smith, RLA Escape Garden Design, LLC

Snowmass CO 81654 USA

Contractor Adam Rothberg Rothberg Development

Structural Engineer Brian Rossiter, P.E. bwr.pe



312 W Hyman Ave Lots P+Q, Block 46 Aspen CO 81611 USA/ Pitkin County UGB, City of Aspen

312 W Hyman Ave Aspen CO 81611 USA

Powder Day Skiiing, LLC, David A Tarrab Mees

Account # R000145 Parcel ID # 273512464006

08/22/21 COA- HPO Site Visit

02/26/22 COA- HPC Conceptual I 04/27/22 COA- HPC Conceptual II

07/27/22 COA- HPC Final

10/12/22 COA- City Council Call Up

04/12/23 COA- HPC Substantial

06/28/23 COA- Permit Submittal

07/29/24 COA- Building comments, #4

PROJECT NO: Project No. 116 MODEL FILE:


312_W_Hyman_07292024.pln DRAWN BY: Jeffrey H Woodruff COPYRIGHT:

SHEET TITLE

Second Level Proposed Plan

A104

SHEET 43

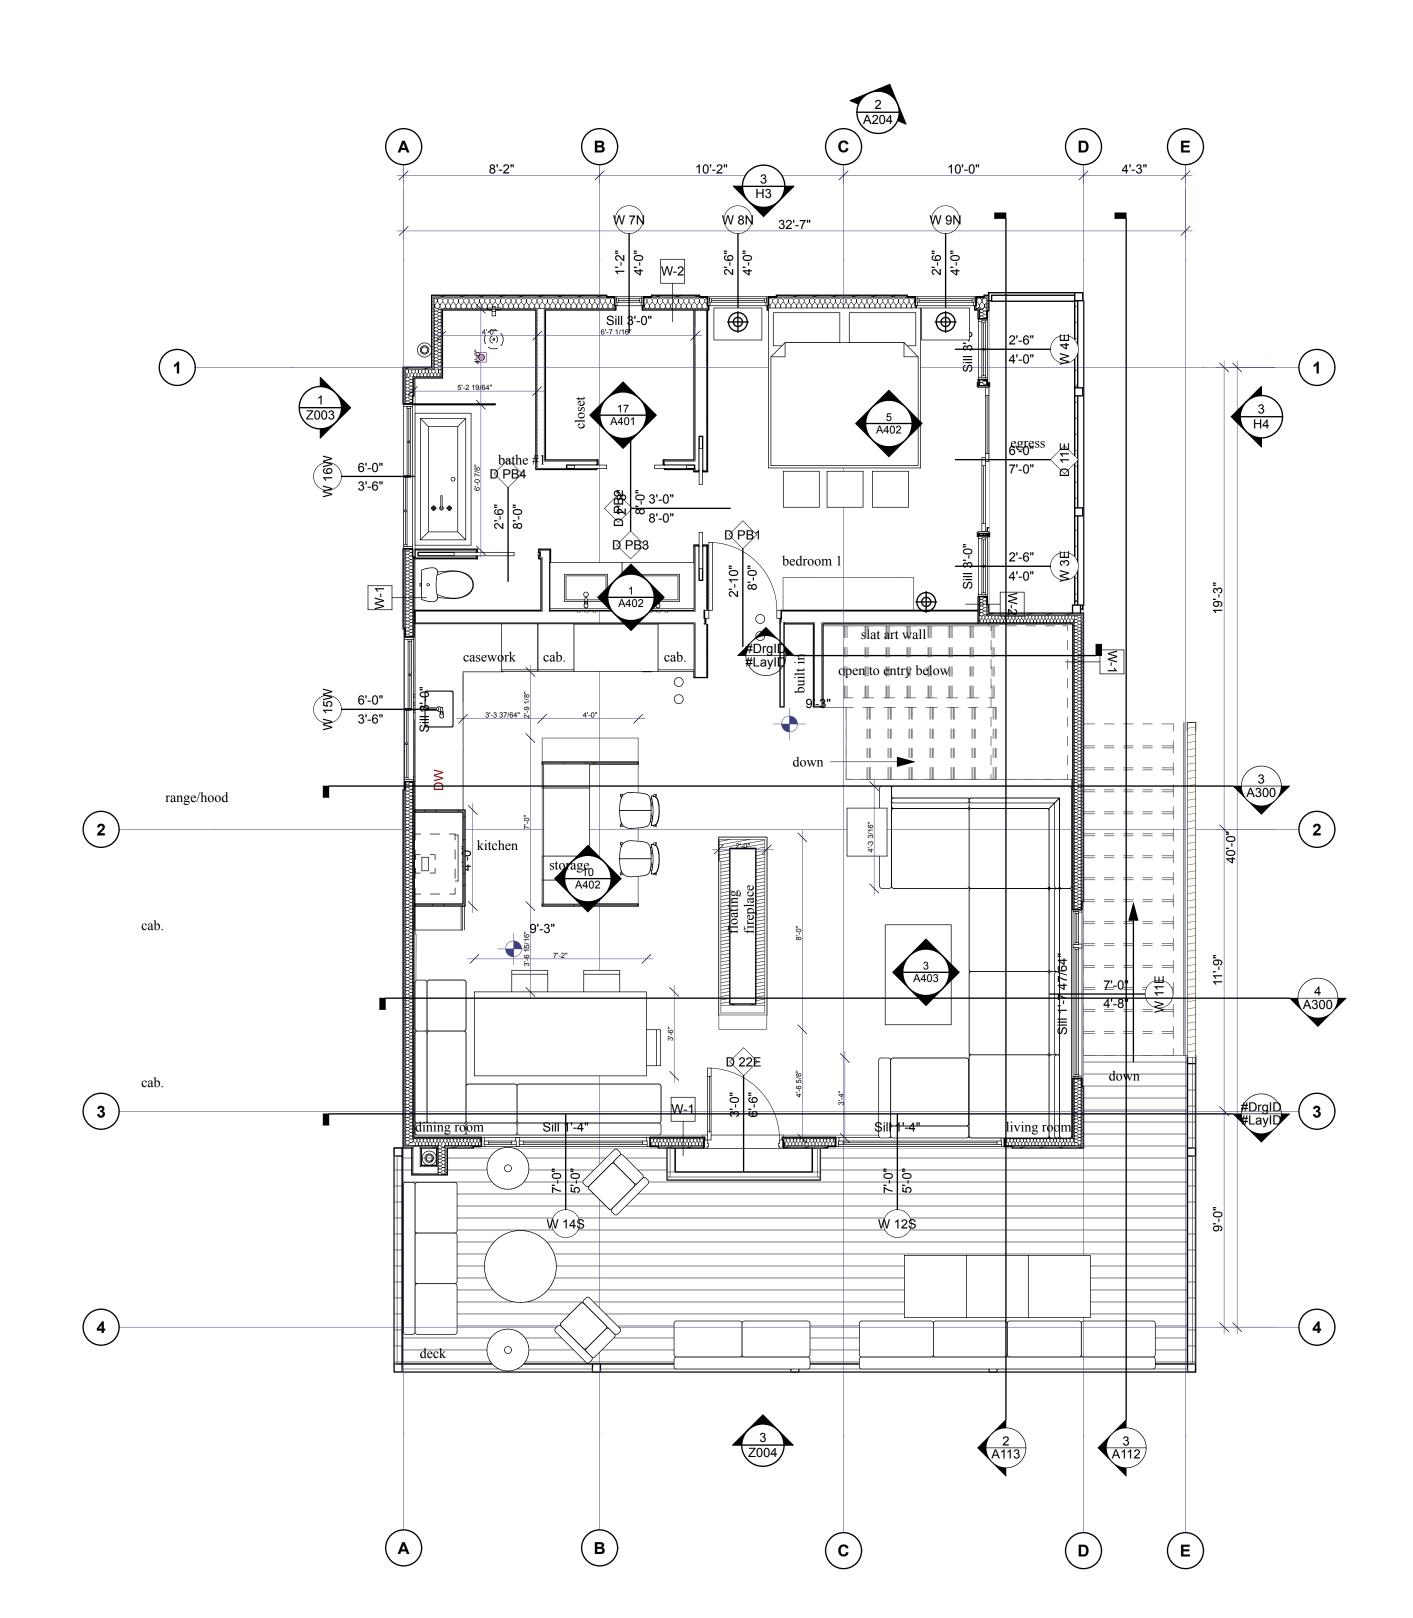

Smoke Alarms

R314.2.1 New Construction-provided in dwelling units

R314.3 Location in each sleeping room, outside each separate sleeping area in the immediate vicinity of the bedrooms

R314.3.1 Installation near cooking appliances

Required in uninhabitable attics

R314.5 Combination alarmscombination smoke and carbon monoxide alarms shall be permitted (in lieu of smoke alarms)

In every bedroom (habitable space), outside every bedroom and on every floor and garage, monitored

Heat detection, in each mechanical space and in the garage (as per AFPD/AHJ), monitored

Carbon Monoxide Alarms R315.2.1 Carbon Monoxide New Construction- required due to attached garage with an opening that communicates with the dwelling unit.

R315.3 Location- in dwelling units, outside of each separate sleeping area in the vicinity of the bedrooms.

Code Information SCALE: 1/4" = 1'-0"

Second Floor SCALE: 1/4" = 1'-0"

Today this is a cold roof with attic vents. The current attic vents and

screens are in disrepair (upon viewing from the attic). We are

exposing the rafters, adding insulation and updating the light and

The attic vent(s) will be converted to fenestration of the same size

rough opening, (a hopper for light and vent, will not interfere with

Section R910 Snow shed design. Roofs shall be designed so

that they do not shed ice and snow onto adjoining properties or

potentially occupied areas such as a walkway, stairway, alley,

where there is potential for personal injury or property damage

Section 1513 Snow shed design. Roofs shall be designed so

that they do not shed ice and snow onto adjacent properties and potentially occupied areas such as a walkway, stairway, alley,

where there is potential for personal injury or property damage

SCALE: 1/4" = 1'-0"

deck, pedestrian and vehicular exit from buildings or areas

and areas directly above or in front of gas utility or electric

Two bar snow pipes as per submittal, specifications.

deck, pedestrian and vehicular exit from buildings or areas

and areas directly above or in front of gas utility or electric

removing the dropped ceiling, removing the attic vents and

U-Value for horizontal fenestration = .50 as per IECC 2021


vent in a Chalet style.

the south facing Juliet balcony).

utility meters. (Ord. 40-2016)

utility meters.

As per currently adopted IRC

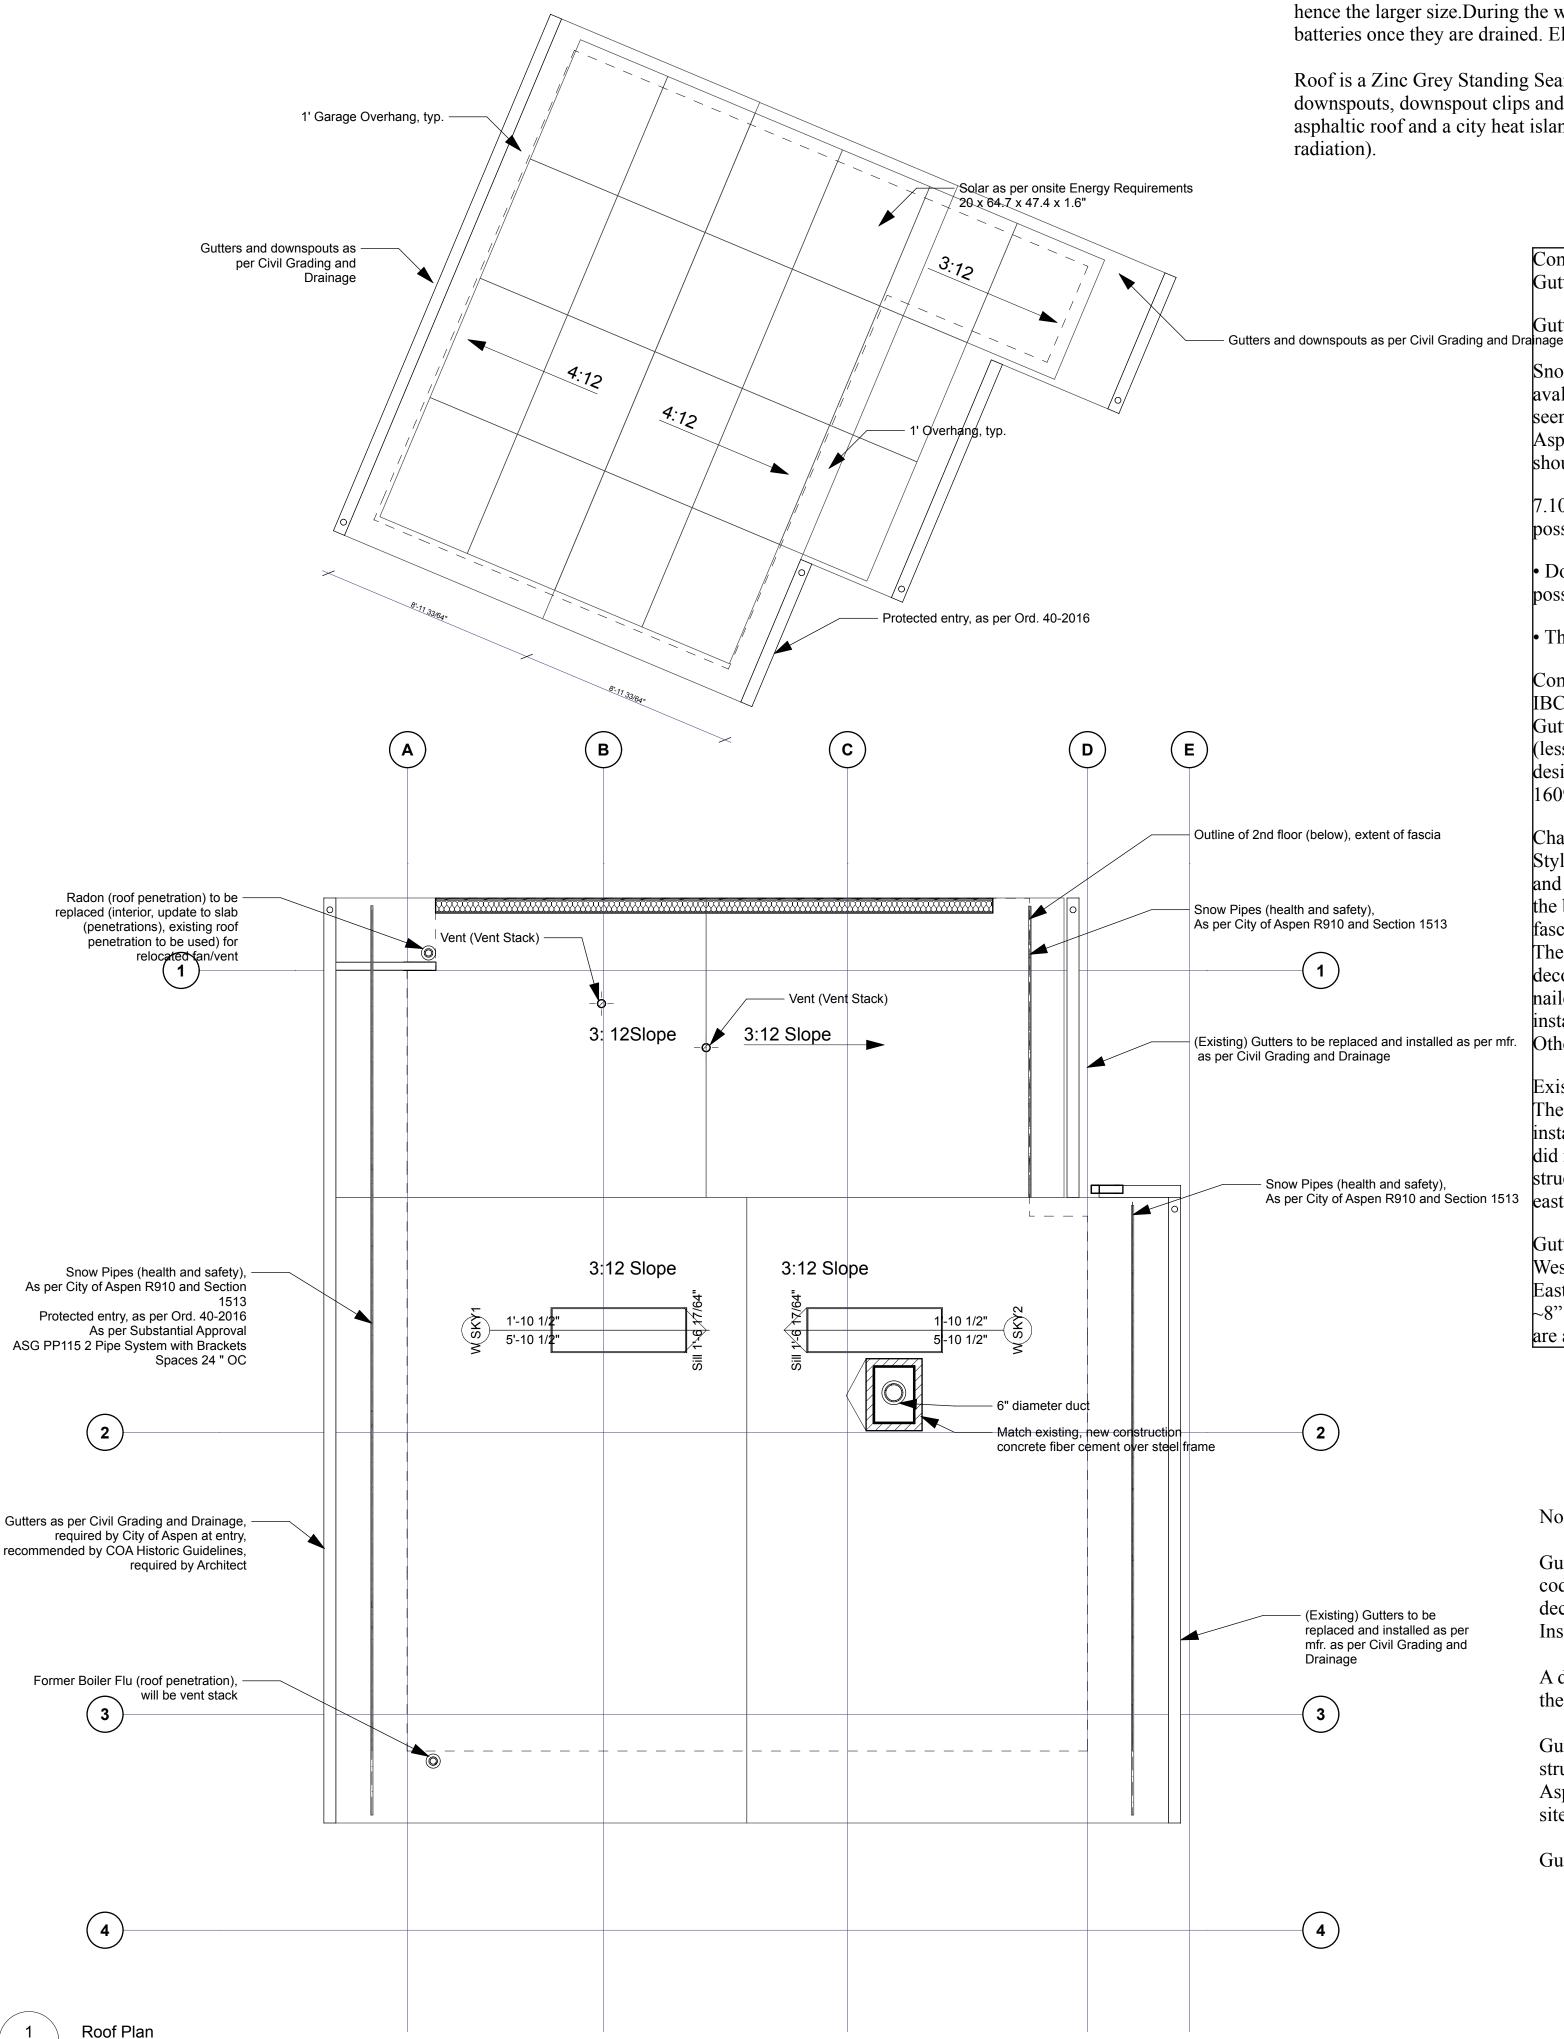

6kw solar electric system for (2) separate meters based on 16 panels on the garage. With 10% shade loss and 15% snow loss for the year the system will produce about 14,862kWh. For the batteries= (5). The homeowner's goals are to have the batteries supplying power for both panels during a grid outage for hours or days during the winter, hence the larger size. During the winter with snow coverage, the panels would not produce much to replenish the batteries once they are drained. Electric car charger hook up as per City of Aspen.

Roof is a Zinc Grey Standing Seam Tee-Panel (profile) Metal Roof by Berridge Manufacturing Company. Gutters, downspouts, downspout clips and elbows are all Zinc Grey. Fascia is Zinc Grey. (The main chalet is a black asphaltic roof and a city heat island. The garage will be Zinc Grey and the solar panels will absorb the solar

> Complying with Chapter 7 Historic Preservation Guidelines Gutters, Downspouts, Snowstops, and Snow Fences

Gutters and downspouts are used to divert water away from a structure.

Snow fences are used to protect inhabitants and the building from the sudden snow avalanches that rip off architectural details and can cause serious injury. Gutters can be seen in some 19th century photos of historic buildings and are more common on AspenModern structures. Overall, the visual impact of these functional elements should be minimized.

7.10 Design gutters so that their visibility on the structure is minimized to the extent

• Downspouts should be placed in locations that are not visible from the street if possible, or in locations that do not obscure architectural detailing on the building.

• The material used for the gutters should be in character with the style of the building.

Complying with IBC

IBC 1504.6.1Gutter securement for low-slope roofs.

Gutters that are used to secure the perimeter edge of the roof membrane on low-slope (less than 2:12 slope) built-up, modified bitumen, and single-ply roofs, shall be designed, constructed and installed to resist wind loads in accordance with Section 1609 and shall be tested in accordance with Test Methods G-1 and G-2 of SPRI GT-1

Character of gutter, downspout, downspout straps and elbows

Style of Gutter: Box Style A1, 24 Gage Galvalume, Box Downspout, downspout straps and Elbow in 3" x 4" in 24 Gage Galvalume, color to match decorative trim. (Today the brown decorative fascia has a brown gutter in ~K style on the East decorative

The existing gutters to be removed, and re-installed with Box Style A1 to match the decorative trim. Blocking should be added (interior face of the decorative trim, toe nailed to the rafters, painted to match and guarddog 2" (or sim.) screws should used to linstall the new gutters (piercing the decorative trim and the newly installed blocking) (Existing) Gutters to be replaced and installed as per mfr. Otherwise the existing (east) gutters will shear from the decorative trim.

Existing conditions

The decorative fascia is not covered by the current East gutters. The former owner installed gutters without accounting for the run off from the west side of the site and did not file a construction management plan; so the water is imperiling the fascia, the structure and not handled onsite as per City Engineering. The installed gutters on the east side of the building threaten the decorative fascia.

Gutters, Box Style A measure 3" deep/high and 4" wide (minimum as per mfr.) West: The interior measurement of the fascia on the West is 10 1/4" deep/high. East: The east gutters will not cover the decorative fascia, which appear narrower at ~8" deep. The east gutters, as currently installed do not cover the decorative facia, but are a building and health and safety concern (all hardware daylights, shiners, typ).

Note:

Gutters exist on the East fascia, as per City of Aspen adopted building code, they were not properly installed and jeopardize the historic decorative trim.

Install as per mfr. with blocking toenailed to the rafters, as per arch.

A dry well holds run-off from the east gable. The Trex deck drains to the dry well to the south.

Gutters on the west gable and a new dry well to the North of the structure bring the historic structure into compliance with the city of Aspen adopted building code (protection of occupants at entry and onsite capture and dispersion of water events).

Gutters and snow guards are required as per city of aspen 2016 Ord .40.





Jeffrey H. Woodruff AIA, NCARB, LEED AP Cloud Hill Design, LLC Snowmass CO 81654 USA

INTEGRATED DESIGN TEAM

Civil Grading and Drainage Jay Engstrom, P.E. Crystal River Civil, LLC

Landscape Architect Jennifer M. Dolecki-Smith, RLA Escape Garden Design, LLC Structural Engineer Brian Rossiter, P.E.

Contractor Adam Rothberg Rothberg Development

bwr.pe



312 W Hyman Ave

312 W Hyman Ave Lots P+Q, Block 46 Aspen CO 81611 USA/ Pitkin County UGB, City of Aspen

312 W Hyman Ave Aspen CO 81611 USA

Powder Day Skiiing, LLC, David A **Tarrab Mees**

Account # R000145 Parcel ID # 273512464006

08/22/21 COA- HPO Site Visit

02/26/22 COA- HPC Conceptual I

04/27/22 COA- HPC Conceptual II

07/27/22 COA- HPC Final

10/12/22 COA- City Council Call Up

04/12/23 COA- HPC Substantial

06/28/23 COA- Permit Submittal

07/29/24 COA- Building comments, #4

PROJECT NO: Project No. 116

MODEL FILE: 312_W_Hyman_07292024.pln DRAWN BY: Jeffrey H Woodruff

SHEET TITLE

COPYRIGHT:

Roof Plan Proposed

A105

INTEGRATED DESIGN TEAM
Civil Grading and Drainage
Jay Engstrom, P.E.
Crystal River Civil, LLC

Landscape Architect
Jennifer M. Dolecki-Smith, RLA
Escape Garden Design, LLC

Structural Engineer
Brian Rossiter, P.E.
bwr.pe

Contractor Adam Rothberg Rothberg Development



312 W Hyman Ave 312 W Hyman Ave Lots P+Q, Block 46 Aspen CO 81611 USA/ Pitkin County UGB, City of Aspen

312 W Hyman Ave Aspen CO 81611 USA

Powder Day Skiiing, LLC, David A Tarrab Mees

Account # R000145 Parcel ID # 273512464006

08/22/21 COA- HPO Site Visit

02/26/22 COA- HPC Conceptual I

04/27/22 COA- HPC Conceptual II

07/27/22 COA- HPC Final

10/12/22 COA- City Council Call Up

04/12/23 COA- HPC Substantial

07/29/24 COA- Building comments, #4

06/28/23 COA- Permit Submittal

PROJECT NO: Project No. 116

MODEL FILE:

312_W_Hyman_07292024.pln


DRAWN BY: Jeffrey H Woodruff

COPYRIGHT:

SHEET TITLE

Main Level Existing Plan

A106

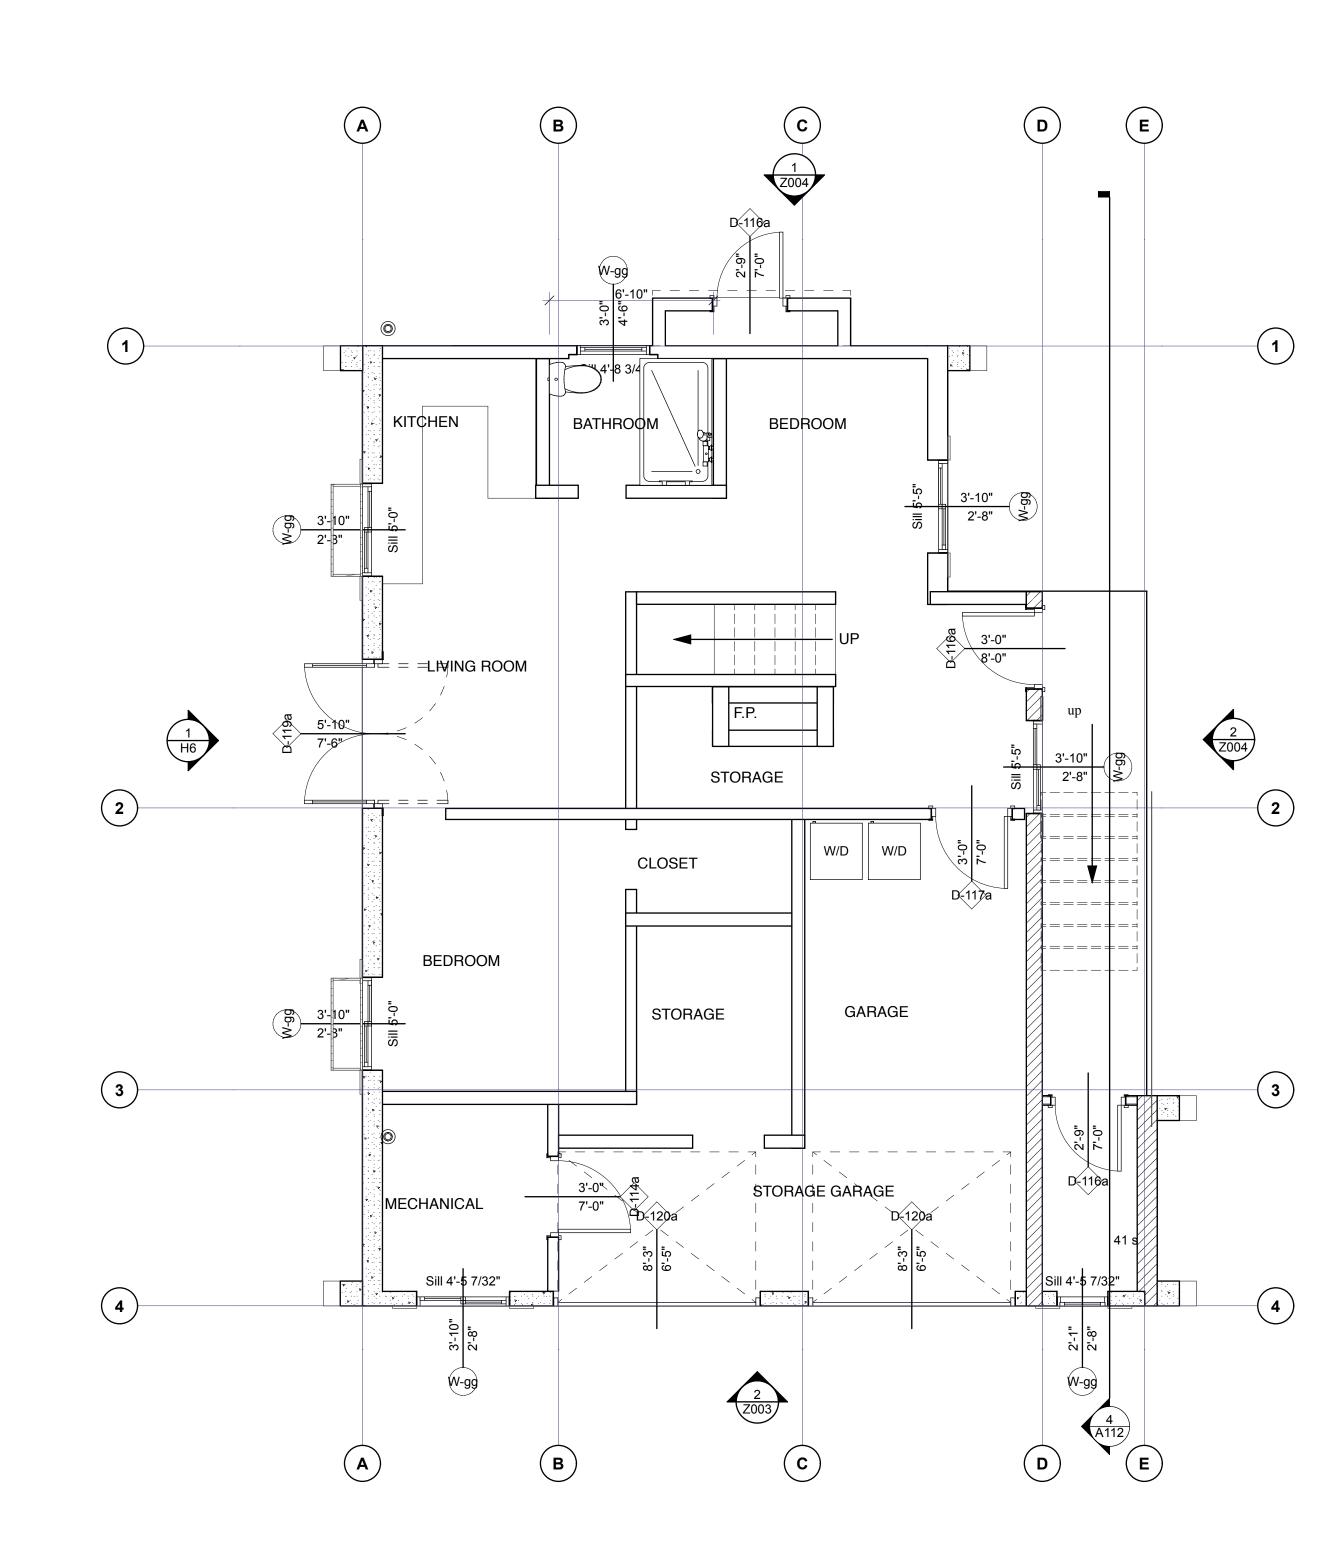



 \bigcirc



Jeffrey H. Woodruff AIA, NCARB, LEED AP Cloud Hill Design, LLC Snowmass CO 81654 USA

INTEGRATED DESIGN TEAM Civil Grading and Drainage Jay Engstrom, P.E. Crystal River Civil, LLC Landscape Architect Jennifer M. Dolecki-Smith, RLA Escape Garden Design, LLC Structural Engineer Brian Rossiter, P.E. bwr.pe

Contractor Adam Rothberg Rothberg Development



312 W Hyman Ave Lots P+Q,

Block 46 Aspen CO 81611 USA/ Pitkin County UGB, City of Aspen

312 W Hyman Ave Aspen CO 81611 USA

Powder Day Skiiing, LLC, David A Tarrab Mees

Account # R000145 Parcel ID # 273512464006

08/22/21 COA- HPO Site Visit

02/26/22 COA- HPC Conceptual I

04/27/22 COA- HPC Conceptual II

07/27/22 COA- HPC Final

10/12/22 COA- City Council Call Up

04/12/23 COA- HPC Substantial

07/29/24 COA- Building comments, #4

06/28/23 COA- Permit Submittal

PROJECT NO: Project No. 116 MODEL FILE:

312_W_Hyman_07292024.pln DRAWN BY: Jeffrey H Woodruff COPYRIGHT:


SHEET TITLE

N

Second Level Existing Plan

A107

SHEET 46

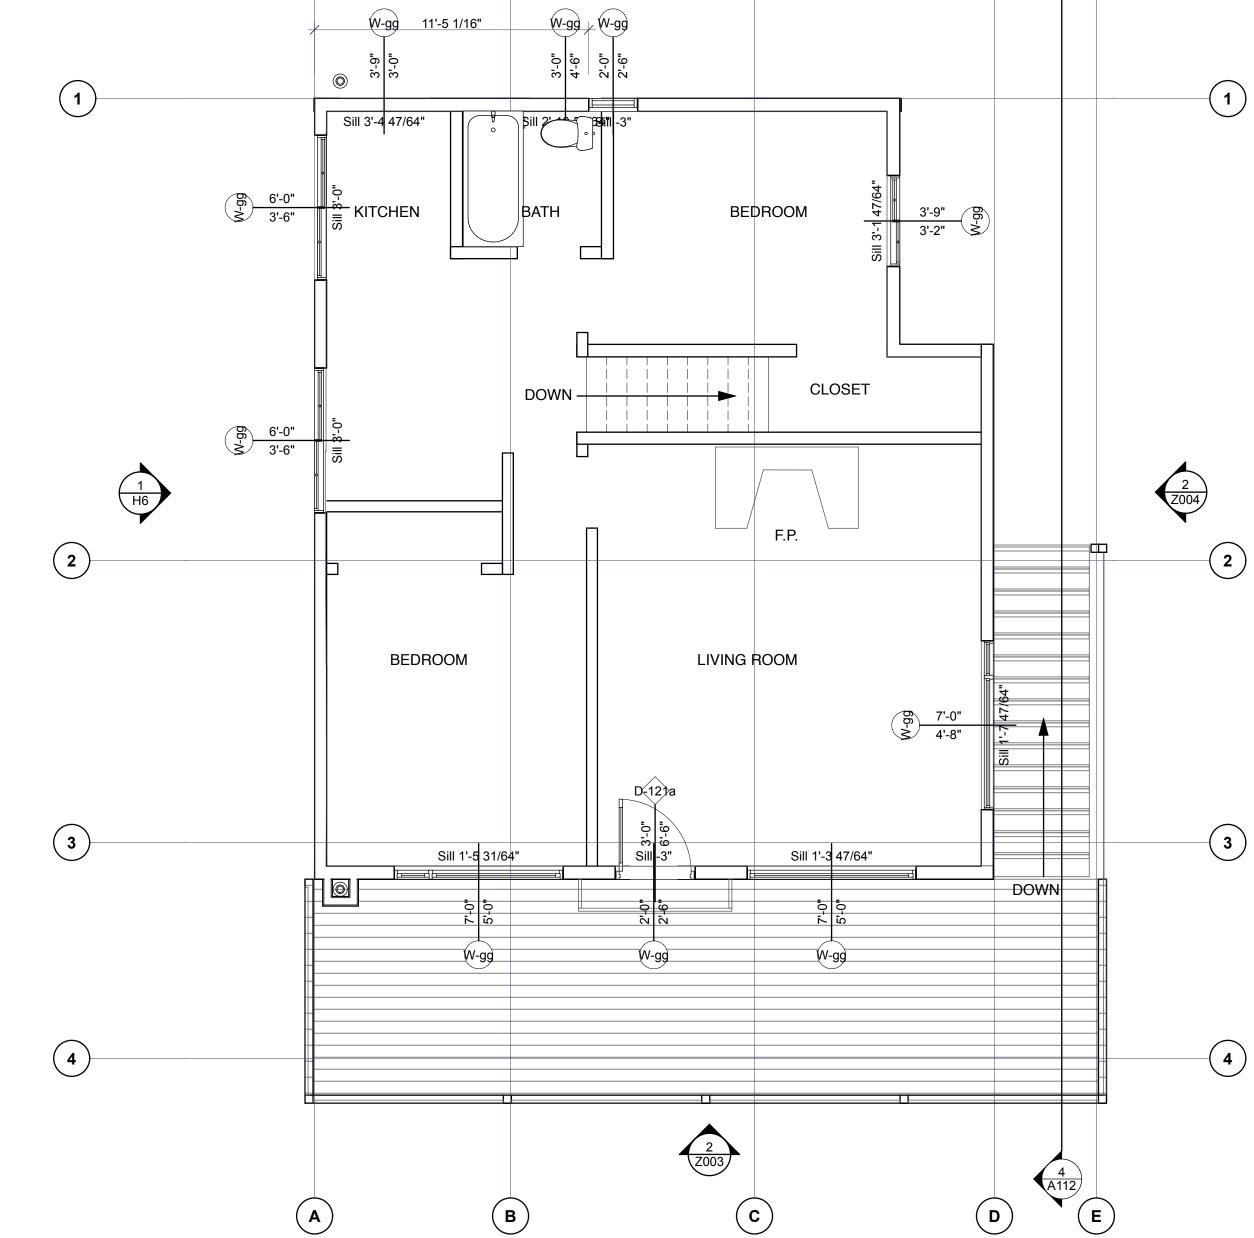

1 Z004

D

E

INTEGRATED DESIGN TEAM
Civil Grading and Drainage
Jay Engstrom, P.E.
Crystal River Civil, LLC

Landscape Architect
Jennifer M. Dolecki-Smith, RLA
Escape Garden Design, LLC

Structural Engineer
Brian Rossiter, P.E.
bwr.pe

Contractor Adam Rothberg Rothberg Development



312 W Hyman Ave
312 W Hyman Ave Lots P+Q,
Block 46 Aspen CO 81611 USA/
Pitkin County UGB, City of Aspen

312 W Hyman Ave Aspen CO 81611 USA

Powder Day Skiiing, LLC, David A Tarrab Mees

Account # R000145 Parcel ID # 273512464006

08/22/21 COA- HPO Site Visit

02/26/22 COA- HPC Conceptual I

04/27/22 COA- HPC Conceptual II

07/27/22 COA- HPC Final

10/12/22 COA- City Council Call Up

04/12/23 COA- HPC Substantial

06/28/23 COA- Permit Submittal

07/29/24 COA- Building comments, #4

PROJECT NO: Project No. 116

MODEL FILE:

312_W_Hyman_07292024.pln

DRAWN BY: Jeffrey H Woodruff


COPYRIGHT:


SHEET TITLE

N

Roof Plan Existing

A108

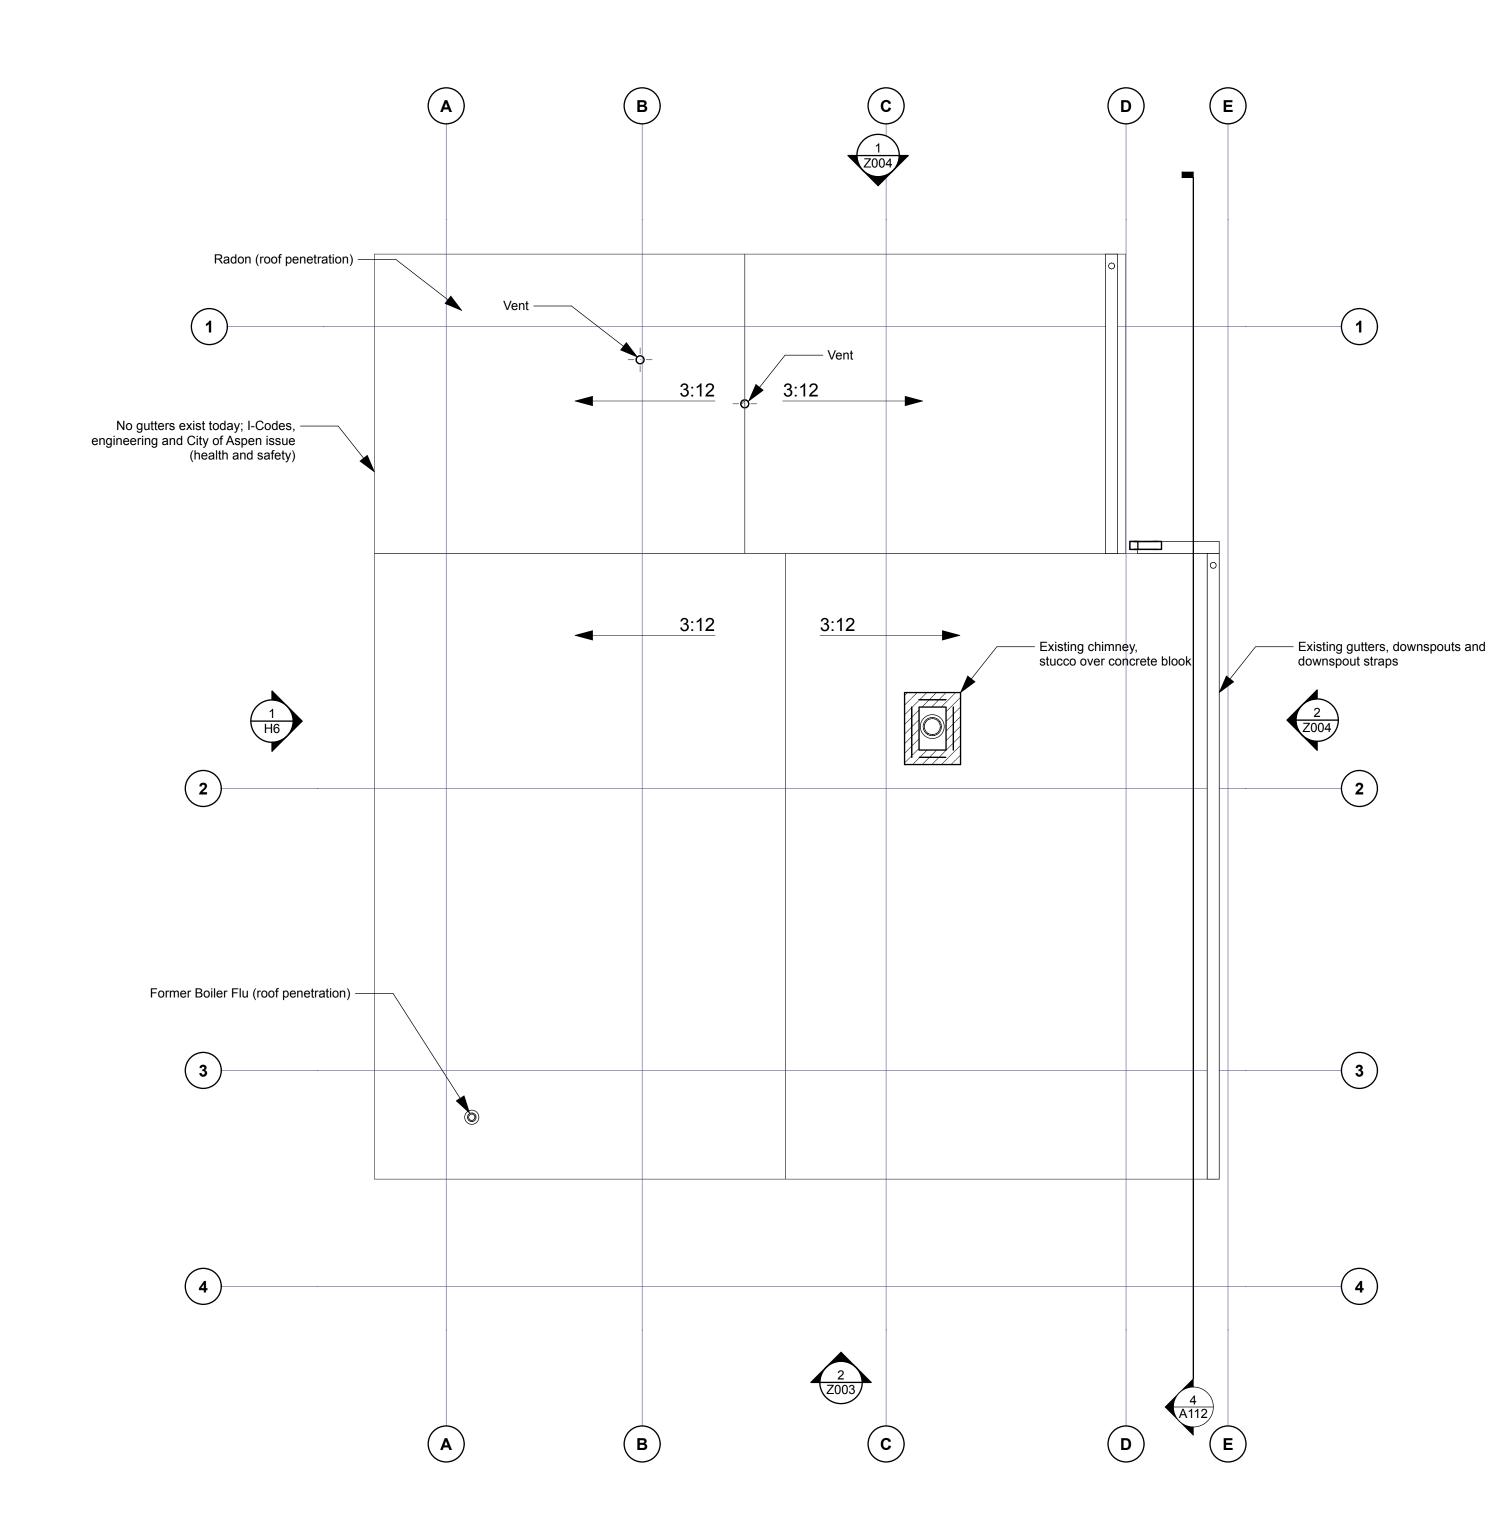

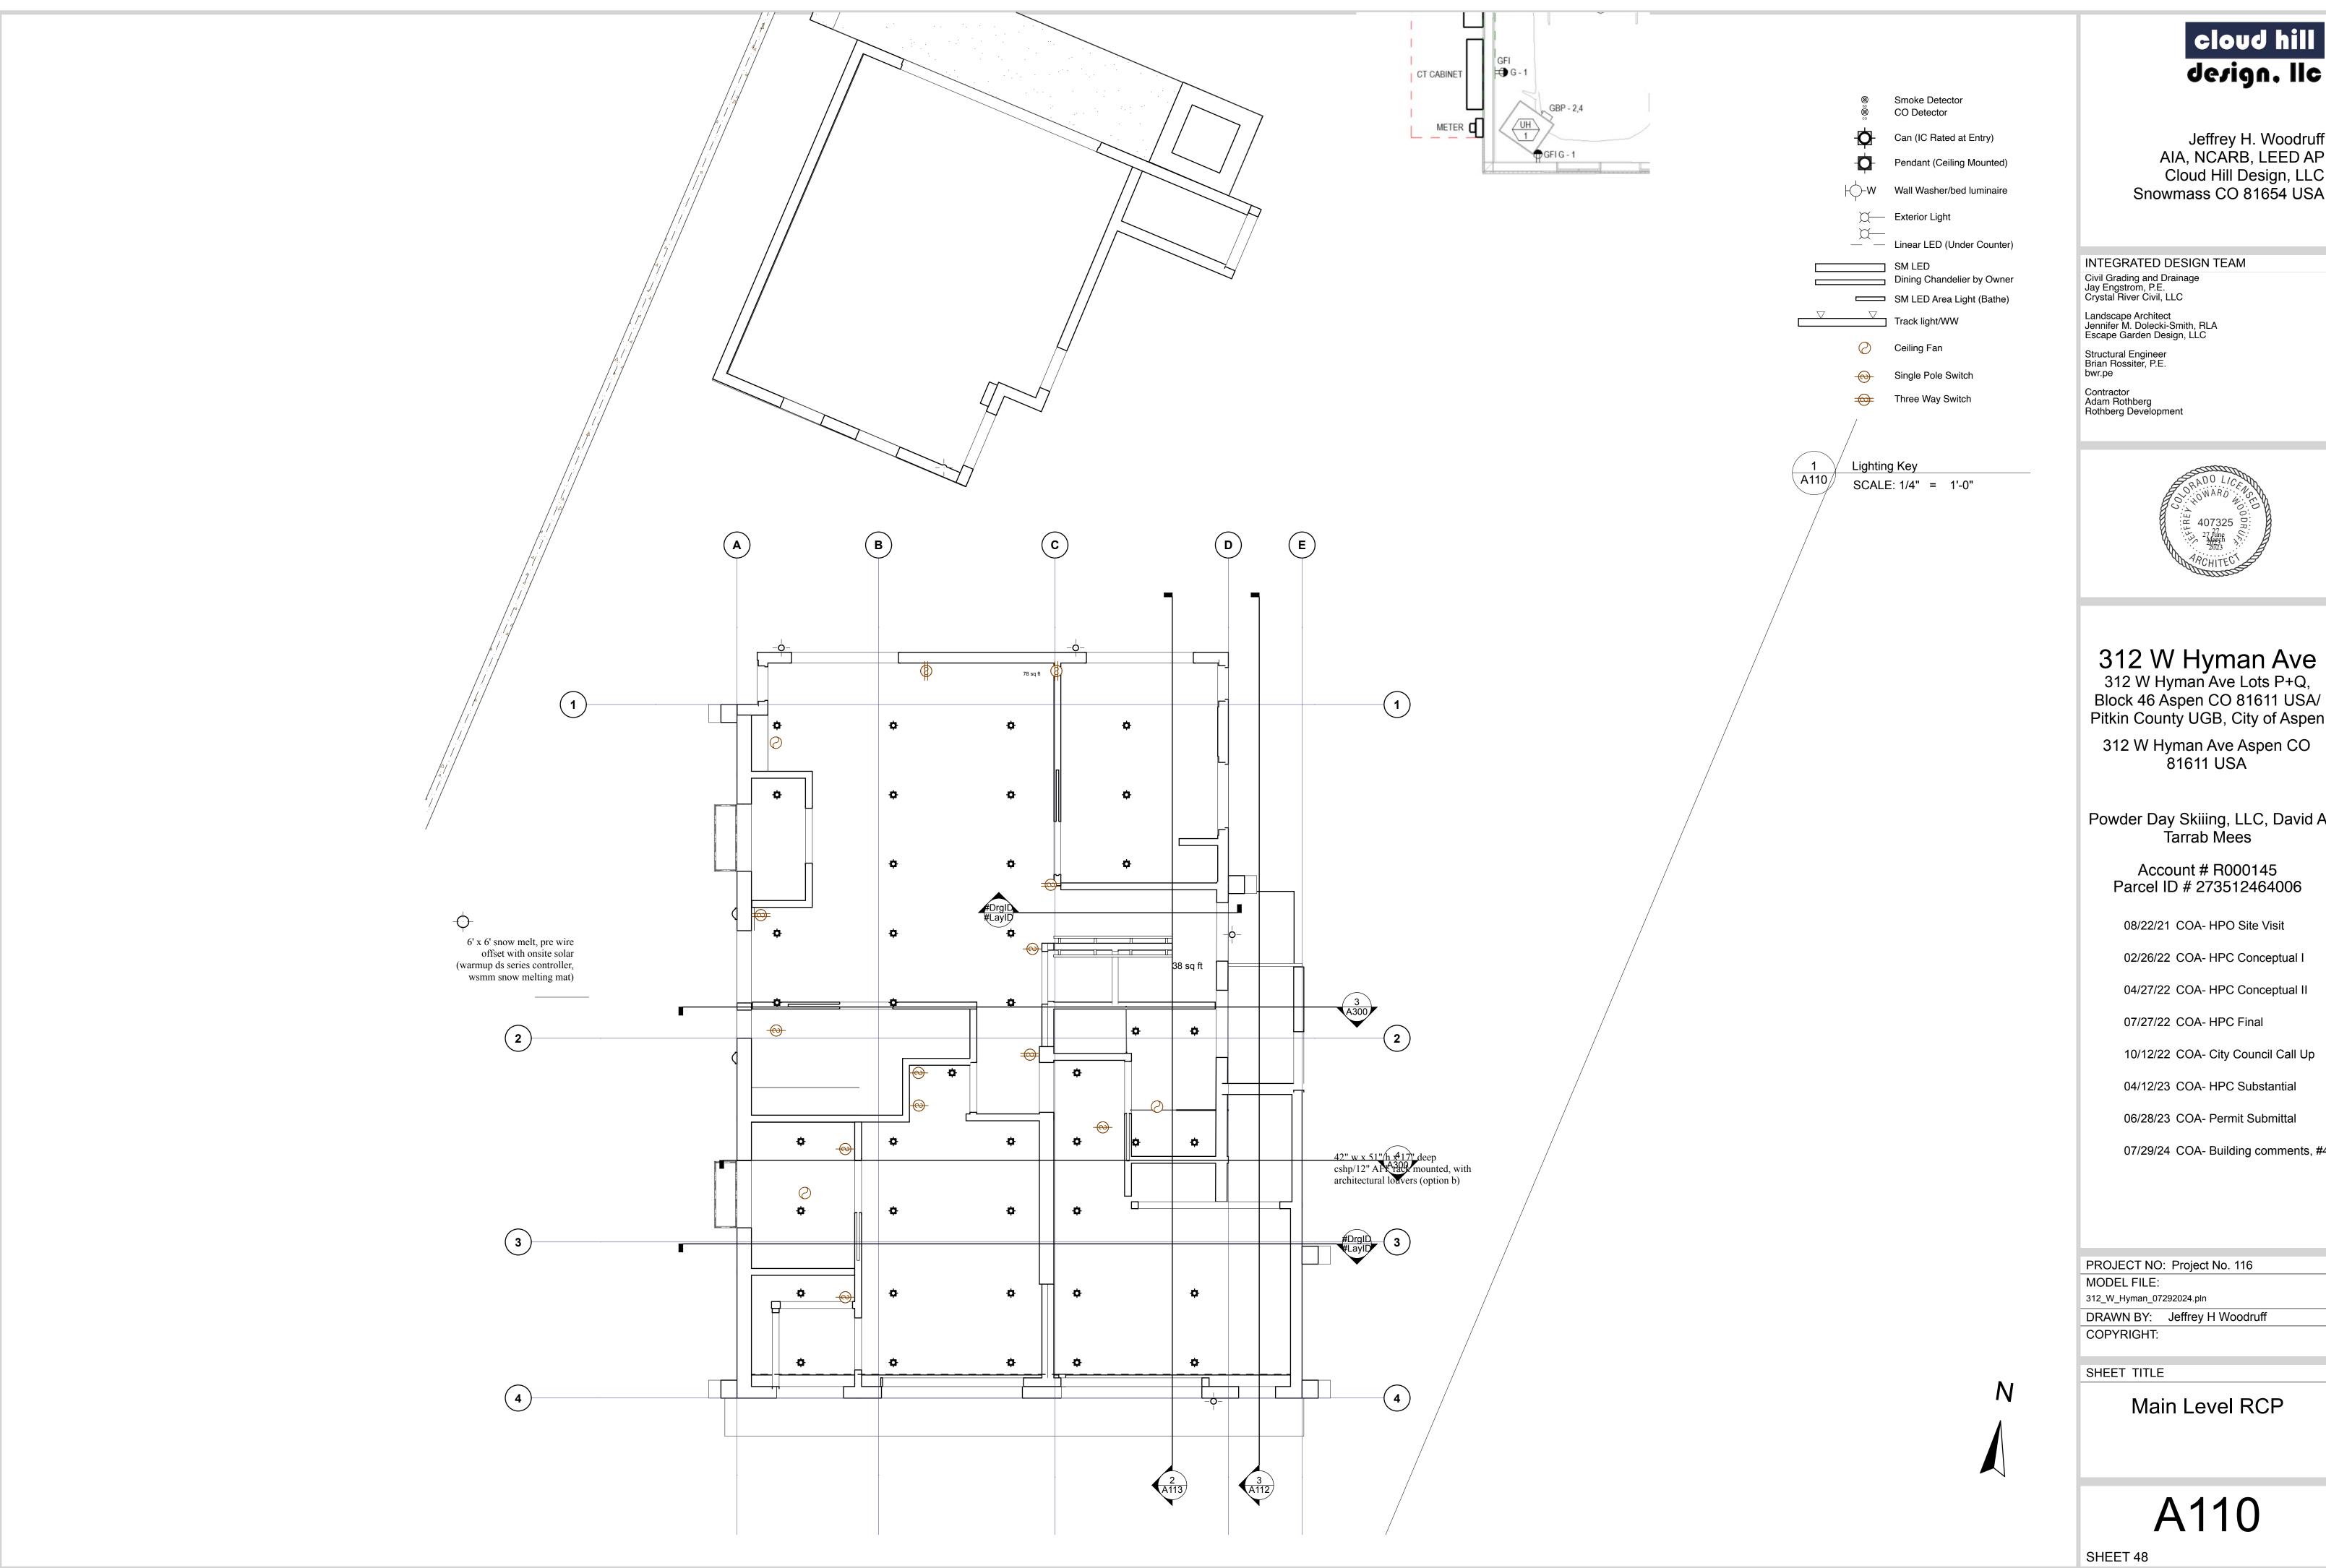

cloud hill design. Ilc

Jeffrey H. Woodruff AIA, NCARB, LEED AP Cloud Hill Design, LLC Snowmass CO 81654 USA



Block 46 Aspen CO 81611 USA/ Pitkin County UGB, City of Aspen

312 W Hyman Ave Aspen CO 81611 USA

Powder Day Skiiing, LLC, David A

Account # R000145 Parcel ID # 273512464006

08/22/21 COA- HPO Site Visit

10/12/22 COA- City Council Call Up

04/12/23 COA- HPC Substantial

06/28/23 COA- Permit Submittal

07/29/24 COA- Building comments, #4

DRAWN BY: Jeffrey H Woodruff

A110

2 First Floor RCP SCALF: 1/4" = 1'-0"



INTEGRATED DESIGN TEAM
Civil Grading and Drainage
Jay Engstrom, P.E.
Crystal River Civil, LLC

Landscape Architect
Jennifer M. Dolecki-Smith, RLA
Escape Garden Design, LLC

Structural Engineer Brian Rossiter, P.E. bwr.pe

Smoke Detector CO Detector

Can (IC Rated at Entry)

- Pendant (Ceiling Mounted)

Linear LED (Under Counter)

_____ Dining Chandelier by Owner

SM LED Area Light (Bathe)

Single Pole Switch

Wall Washer/bed luminaire

C Exterior Light

_____ SM LED

Track light/WW

Lighting Key

Ceiling Fan

Three Way Switch

SCALE: 1/4" = 1'-0"

Contractor Adam Rothberg Rothberg Development



312 W Hyman Ave 312 W Hyman Ave Lots P+Q, Block 46 Aspen CO 81611 USA/ Pitkin County UGB, City of Aspen

312 W Hyman Ave Aspen CO 81611 USA

Powder Day Skiiing, LLC, David A Tarrab Mees

Account # R000145 Parcel ID # 273512464006

08/22/21 COA- HPO Site Visit

02/26/22 COA- HPC Conceptual I

04/27/22 COA- HPC Conceptual II

07/27/22 COA- HPC Final

10/12/22 COA- City Council Call Up

04/12/23 COA- HPC Substantial

06/28/23 COA- Permit Submittal

07/29/24 COA- Building comments, #4

PROJECT NO: Project No. 116

MODEL FILE:
312_W_Hyman_07292024.pln

DRAWN BY: Jeffrey H Woodruff
COPYRIGHT:

SHEET TITLE

Second Level RCP

A111

SHEET 49

N

2 Second Floor RCP

SCALE: 1/4" = 1'-0"

WOOD SIDING, T&G, ASTM E119
STRUCTURAL EXT PLY, DENSGLASS
POSTS, AS PER STRUCT
STRUCTURAL EXT PLY, DENSGLASS
WOOD SIDING, T&G, ASTM E119
TOTAL R-VALUE = NOT HEATED, EXTERIOR DECK

W12 (North Deck Exterior

5

30" DECK ASSEMBLY NORTH BEDROOM

SCALE: 1" = 1'-0"


The existing stairs are moving 4'- 4" to the North, adjacent to door - D 1E.


1011.10 Handrails There is no change to the existing railing. A single 2 x 8" trek board. This matches the historic structure deck railing. As installed by the City of Aspen. 0112.2012. AGGR.

1011.2 Width and capacity: the tread width is 44" clear,

1011.55. the nosing is not less than 1/16"

1011.5.51 nosing projection is 1" beyond the tread below 1011.7 The stringer, no change in the existing structural stringers. The number of treads and risers are unchanged. The stairs are moving 4'-4" to the North to give more habitable space to the new bedroom in the South East corner of the residence.

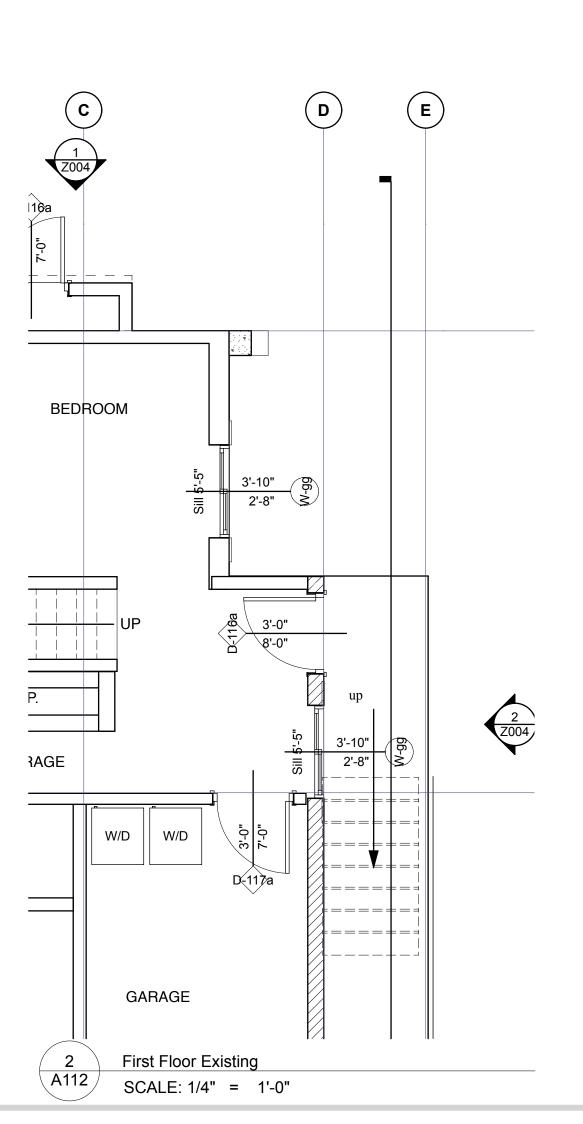

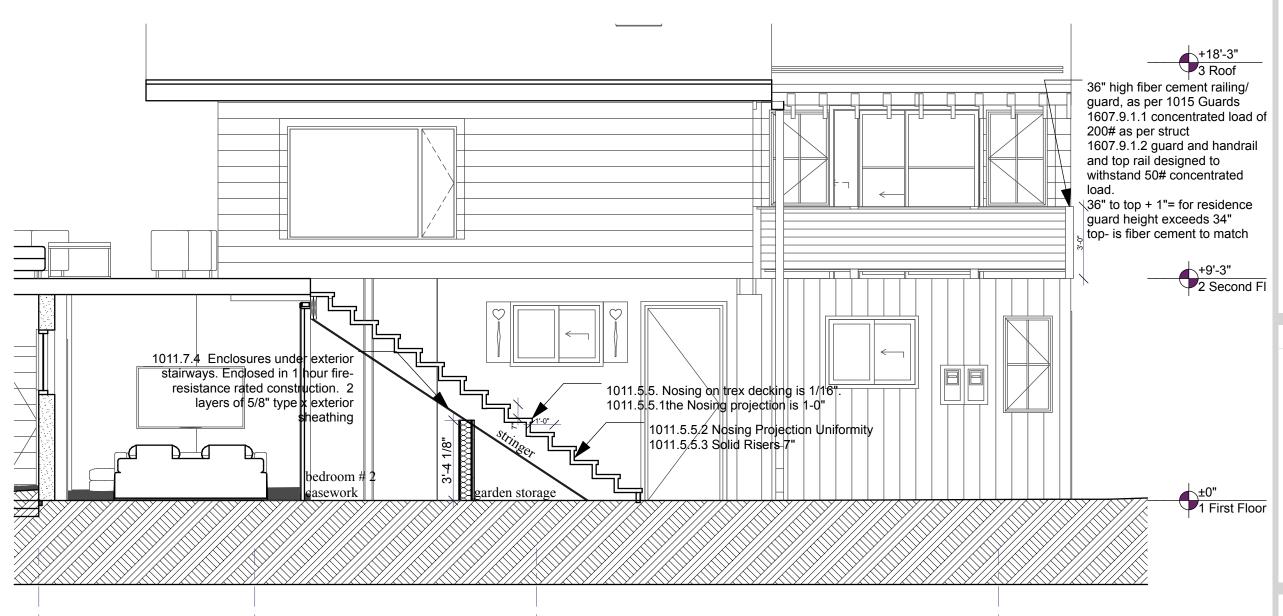

The stairs are moving 4'- 4" to the North, adjacent to door - D


1011.10 Handrails There is no change to the existing railing. A single 2" x 8" trek board. This matches the historic structure deck railing. As installed by the City of Aspen. 0112.2012. AGGR.

1011.2 Width and capacity: the tread width is 44" clear,

1011.55. the nosing is not less than 1/16"

1011.5.51 nosing projection is 1" beyond the tread below

1011.7 The stringer, no change in the existing structural stringers. The number of treads and risers are unchanged. The stairs are moving 4'-4" to the North to give more habitable space to the new bedroom in the South East corner of the residence.

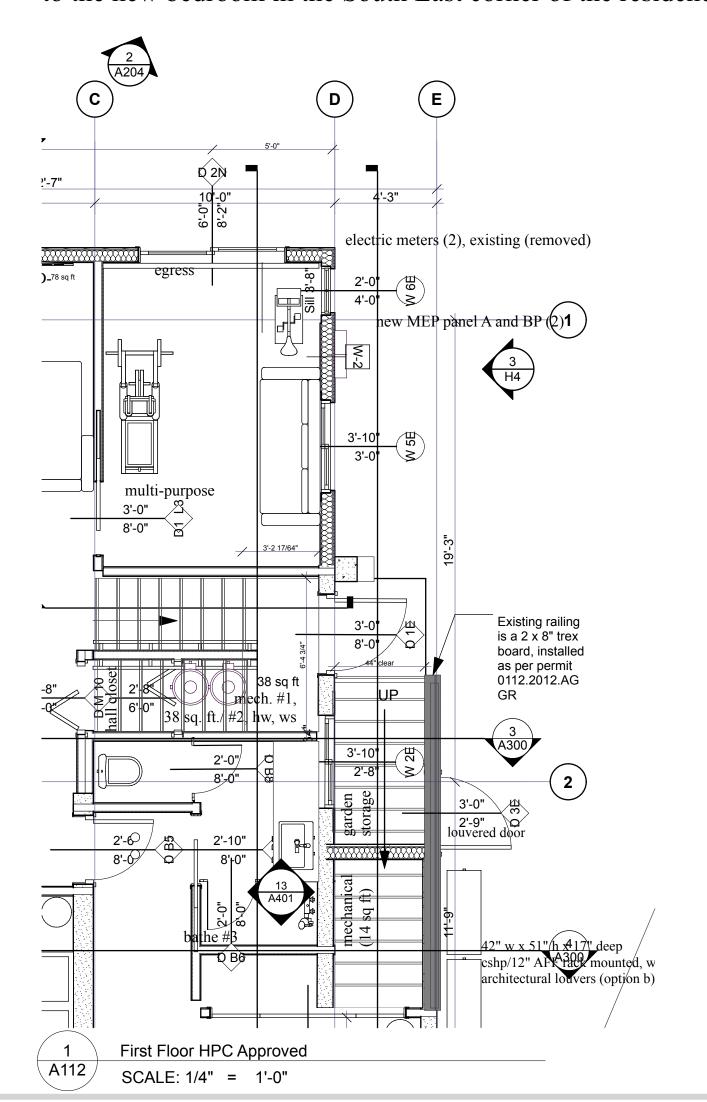



Jeffrey H. Woodruff AIA, NCARB, LEED AP Cloud Hill Design, LLC Snowmass CO 81654 USA

INTEGRATED DESIGN TEAM
Civil Grading and Drainage
Jay Engstrom, P.E.
Crystal River Civil, LLC

Landscape Architect
Jennifer M. Dolecki-Smith, RLA
Escape Garden Design, LLC

Structural Engineer
Brian Rossiter, P.E.

Contractor Adam Rothberg Rothberg Development



312 W Hyman Ave Lots P+Q, Block 46 Aspen CO 81611 USA/

Pitkin County UGB, City of Aspen 312 W Hyman Ave Aspen CO 81611 USA

Powder Day Skiiing, LLC, David A Tarrab Mees

> Account # R000145 Parcel ID # 273512464006

08/22/21 COA- HPO Site Visit

02/26/22 COA- HPC Conceptual I

04/27/22 COA- HPC Conceptual II

07/27/22 COA- HPC Final

10/12/22 COA- City Council Call Up

04/12/23 COA- HPC Substantial

06/28/23 COA- Permit Submittal

07/29/24 COA- Building comments, #4

PROJECT NO: Project No. 116

MODEL FILE:
312_W_Hyman_07292024.pln

DRAWN BY: Jeffrey H Woodruff
COPYRIGHT:


SHEET TITLE

Exterior Stairways
Enlarged

A112

East side of landing is drywall- the East existing door is not visible from the interior of the stairwell. The door is visible from the exterior into the mechanical.

1011.7 Stairway construction Wood handrails with leather stitched wrap handrail

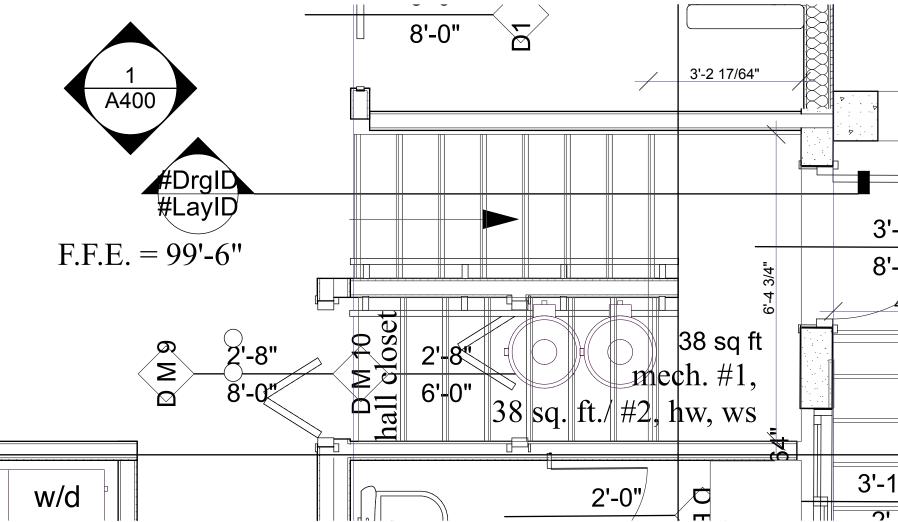

First Floor SCALE: 1/2" = 1'-0"

1011.1 General 1011.5.5 Nosing curvature of 1/16" 1011.5.5.1 Nosing Projection Size .5" Nosing projection 1011.5.4 Dimensional Uniformity Risers vertical, 7" Treads 11" 1011.3 Headroom not less than 80"

maintained, see section, 8'-3" > 80"

cloud hill design. Ilc

Jeffrey H. Woodruff AIA, NCARB, LEED AP Cloud Hill Design, LLC Snowmass CO 81654 USA

Civil Grading and Drainage Jay Engstrom, P.E. Crystal River Civil, LLC Landscape Architect Jennifer M. Dolecki-Smith, RLA Escape Garden Design, LLC Structural Engineer Brian Rossiter, P.E. bwr.pe Contractor Adam Rothberg Rothberg Development

INTEGRATED DESIGN TEAM



312 W Hyman Ave Lots P+Q, Block 46 Aspen CO 81611 USA/ Pitkin County UGB, City of Aspen

312 W Hyman Ave Aspen CO 81611 USA

Powder Day Skiiing, LLC, David A Tarrab Mees

Account # R000145 Parcel ID # 273512464006

08/22/21 COA- HPO Site Visit

02/26/22 COA- HPC Conceptual I

04/27/22 COA- HPC Conceptual II

07/27/22 COA- HPC Final

10/12/22 COA- City Council Call Up

04/12/23 COA- HPC Substantial

06/28/23 COA- Permit Submittal

07/29/24 COA- Building comments, #4

PROJECT NO: Project No. 116

MODEL FILE: 312_W_Hyman_07292024.pln


DRAWN BY: Jeffrey H Woodruff COPYRIGHT:

SHEET TITLE


Interior Stairs Enlarged

A113

SHEET 51

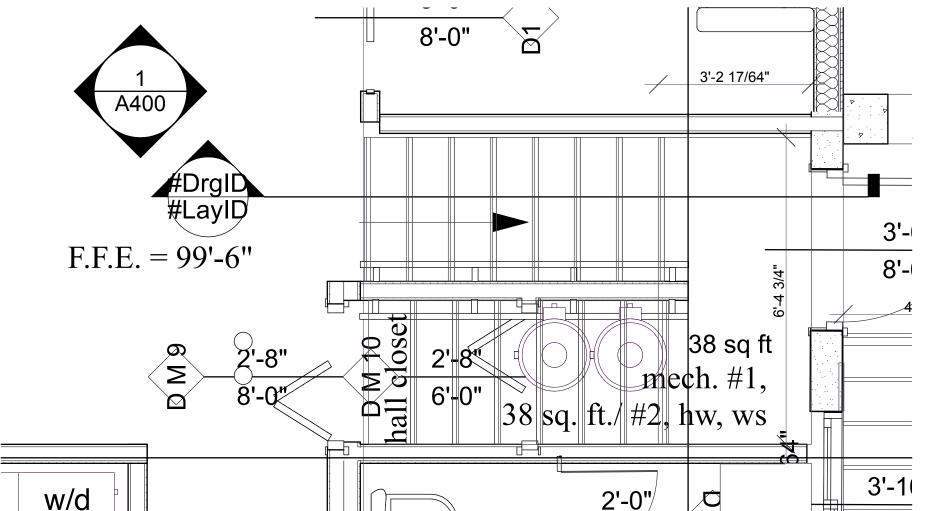



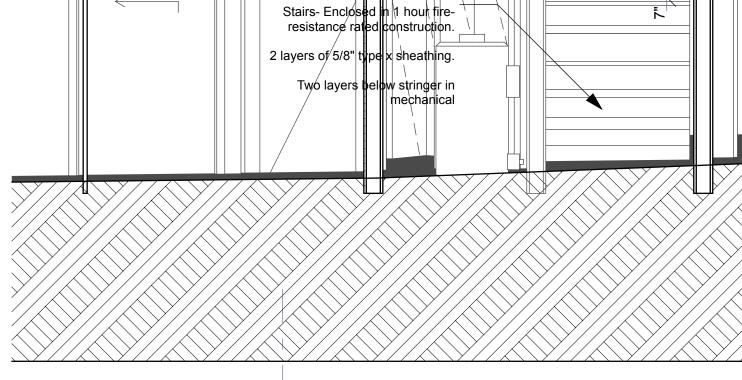

3'-0"

Section at new interior stairs SCALE: 1/2" = 1'-0"

INTEGRATED DESIGN TEAM
Civil Grading and Drainage
Jay Engstrom, P.E.
Crystal River Civil, LLC

Landscape Architect Jennifer M. Dolecki-Smith, RLA Escape Garden Design, LLC

Structural Engineer Brian Rossiter, P.E. bwr.pe

Contractor Adam Rothberg Rothberg Development



312 W Hyman Ave Lots P+Q,

Block 46 Aspen CO 81611 USA/ Pitkin County UGB, City of Aspen

312 W Hyman Ave Aspen CO 81611 USA

Powder Day Skiiing, LLC, David A Tarrab Mees

Account # R000145 Parcel ID # 273512464006

08/22/21 COA- HPO Site Visit

02/26/22 COA- HPC Conceptual I

04/27/22 COA- HPC Conceptual II

07/27/22 COA- HPC Final

10/12/22 COA- City Council Call Up

04/12/23 COA- HPC Substantial

06/28/23 COA- Permit Submittal

07/29/24 COA- Building comments, #4

PROJECT NO: Project No. 116

MODEL FILE:
312_W_Hyman_07292024.pln


DRAWN BY: Jeffrey H Woodruff


COPYRIGHT:


SHEET TITLE


Elevations Proposed

A200

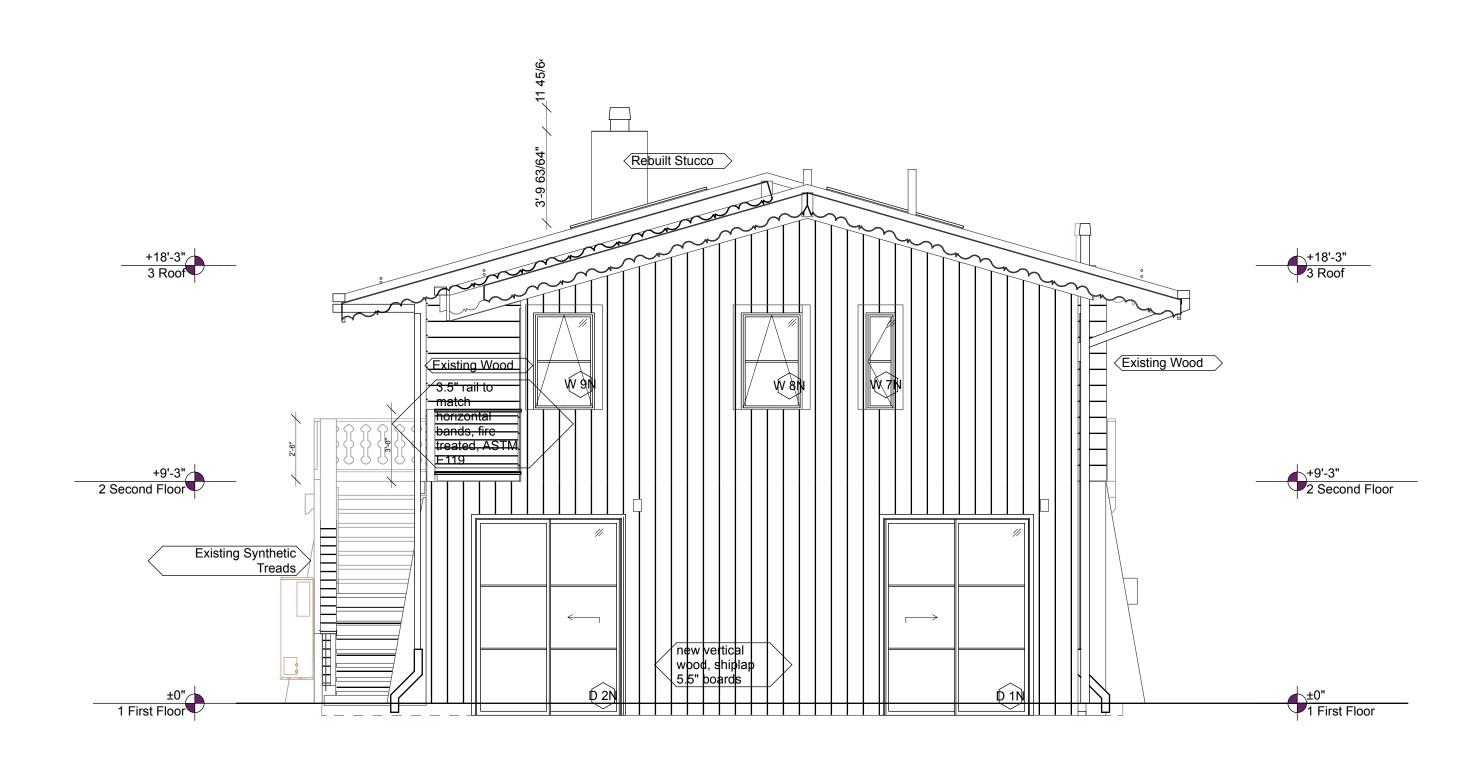


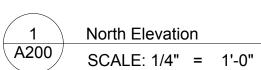

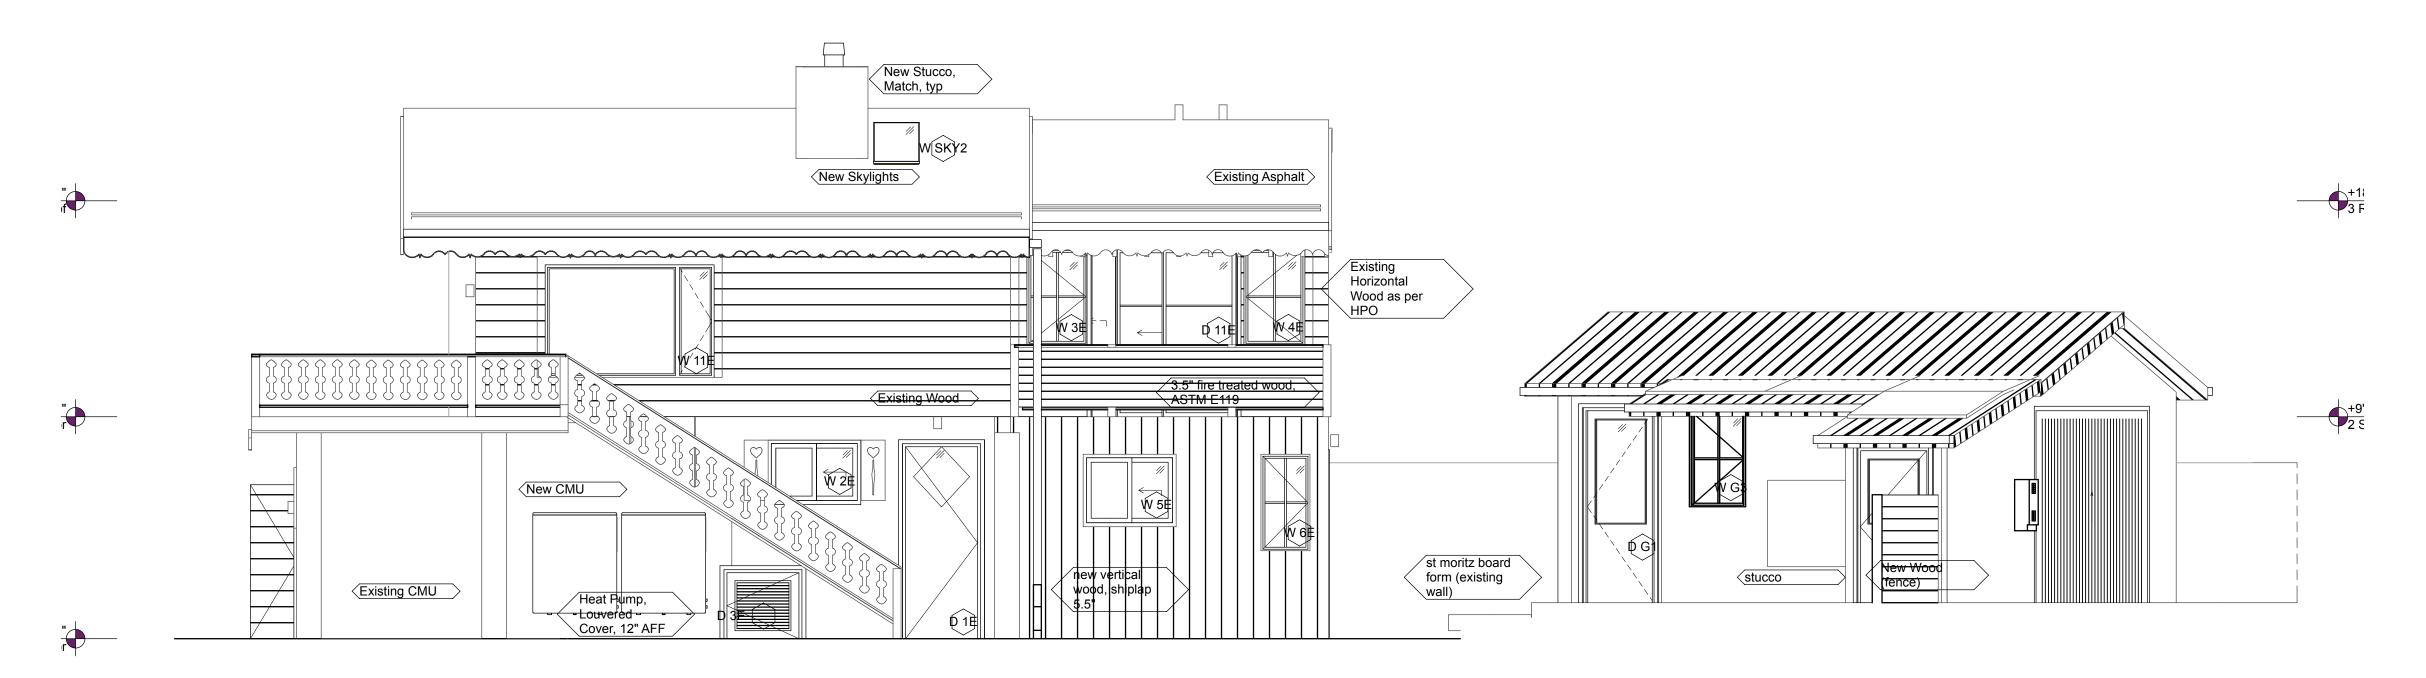

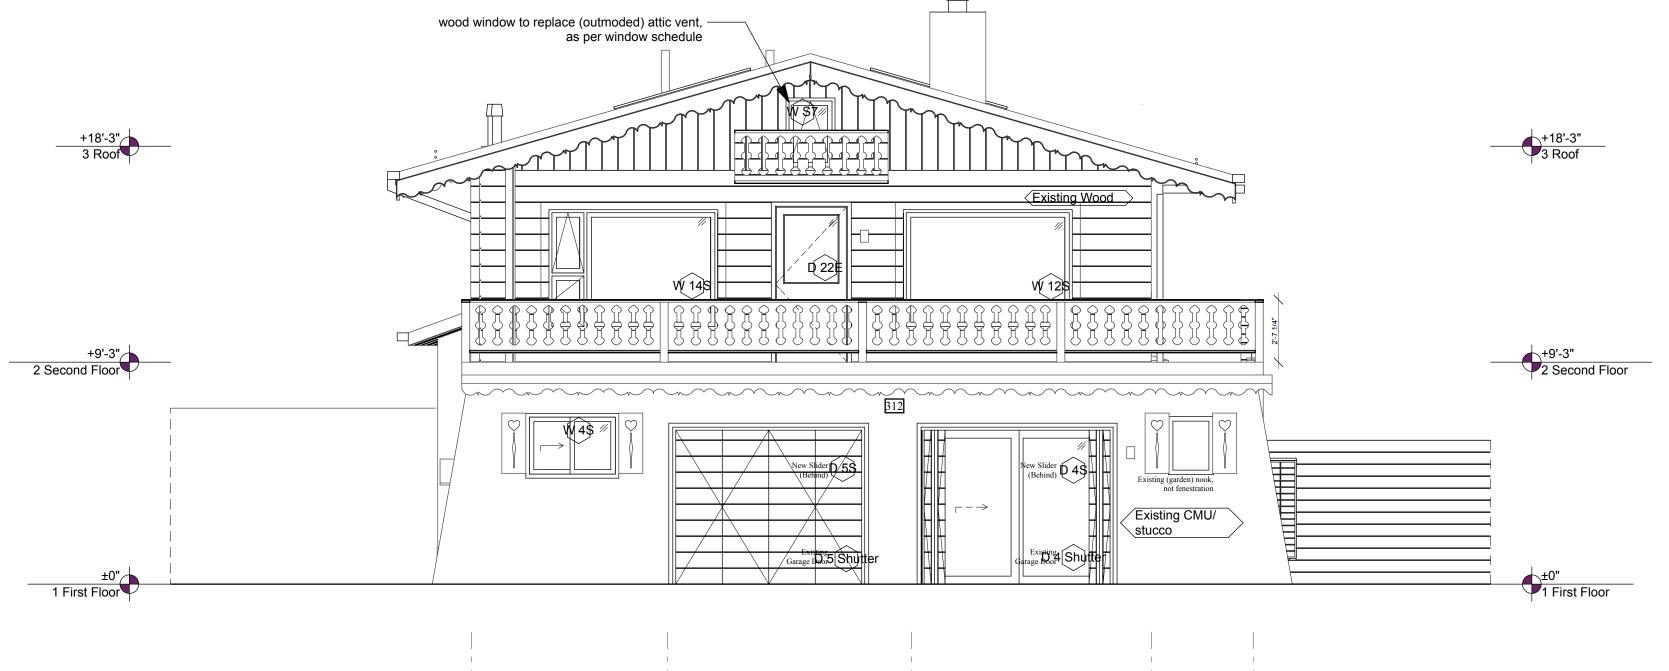

South Elevation
SCALE: 1/4" = 1'-0"

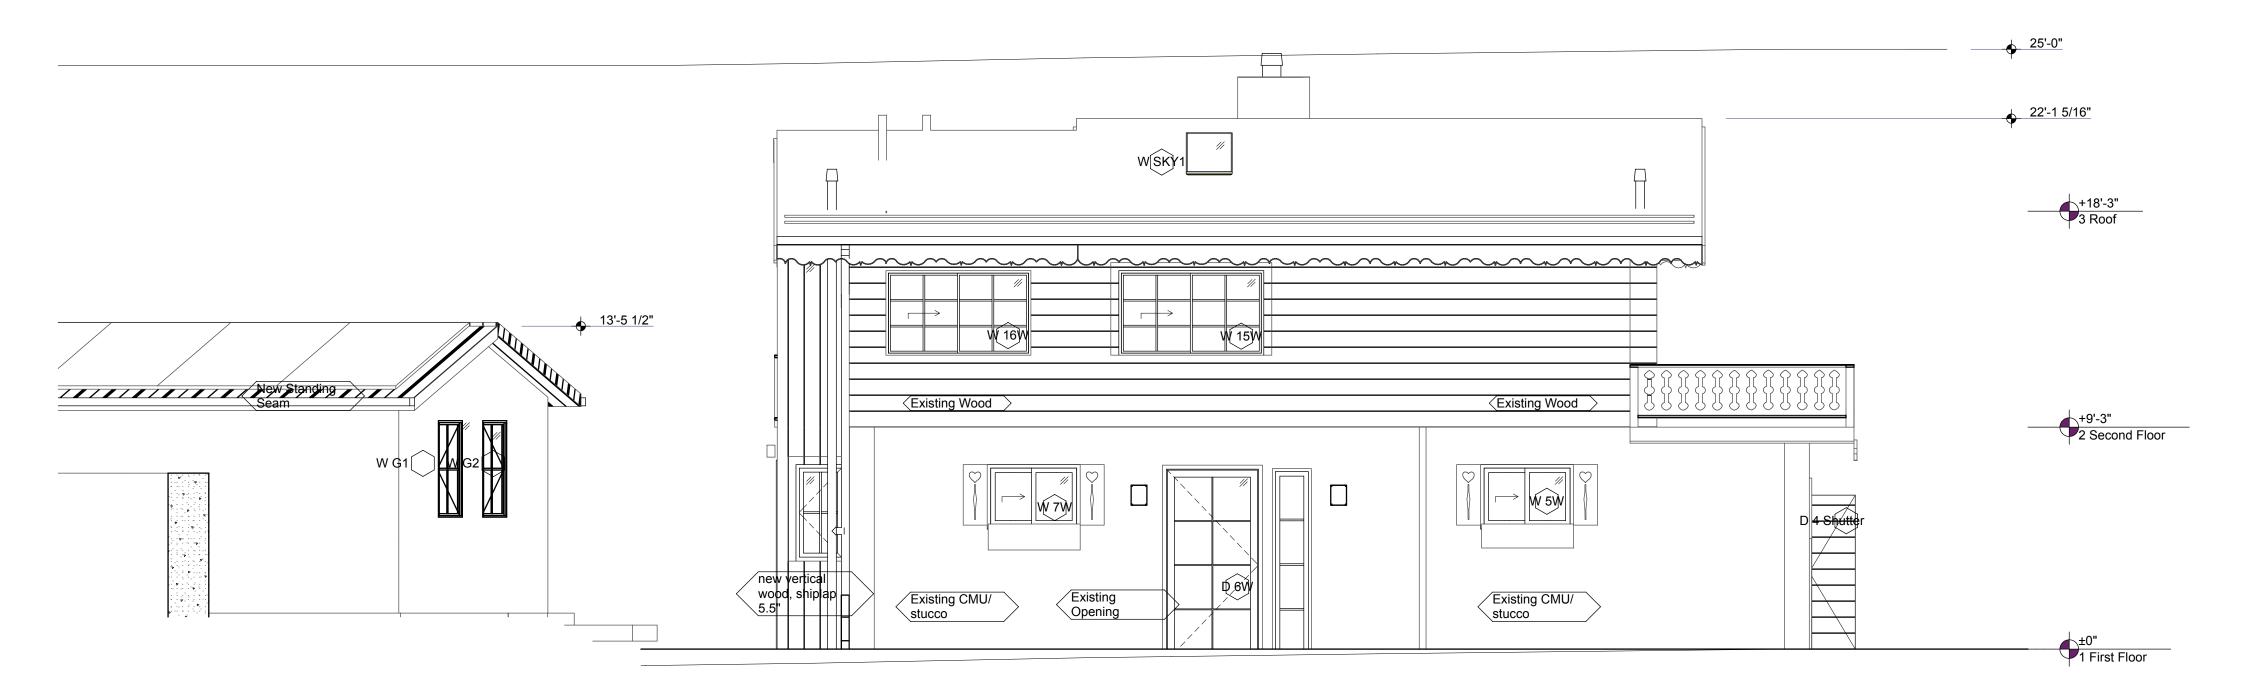

2 West Elevation
A201 SCALE: 1/4" = 1'-0"

cloud hill design, llc

Jeffrey H. Woodruff AIA, NCARB, LEED AP Cloud Hill Design, LLC Snowmass CO 81654 USA

INTEGRATED DESIGN TEAM
Civil Grading and Drainage
Jay Engstrom, P.E.
Crystal River Civil, LLC

Landscape Architect Jennifer M. Dolecki-Smith, RLA Escape Garden Design, LLC Structural Engineer Brian Rossiter, P.E. bwr.pe

Contractor Adam Rothberg Rothberg Development



312 W Hyman Ave Lata B. O

312 W Hyman Ave Lots P+Q, Block 46 Aspen CO 81611 USA/ Pitkin County UGB, City of Aspen

312 W Hyman Ave Aspen CO 81611 USA

Powder Day Skiiing, LLC, David A Tarrab Mees

> Account # R000145 Parcel ID # 273512464006

08/22/21 COA- HPO Site Visit

02/26/22 COA- HPC Conceptual I

04/27/22 COA- HPC Conceptual II

07/27/22 COA- HPC Final

10/12/22 COA- City Council Call Up

04/12/23 COA- HPC Substantial

06/28/23 COA- Permit Submittal

07/29/24 COA- Building comments, #4

PROJECT NO: Project No. 116

MODEL FILE:

DRAWN BY: Jeffrey H Woodruff
COPYRIGHT:

SHEET TITLE

Elevations Proposed

A201



INTEGRATED DESIGN TEAM Civil Grading and Drainage Jay Engstrom, P.E. Crystal River Civil, LLC

Landscape Architect Jennifer M. Dolecki-Smith, RLA Escape Garden Design, LLC Structural Engineer Brian Rossiter, P.E. bwr.pe

Contractor Adam Rothberg Rothberg Development



312 W Hyman Ave 312 W Hyman Ave Lots P+Q, Block 46 Aspen CO 81611 USA/ Pitkin County UGB, City of Aspen

312 W Hyman Ave Aspen CO 81611 USA

Powder Day Skiiing, LLC, David A Tarrab Mees

Account # R000145 Parcel ID # 273512464006

08/22/21 COA- HPO Site Visit

02/26/22 COA- HPC Conceptual I

04/27/22 COA- HPC Conceptual II

07/27/22 COA- HPC Final

10/12/22 COA- City Council Call Up

04/12/23 COA- HPC Substantial

06/28/23 COA- Permit Submittal

07/29/24 COA- Building comments, #4


PROJECT NO: Project No. 116 MODEL FILE: 312_W_Hyman_07292024.pln


DRAWN BY: Jeffrey H Woodruff COPYRIGHT:


SHEET TITLE


Existing Elevations

A202

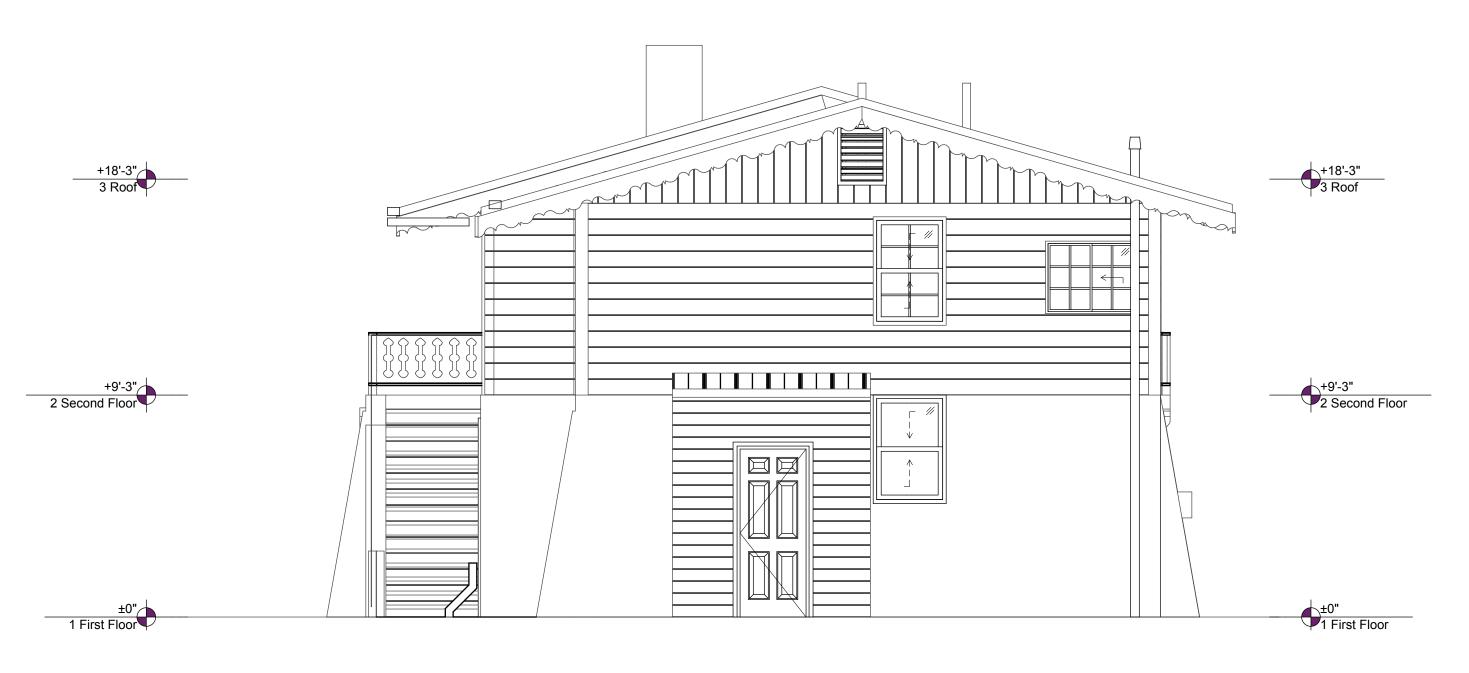

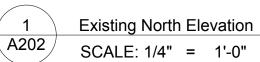

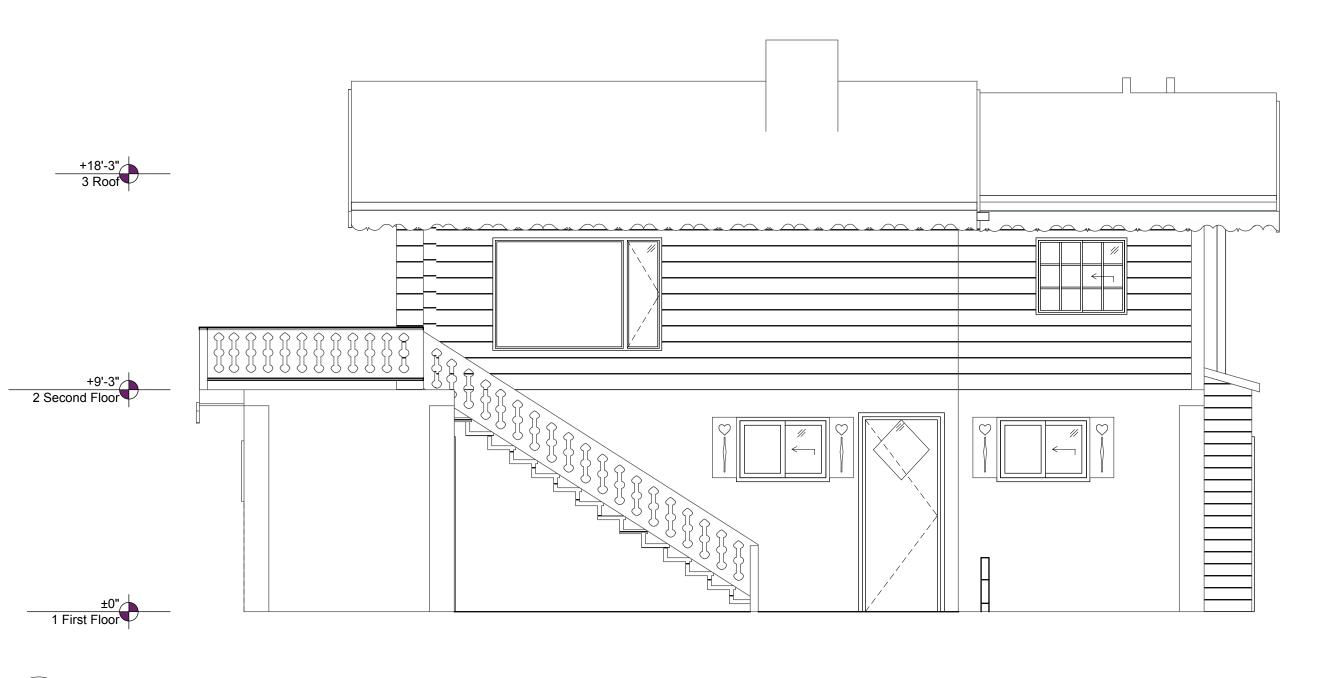

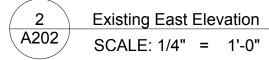

SCALE: 1/4" = 1'-0"



Jeffrey H. Woodruff AIA, NCARB, LEED AP Cloud Hill Design, LLC Snowmass CO 81654 USA

INTEGRATED DESIGN TEAM
Civil Grading and Drainage
Jay Engstrom, P.E.
Crystal River Civil, LLC

Landscape Architect
Jennifer M. Dolecki-Smith, RLA
Escape Garden Design, LLC

Structural Engineer Brian Rossiter, P.E. bwr.pe

Contractor Adam Rothberg Rothberg Development



312 W Hyman Ave 312 W Hyman Ave Lots P+Q,

312 W Hyman Ave Lots P+Q, Block 46 Aspen CO 81611 USA/ Pitkin County UGB, City of Aspen

312 W Hyman Ave Aspen CO 81611 USA

Powder Day Skiiing, LLC, David A Tarrab Mees

> Account # R000145 Parcel ID # 273512464006

08/22/21 COA- HPO Site Visit

02/26/22 COA- HPC Conceptual I

04/27/22 COA- HPC Conceptual II

07/27/22 COA- HPC Final

10/12/22 COA- City Council Call Up

04/12/23 COA- HPC Substantial

06/28/23 COA- Permit Submittal

07/29/24 COA- Building comments, #4

PROJECT NO: Project No. 116


MODEL FILE: 312_W_Hyman_07292024.pln

DRAWN BY: Jeffrey H Woodruff
COPYRIGHT:

SHEET TITLE

Existing Elevations

A203

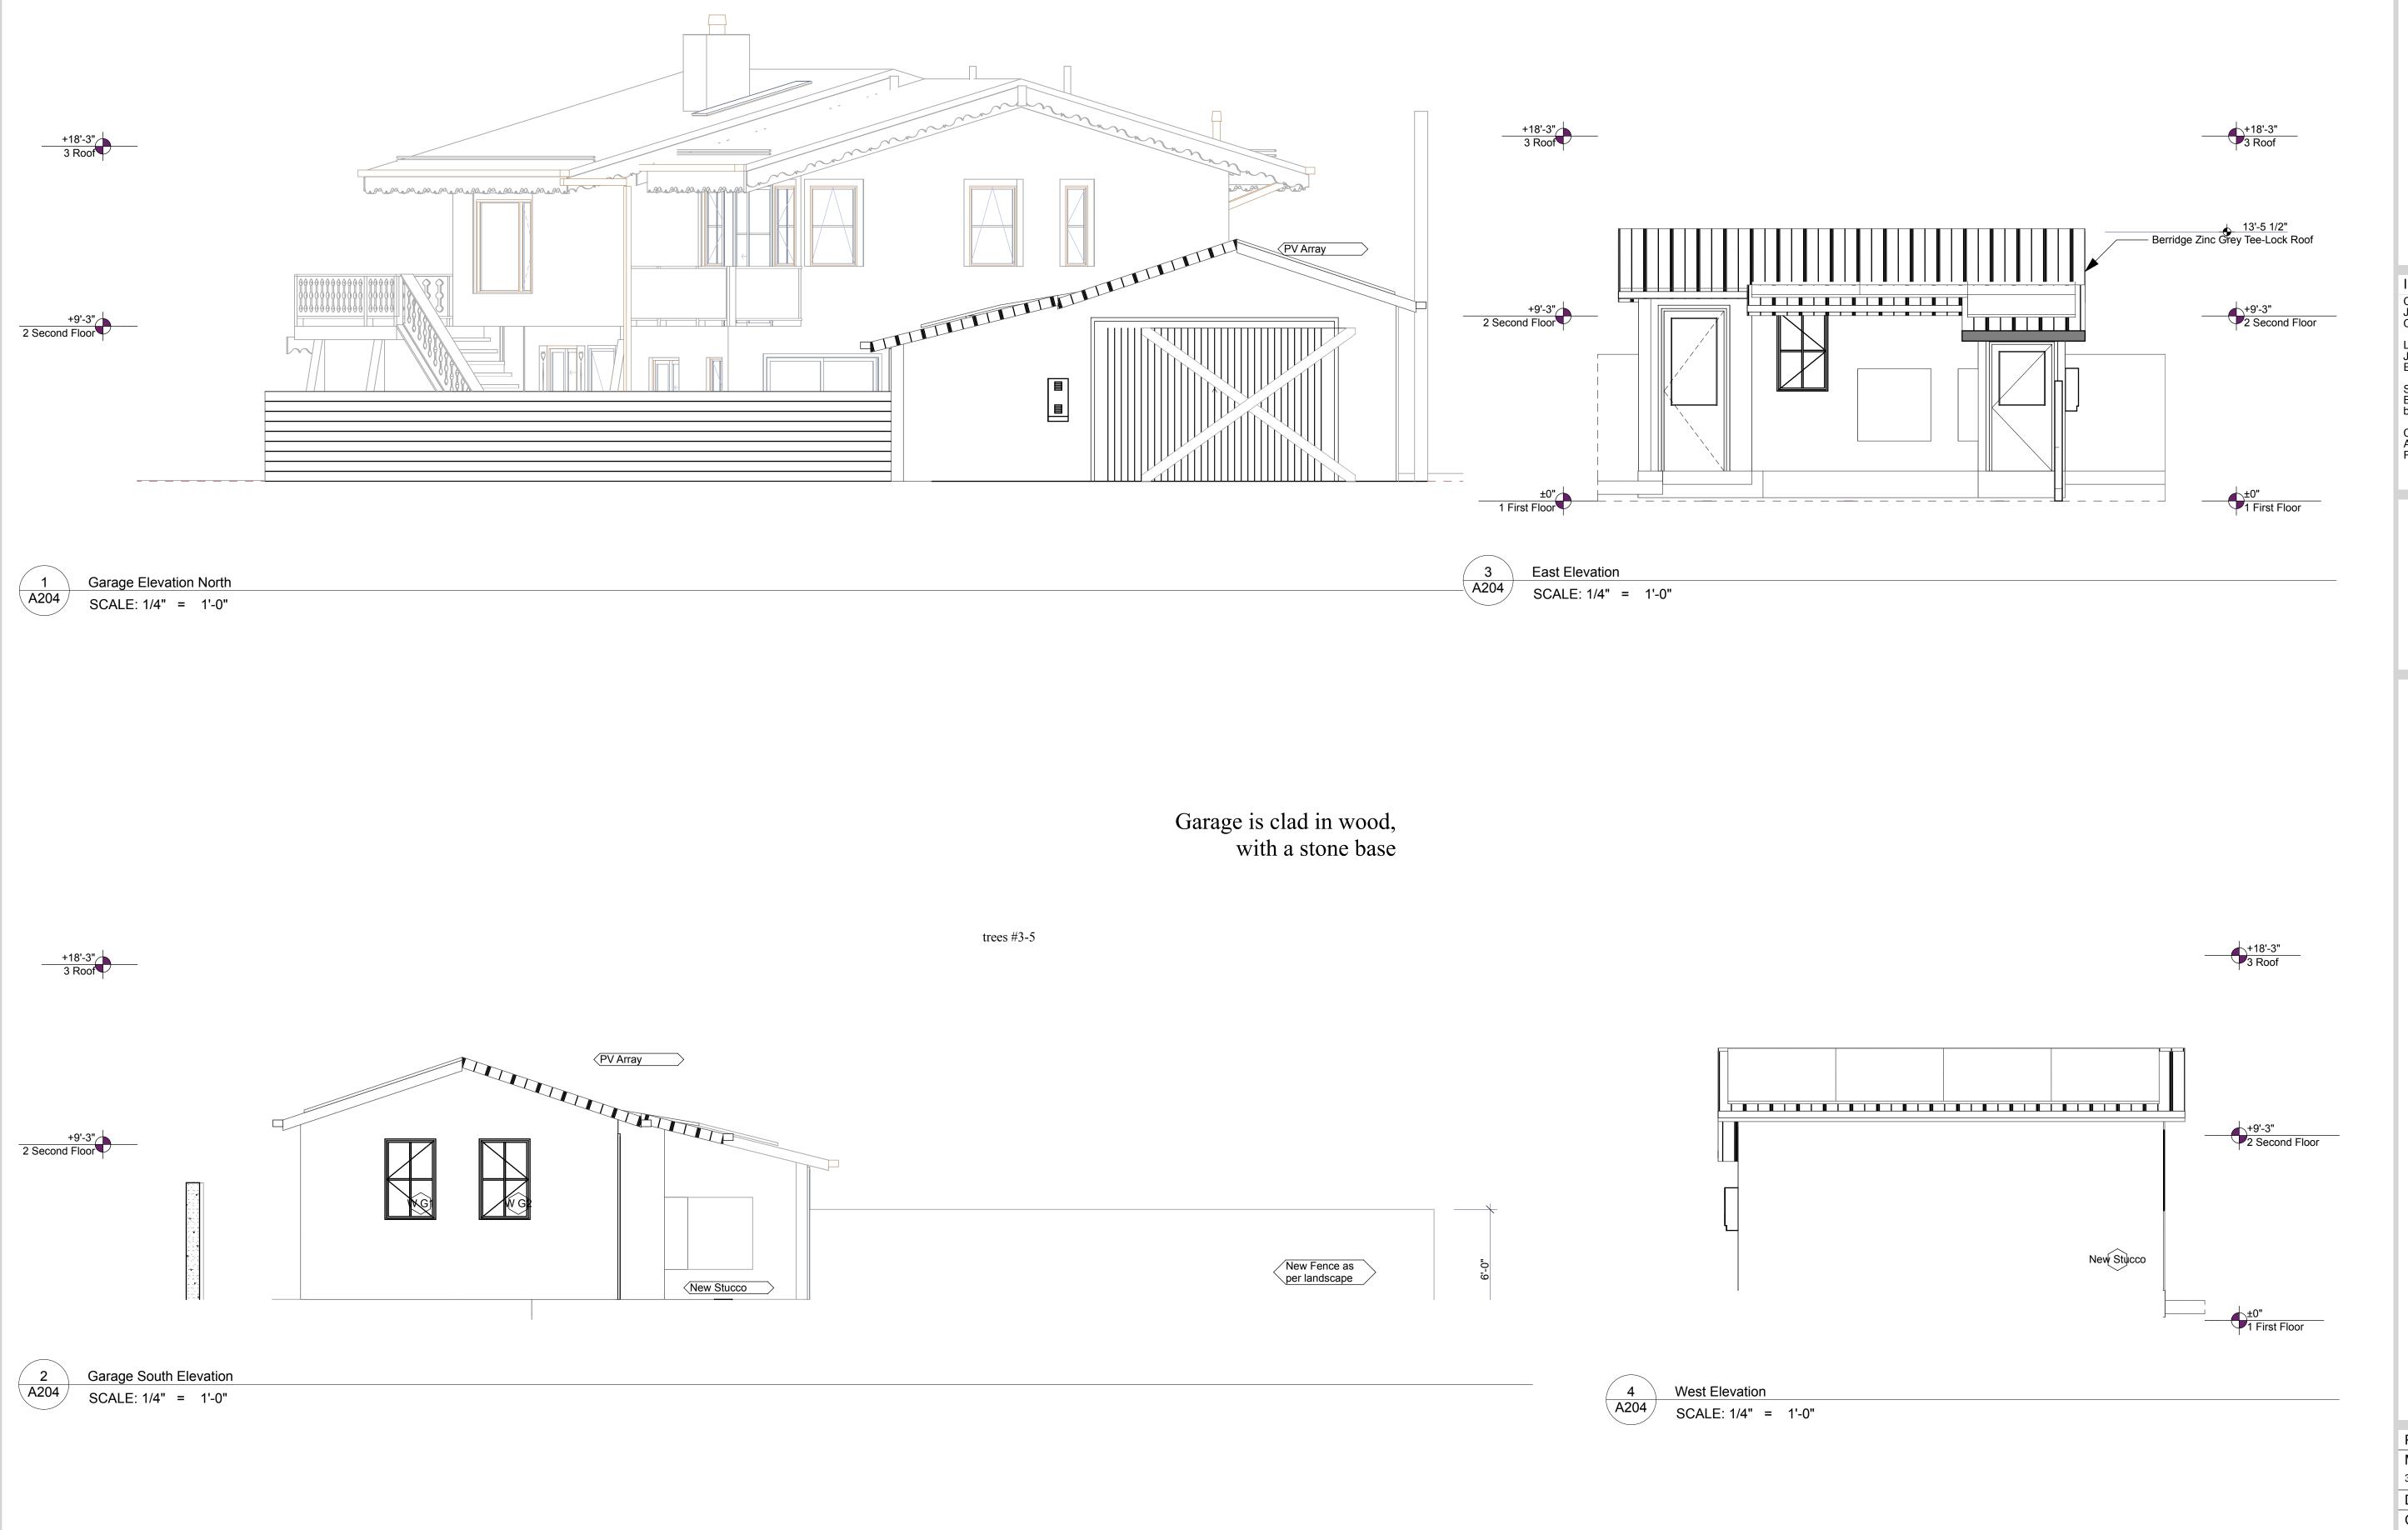

cloud hill design, llc

Jeffrey H. Woodruff AIA, NCARB, LEED AP Cloud Hill Design, LLC Snowmass CO 81654 USA

INTEGRATED DESIGN TEAM
Civil Grading and Drainage

Civil Grading and Drainage
Jay Engstrom, P.E.
Crystal River Civil, LLC

Landscape Architect
Jennifer M. Dolecki-Smith, RLA
Escape Garden Design, LLC

Structural Engineer
Brian Rossiter, P.E.
bwr.pe

Contractor
Adam Rothberg
Rothberg Development



312 W Hyman Ave 312 W Hyman Ave Lots P+Q,

312 W Hyman Ave Lots P+Q, Block 46 Aspen CO 81611 USA/ Pitkin County UGB, City of Aspen

312 W Hyman Ave Aspen CO 81611 USA

Powder Day Skiiing, LLC, David A Tarrab Mees

Account # R000145 Parcel ID # 273512464006

08/22/21 COA- HPO Site Visit

02/26/22 COA- HPC Conceptual I

04/27/22 COA- HPC Conceptual II

07/27/22 COA- HPC Final

10/12/22 COA- City Council Call Up

04/12/23 COA- HPC Substantial

06/28/23 COA- Permit Submittal

07/29/24 COA- Building comments, #4

PROJECT NO: Project No. 116

MODEL FILE: 312_W_Hyman_07292024.pln

DRAWN BY: Jeffrey H Woodruff COPYRIGHT:

SHEET TITLE


Garage Elevations

A204

2 longitudinal at Bedroom #2 and Garden Storage
SCALE: 1/4" = 1'-0"

(4)

3

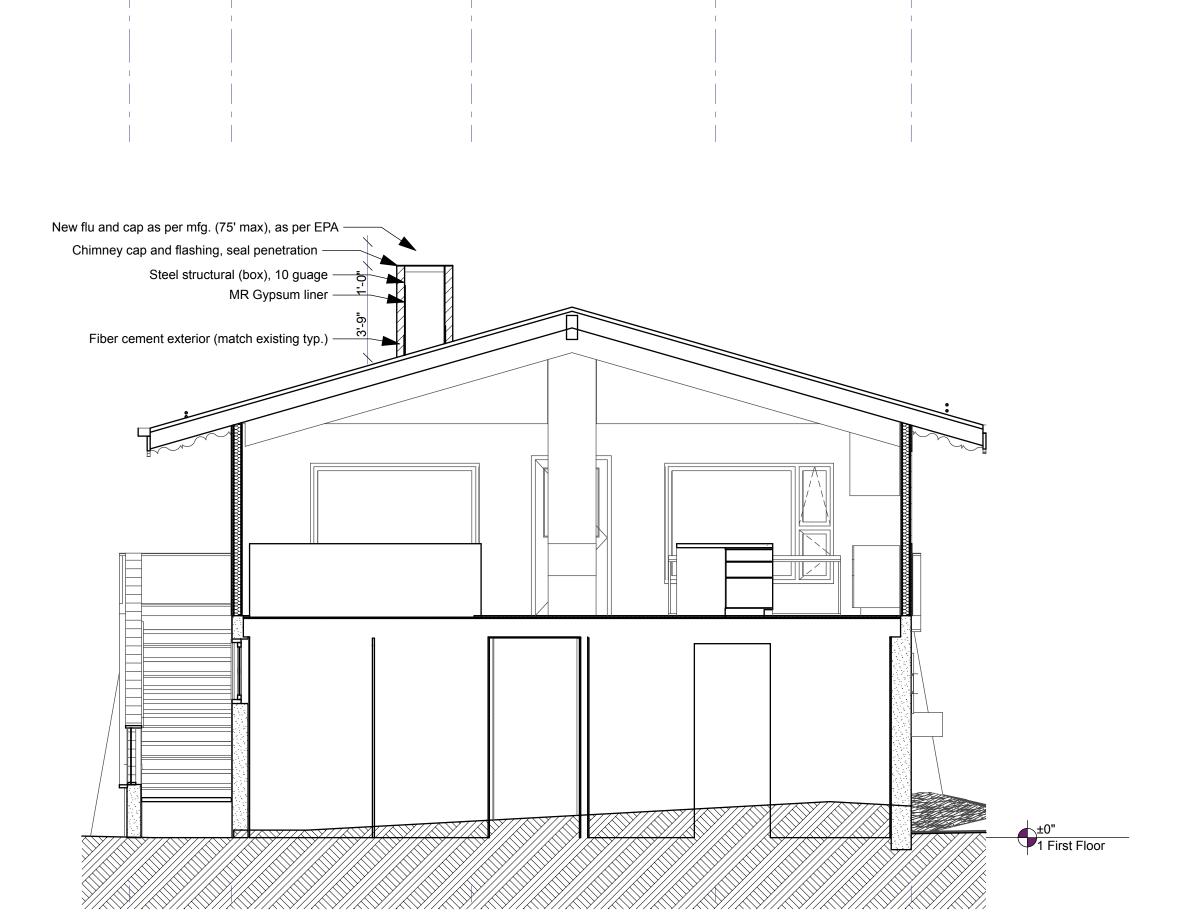



2

Longitudinal at Stairs
SCALE: 1/4" = 1'-0"

cloud hill design. Ilc

Jeffrey H. Woodruff AIA, NCARB, LEED AP Cloud Hill Design, LLC Snowmass CO 81654 USA

INTEGRATED DESIGN TEAM
Civil Grading and Drainage
Jay Engstrom, P.E.
Crystal River Civil, LLC

Landscape Architect Jennifer M. Dolecki-Smith, RLA Escape Garden Design, LLC

Structural Engineer Brian Rossiter, P.E. bwr.pe Contractor Adam Rothberg Rothberg Development

36" high fiber cement railing/ guard, as per 1015 Guards 1607.9.1.1 concentrated load of 200# as per struct 1607.9.1.2 guard and handrail and top rail designed to withstand 50# concentrated

> ±0" 1 First Floor

36" to top + 1"= for residence guard height exceeds 34" top- is fiber cement to match

hberg Development



312 W Hyman Ave Lots P+Q,

Block 46 Aspen CO 81611 USA/ Pitkin County UGB, City of Aspen

312 W Hyman Ave Aspen CO 81611 USA

Powder Day Skiiing, LLC, David A Tarrab Mees

Account # R000145 Parcel ID # 273512464006

08/22/21 COA- HPO Site Visit

02/26/22 COA- HPC Conceptual I

04/27/22 COA- HPC Conceptual II

07/27/22 COA- HPC Final

10/12/22 COA- City Council Call Up

04/12/23 COA- HPC Substantial

06/28/23 COA- Permit Submittal

07/29/24 COA- Building comments, #4

PROJECT NO: Project No. 116

MODEL FILE:
312_W_Hyman_07292024.pln

DRAWN BY: Jeffrey H Woodruff

COPYRIGHT:

SHEET TITLE

Building Sections

A300

SHEET 57

3 A300

transverse at chimney (new)
SCALE: 1/4" = 1'-0"

SCALE: 1/4" = 1'-0"

D

E

 \bigcirc



cloud hill design, llc

Jeffrey H. Woodruff AIA, NCARB, LEED AP Cloud Hill Design, LLC Snowmass CO 81654 USA

INTEGRATED DESIGN TEAM
Civil Grading and Drainage
Jay Engstrom, P.E.
Crystal River Civil, LLC

Landscape Architect
Jennifer M. Dolecki-Smith, RLA
Escape Garden Design, LLC

Structural Engineer
Brian Rossiter, P.E.
bwr.pe

Contractor Adam Rothberg Rothberg Development



312 W Hyman Ave
312 W Hyman Ave Lots P+Q,
Block 46 Aspen CO 81611 USA/
Pitkin County UGB, City of Aspen

312 W Hyman Ave Aspen CO 81611 USA

Powder Day Skiiing, LLC, David A Tarrab Mees

Account # R000145 Parcel ID # 273512464006

00/00/04 004 1170 07 1/

08/22/21 COA- HPO Site Visit

02/26/22 COA- HPC Conceptual I

04/27/22 COA- HPC Conceptual II

07/27/22 COA- HPC Final

10/12/22 COA- City Council Call Up

04/12/23 COA- HPC Substantial

06/28/23 COA- Permit Submittal

07/29/24 COA- Building comments, #4

PROJECT NO: Project No. 116

MODEL FILE: 312_W_Hyman_07292024.pln

DRAWN BY: Jeffrey H Woodruff COPYRIGHT:

SHEET TITLE

Interior Elevations

A400



cloud hill design, llc

Jeffrey H. Woodruff AIA, NCARB, LEED AP Cloud Hill Design, LLC Snowmass CO 81654 USA

INTEGRATED DESIGN TEAM
Civil Grading and Drainage
Jay Engstrom, P.E.
Crystal River Civil, LLC

Landscape Architect
Jennifer M. Dolecki-Smith, RLA
Escape Garden Design, LLC

Structural Engineer
Brian Rossiter, P.E.
bwr.pe

Contractor Adam Rothberg Rothberg Development



312 W Hyman Ave 312 W Hyman Ave Lots P+Q,

Block 46 Aspen CO 81611 USA/ Pitkin County UGB, City of Aspen

312 W Hyman Ave Aspen CO 81611 USA

Powder Day Skiiing, LLC, David A Tarrab Mees

Account # R000145 Parcel ID # 273512464006

1 4100115 # 27001210

08/22/21 COA- HPO Site Visit

02/26/22 COA- HPC Conceptual I

04/27/22 COA- HPC Conceptual II

07/27/22 COA- HPC Final

10/12/22 COA- City Council Call Up

04/12/23 COA- HPC Substantial

06/28/23 COA- Permit Submittal

07/29/24 COA- Building comments, #4

PROJECT NO: Project No. 116


MODEL FILE: 312_W_Hyman_07292024.pln


DRAWN BY: Jeffrey H Woodruff COPYRIGHT:

SHEET TITLE

Interior Elevations

A401

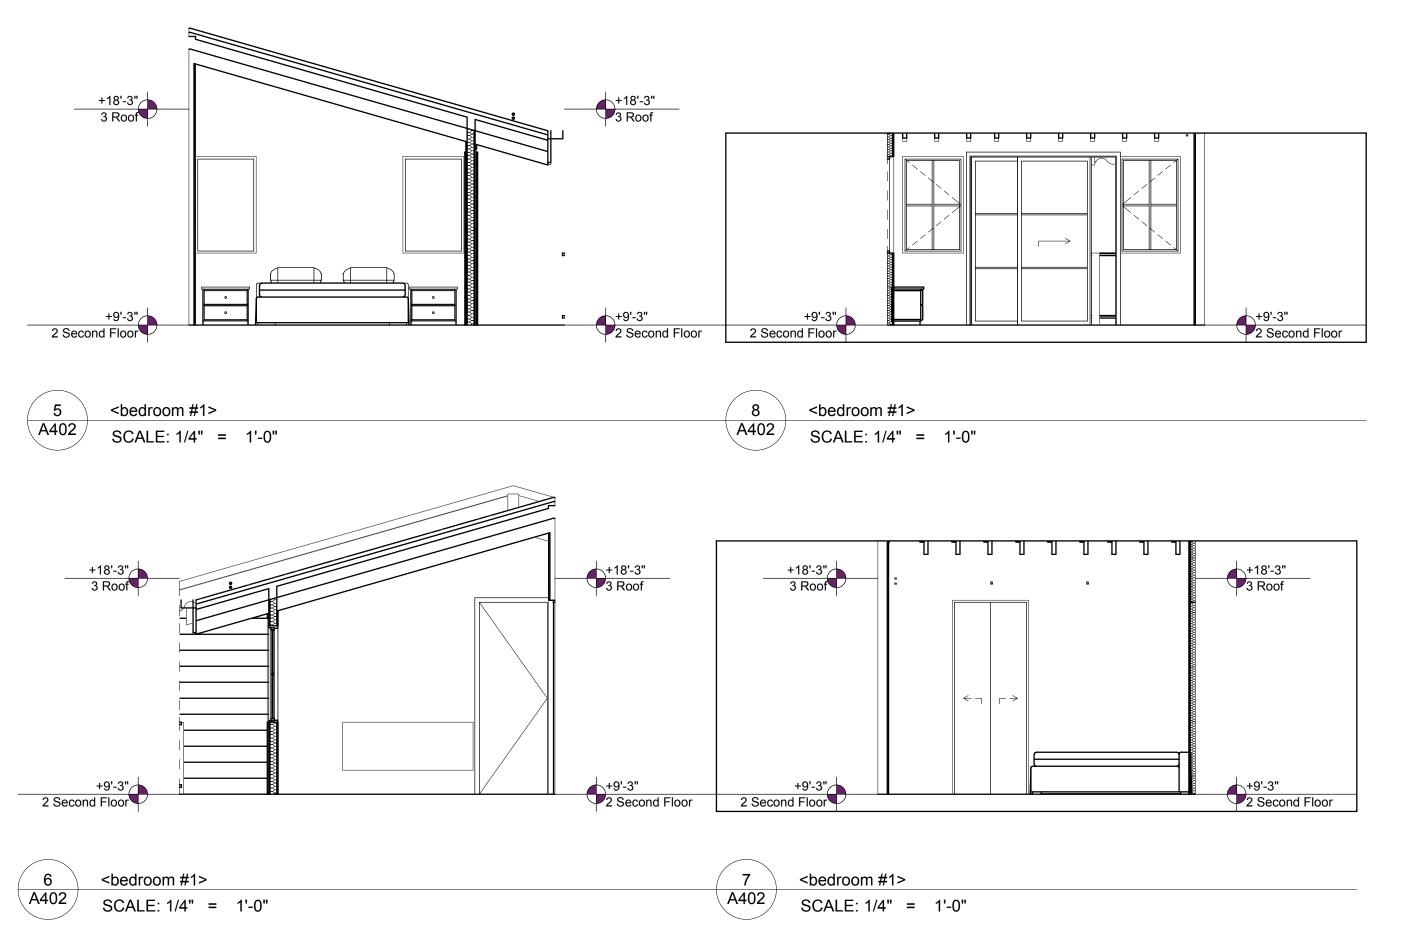

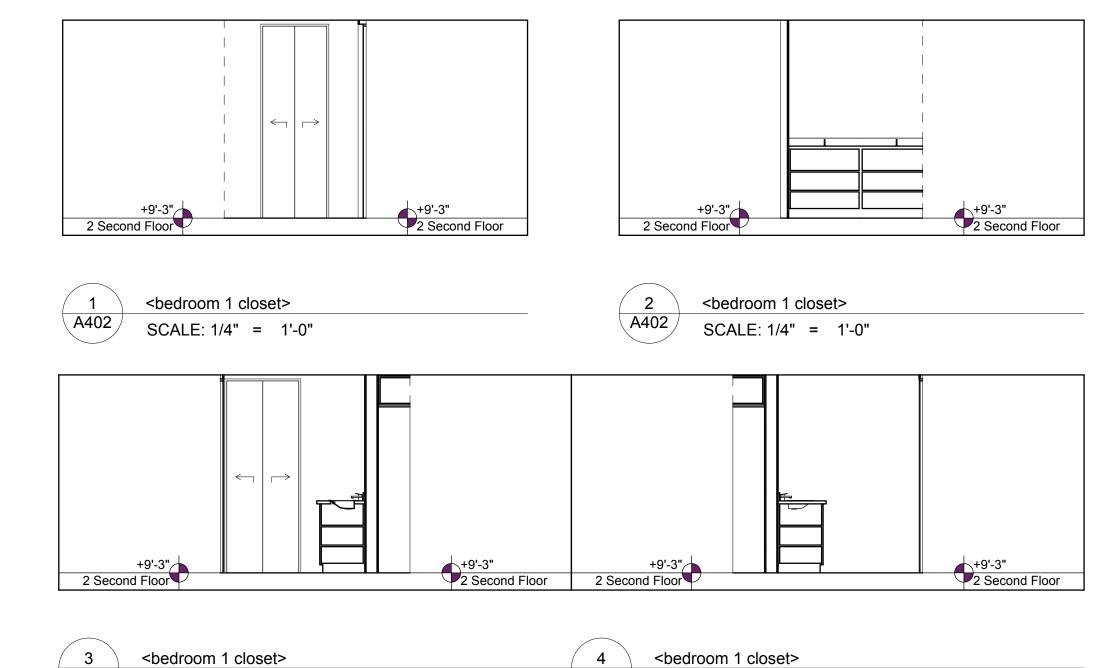

SCALE: 1/4" = 1'-0"



Jeffrey H. Woodruff AIA, NCARB, LEED AP Cloud Hill Design, LLC Snowmass CO 81654 USA

INTEGRATED DESIGN TEAM
Civil Grading and Drainage
Jay Engstrom, P.E.
Crystal River Civil, LLC

Landscape Architect
Jennifer M. Dolecki-Smith, RLA
Escape Garden Design, LLC

Structural Engineer
Brian Rossiter, P.E.
bwr.pe

Contractor Adam Rothberg Rothberg Development



312 W Hyman Ave Lots P+Q,

Block 46 Aspen CO 81611 USA/ Pitkin County UGB, City of Aspen 312 W Hyman Ave Aspen CO

81611 USA

Powder Day Skiiing, LLC, David A Tarrab Mees

> Account # R000145 Parcel ID # 273512464006

08/22/21 COA- HPO Site Visit

02/26/22 COA- HPC Conceptual I

04/27/22 COA- HPC Conceptual II

07/27/22 COA- HPC Final

10/12/22 COA- City Council Call Up

04/12/23 COA- HPC Substantial

06/28/23 COA- Permit Submittal

07/29/24 COA- Building comments, #4

PROJECT NO: Project No. 116

MODEL FILE:
312_W_Hyman_07292024.pln

DRAWN BY: Jeffrey H Woodruff


SHEET TITLE

COPYRIGHT:


Interior Elevations

A402

SHEET 60

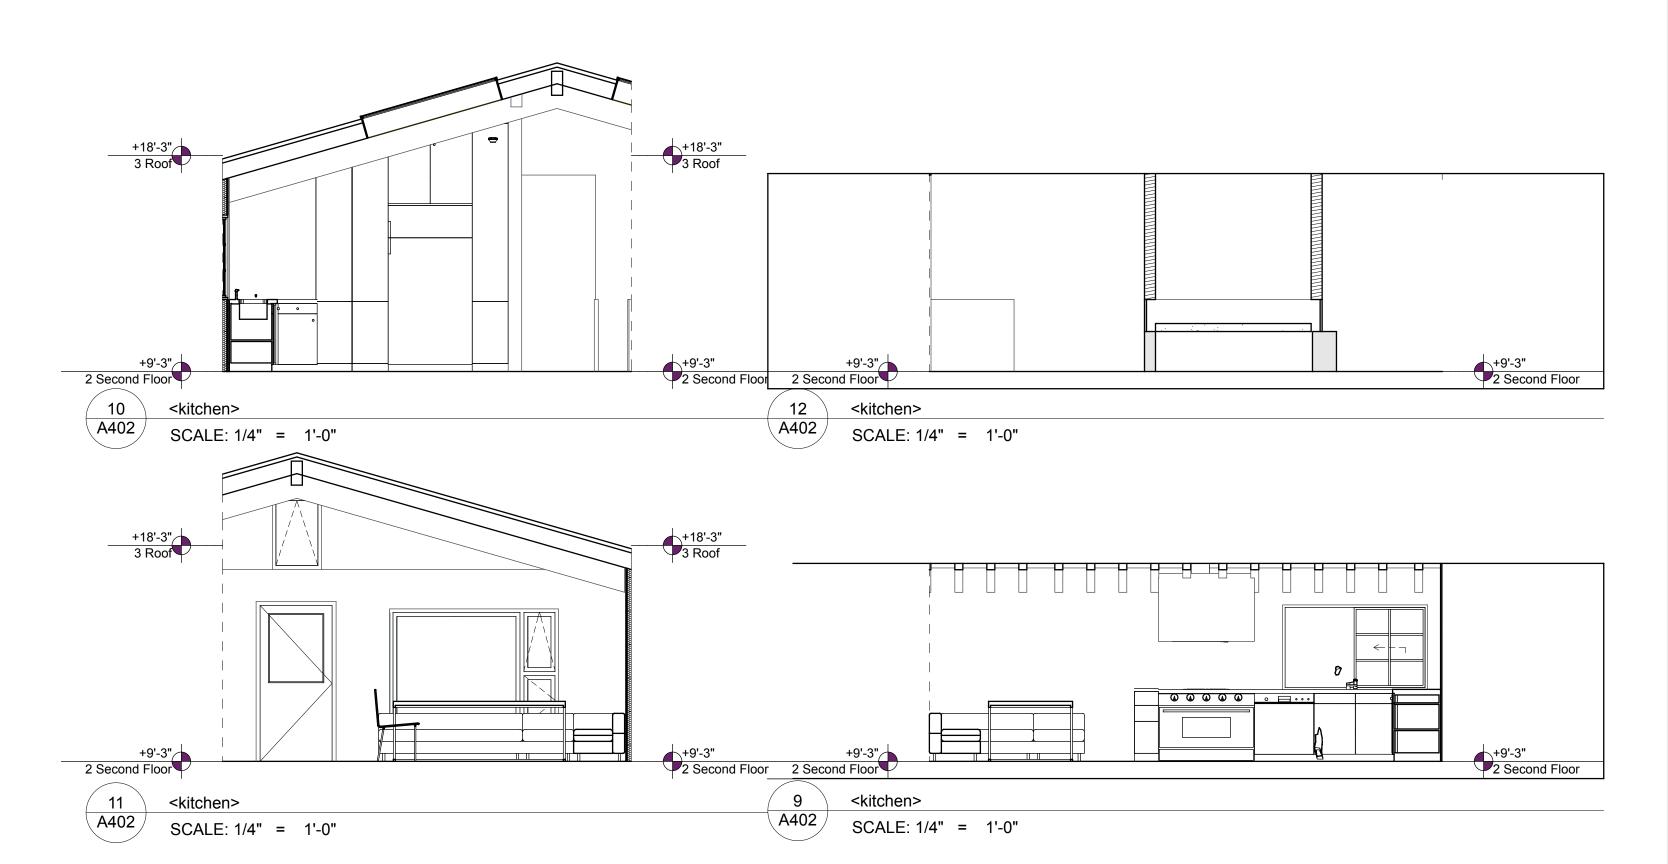

SCALE: 1/4" = 1'-0"

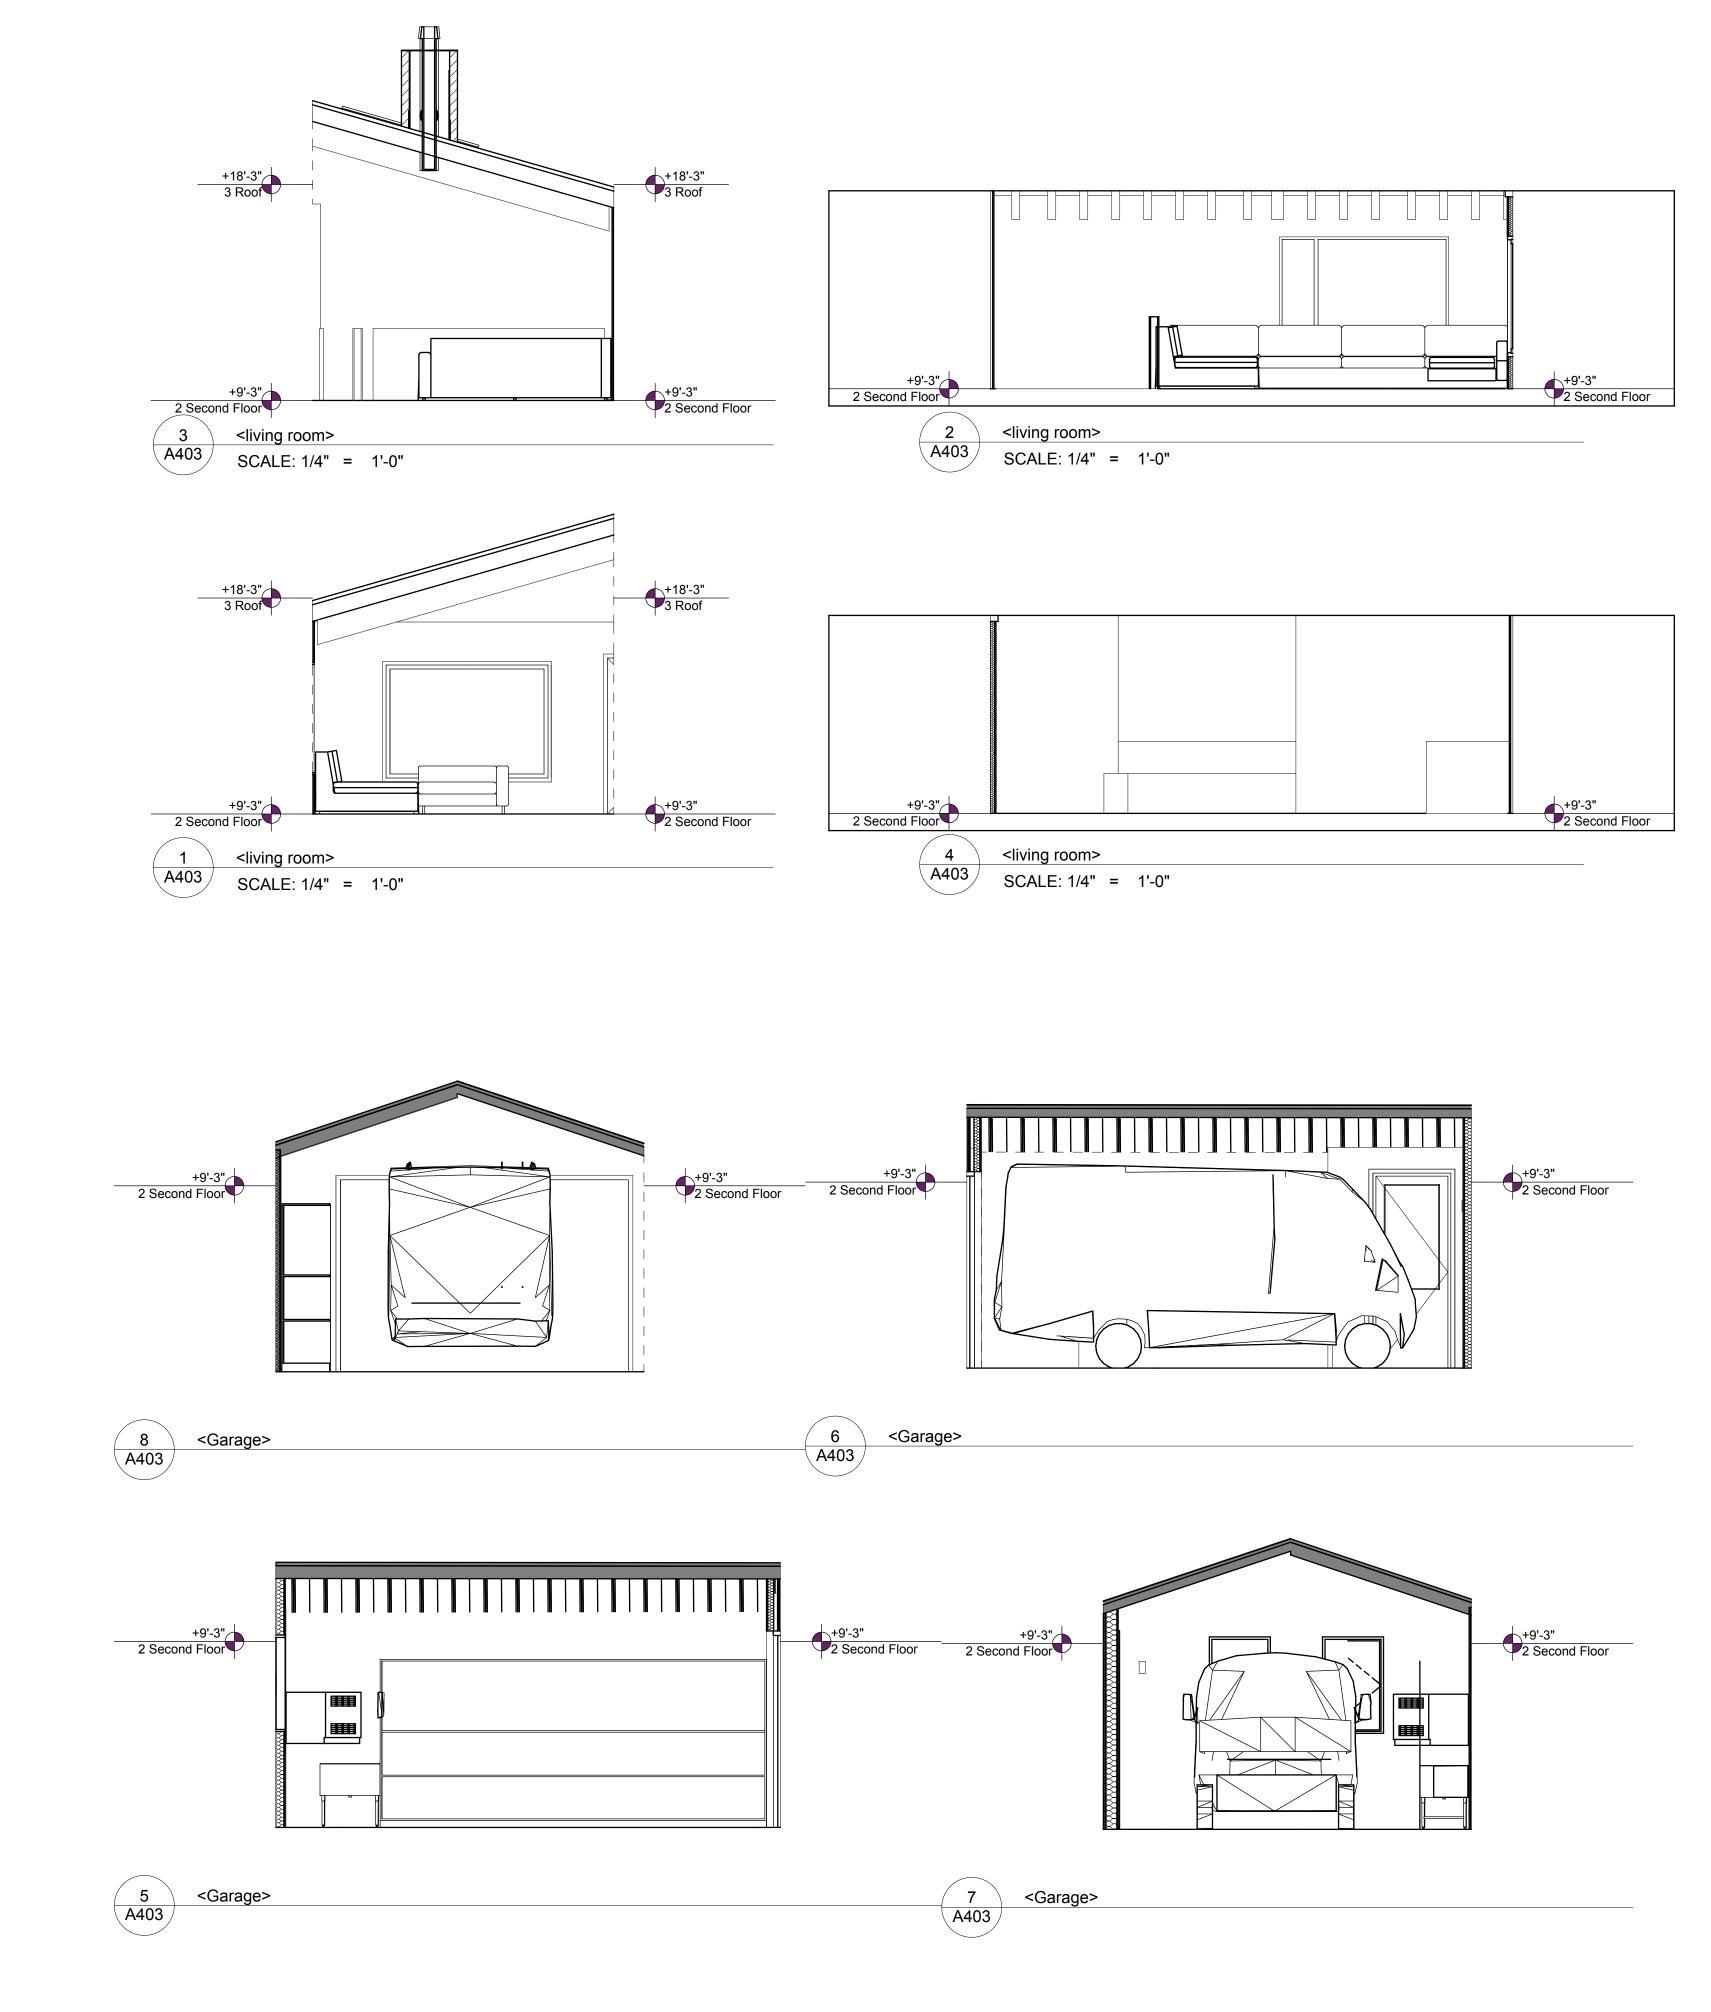



INTEGRATED DESIGN TEAM Civil Grading and Drainage Jay Engstrom, P.E. Crystal River Civil, LLC

Landscape Architect Jennifer M. Dolecki-Smith, RLA Escape Garden Design, LLC Structural Engineer Brian Rossiter, P.E. bwr.pe

Contractor Adam Rothberg Rothberg Development



312 W Hyman Ave 312 W Hyman Ave Lots P+Q, Block 46 Aspen CO 81611 USA/ Pitkin County UGB, City of Aspen

312 W Hyman Ave Aspen CO 81611 USA

Powder Day Skiiing, LLC, David A Tarrab Mees

Account # R000145 Parcel ID # 273512464006

08/22/21 COA- HPO Site Visit

02/26/22 COA- HPC Conceptual I

04/27/22 COA- HPC Conceptual II

07/27/22 COA- HPC Final

10/12/22 COA- City Council Call Up

06/28/23 COA- Permit Submittal

04/12/23 COA- HPC Substantial

07/29/24 COA- Building comments, #4

PROJECT NO: Project No. 116

MODEL FILE: 312_W_Hyman_07292024.pln

DRAWN BY: Jeffrey H Woodruff COPYRIGHT:

SHEET TITLE

Interior Elevations

A403

A500

Window Legend SCALE: 1' = 1'-0"

Fixed	Fixed	Fixed	Fixed	Sliding	Sliding	Sliding	Undefined	Undefined	Undefined
6'-0"×3'-6"	7'-0"×4'-8"	7'-0"×5'-0"	7'-0"×5'-0"	3'-10"×2'-8"	3'-10"×3'-0"	6'-0"×3'-6"	2'-0"×3'-0"	2'-1"×2'-8"	2'-6"×4'-0"
Existing	Existing	Existing	Existing: installing dou	Existing: installing dou	NEW Loewen, Al Clad	Existing: installing dou	NEW Loewen, Awning	. Existing: wall nook, not	NEW Loewen, Al Clad,

Window Legend SCALE: 1' = 1'-0"

	WINDOW SCHEDULE											
OOW NUMBER		WIDOV	V SIZE									
M ID	ROOM NAME	NOMINAL WIDTH	NOMINAL HEIGHT	TYPE	HEAD DETAIL	JAMB DETAIL	SILL DETAIL	ACCESORIES		U-VALUE	TEMPERED	REMARKS
Nook		2'-1"	2'-8"	Undefined	A600	A600	A600		Nook	N/A		Existing: wall nook, not a window
W 2E		3'-10"	2'-8"	Sliding	A600	A600	A600		Loå2 -272	.25	\boxtimes	Existing: installing double pane glass of the thinnest dimension, with a dark spacer
W 3E		2'-6"	4'-0"	Casement	A600	A600	A600		E272/I89	.27	\boxtimes	NEW Loewen, Al Clad
W 4E		2'-6"	4'-0"	Casement	A600	A600	A600		E272/I89	.27	\boxtimes	NEW Loewen, Al Clad
W 4S		3'-10"	2'-8"	Sliding	A600	A600	A600		Loå2 -272	.25	\boxtimes	Existing: installing double pane glass of the thinnest dimension, with a dark spacer
W 5E		3'-10"	3'-0"	Sliding	A600	A600	A600		Loå2 -272	.25	\boxtimes	NEW Loewen, Al Clad
W 5W		3'-10"	2'-8"	Sliding	A600	A600	A600		Loå2 -272	.25	\boxtimes	Existing: installing double pane glass of the thinnest dimension, with a dark spacer
W 6E		2'-0"	4'-0"	Casement	A600	A600	A600		E272/I89	.27	\boxtimes	NEW Loewen, Al Clad
W 6W		1'-7"	8'-0"	Fixed	A600	A600	A600		E272/I89	.27	\boxtimes	NEW Loewen, Al Clad
W 7N		1'-2"	4'-0"	Casement	A600	A600	A600		E272/I89	.27	\boxtimes	NEW Loewen, Al Clad
W 7W		3'-10"	2'-8"	Sliding	A600	A600	A600		Loå2 -272	.25	\boxtimes	Existing: installing double pane glass of the thinnest dimension, with a dark spacer
W 8N		2'-6"	4'-0"	Undefined	A600	A600	A600		E272/I89	.27	\boxtimes	NEW Loewen, Al Clad, Awning
W 8W		2'-0"	4'-0"	Fixed	A600	A600	A600		E272/I89	.27	\boxtimes	NEW Loewen, Al Clad
W 9N		2'-6"	4'-0"	Undefined	A600	A600	A600		E272/I89	.25	\boxtimes	NEW Loewen, Al Clad, Awning
W 11E		7'-0"	4'-8"	Casement	A600	A600	A600		Loå2 -272	.25	\boxtimes	Existing: installing double pane glass of the thinnest dimension, with a dark spacer
W 12S		7'-0"	5'-0"	Fixed	A600	A600	A600		Loå2 -272	.25	\boxtimes	Existing: installing double pane glass of the thinnest dimension, with a dark spacer
W 14S		7'-0"	5'-0"	Casement	A600	A600	A600		Loå2 -272	.25	\boxtimes	Existing: installing double pane glass of the thinnest dimension, with a dark spacer
W 15W		6'-0"	3'-6"	Sliding	A600	A600	A600		Loå2 -272	.25	\boxtimes	Existing: installing double pane glass of the thinnest dimension, with a dark spacer
W 16W		6'-0"	3'-6"	Sliding	A600	A600	A600		Loå2 -272	.25	\boxtimes	Existing: installing double pane glass of the thinnest dimension, with a dark spacer
W G1		2'-6"	4'-0"	Casement	A600	A600	A600		E272/I89	.27	\boxtimes	NEW Loewen, Al Clad
W G2		2'-6"	4'-0"	Casement	A600	A600	A600		E272/I89	.27		NEW Loewen, Al Clad
W G3		2'-6"	4'-0"	Casement	A600	A600	A600		E272/I89	.27		NEW Loewen, Al Clad
W S7		2'-0"	3'-0"	Undefined	A600	A600	A600		E272/I89	.25	\boxtimes	NEW Loewen, Awning (Carbon/Wood Clad), Window at former attic

Cardinal LoĒ-272 - (2) Calculations based on 3 mm (1/8") glass, 13 mm (1/2") airspace, 3 mm (1/8") glass

MODEL FILE: 312_W_Hyman_07292024.pln DRAWN BY: Jeffrey H Woodruff COPYRIGHT:

A500

SHEET 62

Window Schedule

SCALE: 1' = 1'-0"



Jeffrey H. Woodruff AIA, NCARB, LEED AP Cloud Hill Design, LLC Snowmass CO 81654 USA

cloud hill

design. Ilc

Civil Grading and Drainage Jay Engstrom, P.E. Crystal River Civil, LLC Landscape Architect Jennifer M. Dolecki-Smith, RLA Escape Garden Design, LLC Structural Engineer Brian Rossiter, P.E. bwr.pe

INTEGRATED DESIGN TEAM

Contractor Adam Rothberg Rothberg Development



312 W Hyman Ave 312 W Hyman Ave Lots P+Q, Block 46 Aspen CO 81611 USA/ Pitkin County UGB, City of Aspen

312 W Hyman Ave Aspen CO 81611 USA

Powder Day Skiiing, LLC, David A Tarrab Mees

Account # R000145 Parcel ID # 273512464006

08/22/21 COA- HPO Site Visit

02/26/22 COA- HPC Conceptual I

04/27/22 COA- HPC Conceptual II

07/27/22 COA- HPC Final

10/12/22 COA- City Council Call Up

04/12/23 COA- HPC Substantial


06/28/23 COA- Permit Submittal


07/29/24 COA- Building comments, #4


PROJECT NO: Project No. 116

SHEET TITLE

Schedules

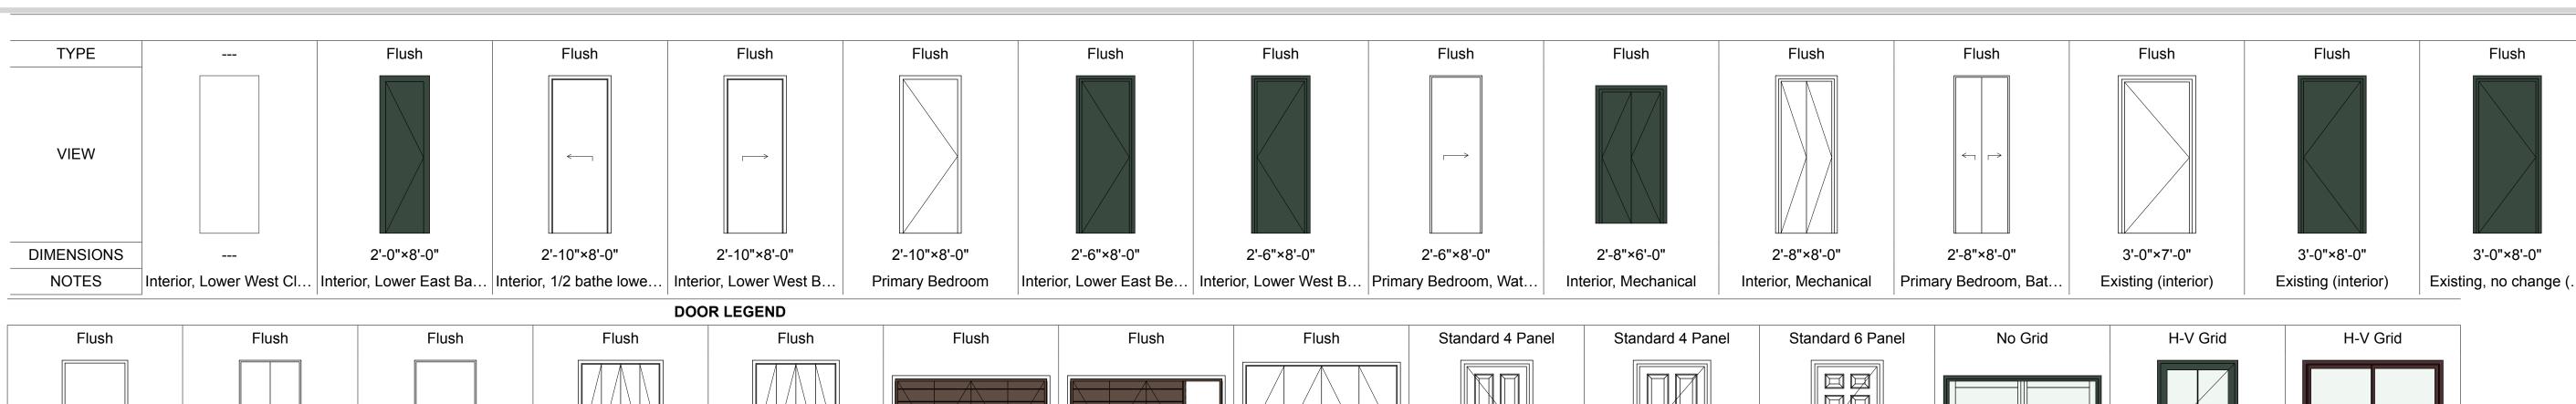

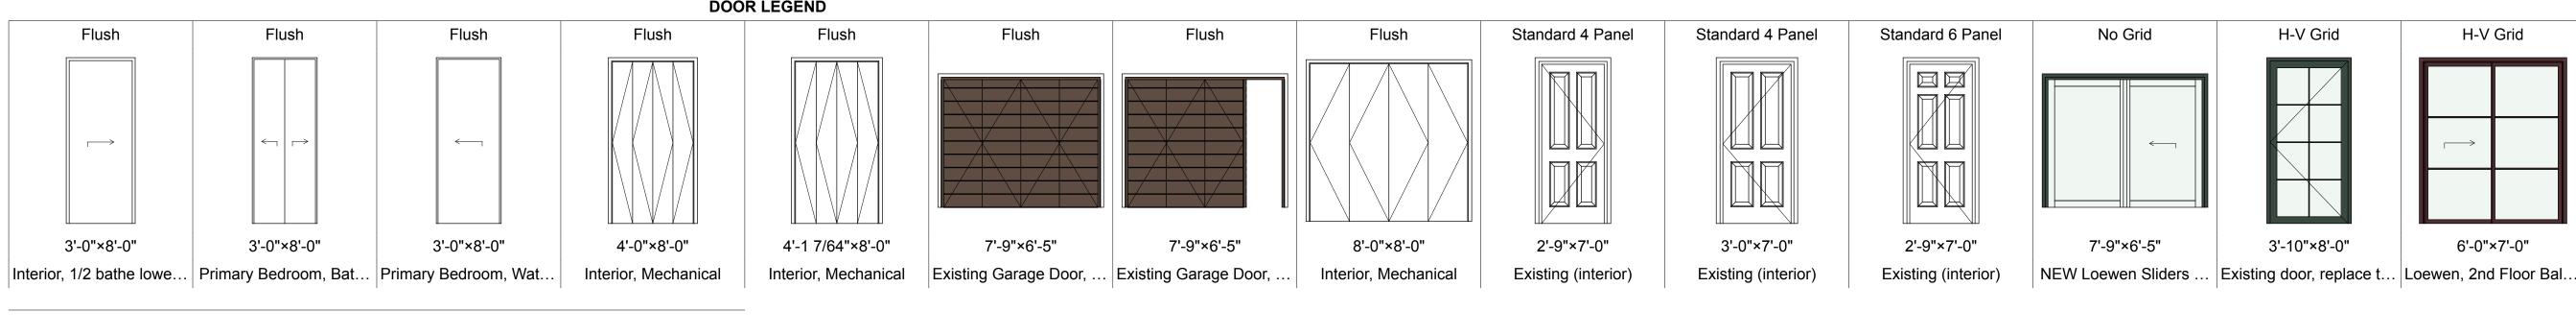

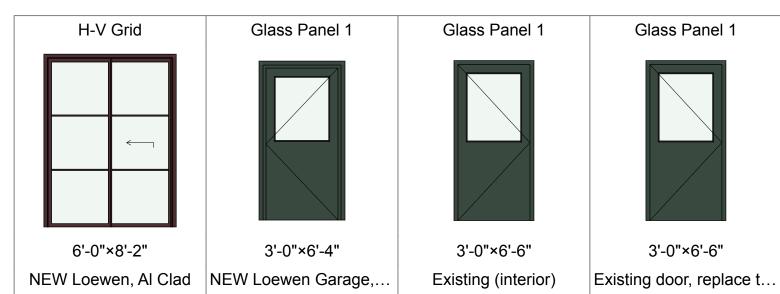

Door Legend

SCALE: 1' = 1'-0"

								DOOR SC	HEDULE					
NUMBER				DOOR LEAF						HARD	_	RATI	INGS	
ID	ROOM NAME	NOMINAL WIDTH	NOMINAL HEIGHT	LEAF THICKNESS	MATERIAL	TYPE	HEAD DETAIL	JAMB DETAIL	SILL DETAIL	WARE A	ACCESORIES	FIRE	STC	REMARKS
D1 L1		3'-0"	8'-0"	1 3/4"	SC WOOD		A600	A600	A600			Non-Rated		Primary Bedroom, Water Closet
D1 L2		3'-0"	8'-0"	1 3/4"	SC WOOD		A600	A600	A600			Non-Rated		Interior, 1/2 bathe lower level
D1 L3		3'-0"	8'-0"	1 3/4"	SC WOOD		A600	A600	A600			Non-Rated		Primary Bedroom, Water Closet
D 1E		3'-0"	8'-0"	1 3/4"	SC WOOD		A600	A600	A600			Non-Rated		Existing, no change (@ stairs)
D 1N		6'-0"	8'-2"	1 3/4"	SC WOOD		A600	A600	A600			Non-Rated		NEW Loewen, Al Clad
D 2N		6'-0"	8'-2"	1 3/4"	SC WOOD		A600	A600	A600			Non-Rated		NEW Loewen, Al Clad
D 3E		3'-0"	2'-9"	1 3/4"	SC WOOD		A600	A600	A600			Non-Rated		Louvered stair door
D 4 Shutter		7'-9"	6'-5"	1 3/4"	SC WOOD		A600	A600	A600			Non-Rated		Existing Garage Door, Cut to Make Bi-fold shutters, no locking HW (shutter)
D 4S		7'-9"	6'-5"	1 3/4"	ALUM / GLASS		A600	A600	A600			Non-Rated		NEW Loewen Sliders at garage doors (sliders behind shutters at bedrooms)
D 5 Shutter		7'-9"	6'-5"	1 3/4"	SC WOOD		A600	A600	A600			Non-Rated		Existing Garage Door, Cut to Make Bi-fold shutters, no locking HW (shutter)
D 5S		7'-9"	6'-5"	1 3/4"	ALUM / GLASS		A600	A600	A600			Non-Rated		NEW Loewen Sliders at garage doors (sliders behind shutters at bedrooms)
D 6W		3'-10"	8'-0"	1 3/4"	SC WOOD		A600	A600	A600			Non-Rated		Existing door, replace the screen door if needed, no change to historic door
D 11E		6'-0"	7'-0"	1 3/4"	ALUM / GLASS		A600	A600	A600			Non-Rated		Loewen, 2nd Floor Balcony (Al. Clad)
D 22E		3'-0"	6'-6"	1 3/4"	SC WOOD		A600	A600	A600			Non-Rated		Existing door, replace the screen door if needed, no change to historic door
D B1		2'-6"	8'-0"	1 3/4"	SC WOOD		A600	A600	A600			Non-Rated		Interior, Lower West Bedroom
D B2		2'-10"	8'-0"	1 3/4"	SC WOOD		A600	A600	A600			Non-Rated		Interior, Lower West Bathroom
D B3		8'-0"	8'-0"	1 3/4"	SC WOOD		A600	A600	A600			1 hour		Interior, Mechanical
D B5		2'-6"	8'-0"	1 3/4"	SC WOOD		A600	A600	A600			Non-Rated		Interior, Lower East Bedroom
D B6		2'-0"	8'-0"	0 1/4"	ALUM / GLASS		A600	A600	A600			Non-Rated		Interior, Lower East Bathe/Shower Door
D B7		2'-10"	8'-0"	1 3/4"	SC WOOD		A600	A600	A600			Non-Rated		Interior, 1/2 bathe lower level
D B8		2'-0"	8'-0"	0 1/4"	SC WOOD		A600	A600	A600			Non-Rated		Interior, Lower East Bathe/Shower Door
D B 3		4'-1 7/64"	8'-0"	1 3/4"	SC WOOD		A600	A600	A600			1 hour		Interior, Mechanical
D B 4		4'-0"	8'-0"	1 3/4"	SC WOOD		A600	A600	A600			1 hour		Interior, Mechanical
D G1		3'-0"	8'-0"	1 3/4"	SC WOOD		A600	A600	A600			Non-Rated		NEW Loewen Garage, entry door
D G2		3'-0"	6'-4"	1 3/4"	SC WOOD		A600	A600	A600			Non-Rated		NEW Loewen Garage, entry door
D GAR1		12'-0"	8'-0"	1 3/4"	SC WOOD		A600	A600	A600			Non-Rated		Garage door, new
D M 9		2'-8"	8'-0"	1 3/4"	SC WOOD		A600	A600	A600			Non-Rated		Interior, Mechanical
D M 10		2'-8"	6'-0"	1 3/4"	SC WOOD		A600	A600	A600			1 hour		Interior, Mechanical
D PB1		2'-10"	8'-0"	1 3/4"	SC WOOD		A600	A600	A600			Non-Rated		Primary Bedroom
D PB2		3'-0"	8'-0"	1 3/4"	SC WOOD		A600	A600	A600			Non-Rated		Primary Bedroom, Bathroom
D PB3		2'-8"	8'-0"	1 3/4"	SC WOOD		A600	A600	A600			Non-Rated		Primary Bedroom, Bathroom
D PB4		2'-6"	8'-0"	1 3/4"	SC WOOD		A600	A600	A600			Non-Rated		Primary Bedroom, Water Closet

cloud hill design. Ilc

Jeffrey H. Woodruff AIA, NCARB, LEED AP Cloud Hill Design, LLC Snowmass CO 81654 USA

INTEGRATED DESIGN TEAM
Civil Grading and Drainage
Jay Engstrom, P.E.
Crystal River Civil, LLC

Landscape Architect
Jennifer M. Dolecki-Smith, RLA
Escape Garden Design, LLC

Structural Engineer
Brian Rossiter, P.E.
bwr.pe

Contractor Adam Rothberg Rothberg Development



312 W Hyman Ave 312 W Hyman Ave Lots P+Q, Block 46 Aspen CO 81611 USA/

312 W Hyman Ave Aspen CO 81611 USA

Pitkin County UGB, City of Aspen

Powder Day Skiiing, LLC, David A Tarrab Mees

Account # R000145 Parcel ID # 273512464006

08/22/21 COA- HPO Site Visit

UO/22/21 COA- HPO SILE VI

02/26/22 COA- HPC Conceptual I

04/27/22 COA- HPC Conceptual II

07/27/22 COA- HPC Final

10/12/22 COA- City Council Call Up

04/12/23 COA- HPC Substantial

06/28/23 COA- Permit Submittal

07/29/24 COA- Building comments, #4

PROJECT NO: Project No. 116

MODEL FILE:
312_W_Hyman_07292024.pln

DRAWN BY: Jeffrey H Woodruff

COPYRIGHT:

SHEET TITLE

Schedules

A501

SHEET 63

effrey/Documents/Cloud Hill/312 West Hyman/312_W_F

2 Door Schedule

5/8" GWB R-.61 2X6 FRAMING R-21 BATT STRUCTURAL PLY AIR AND VAPOR BARRIER 1 1/2" RIGID INSUL. W/ 1 X FURRING R-9.3 AIR SPACE WOOD SIDING TOTAL R-VALUE = 30.91

5/8" GWB (OR TWO LAYERS MRG) R-.5625

1 1/2" RIGID INSUL. W/ 1 X FURRING R-5

WOOD SIDING, T&G, ASTM E119 STRUCTURAL EXT PLY, DENSGLASS

STRUCTURAL EXT PLY, DENSGLASS

TOTAL R-VALUÉ = NOT HEATED, EXTERIOR DECK

WOOD SIDING, T&G, ASTM E119

W1 (HISTORIC EXISTING)

10 GAUGE STEEL (BOX) FIBER CEMENT BOARD

STRUCTURAL PLY R-.62

TOTAL R-VALUE = 16.5

W 6 Chimney and Flu (Rebuilt)

POSTS, AS PER STRUCT

W12 (North Deck Exterior


STUCCO

AIR AND VAPOR BARRIER

Closed Cell Spray Foam R-7/Inch R-38.50 Exterior 2 x 5/8" DensGlass Fireguard Sheathing Applied Vertically or Horizontally to wood studs as per struct spaced as per struct with 1 3/4" galvanized roofing nails 7" AIR AND VAPOR BARRIER 2" RIGID INSUL. W/ 1" X FURRING R-12.4

1" AIR SPACE (FURRING) VERTICAL WOOD CLADDING, SHIP LAP, CLASS B OR BETTER TOTAL R-VALUE = 50.9

W2 NEW CONSTRUCTION WOOD WALL (RESIDENCE)

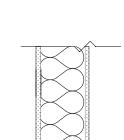

W5

2X4 FRAMING ACCOUSTIC BAT INSUL.

5/8" GWB (INTERIOR)

2 x 6 framing,

Interior 5/8" DensArmor Plus Fireguard Interior Panels or ToughRock 5/8" Fireguard X gypsum board applied vertically or horizontally to stude with 1- 7/8" 6D coated nails 7" o.c. Stagger Joints Each Side Framing as per struct, ROCKWOOL Exterior 2 x 5/8" DensGlass Fireguard Sheathing Applied Vertically or Horizontally to wood studs as per struct spaced as per struct with 1 3/4" galvanized roofing nails 7" o.c. AIR AND VAPOR BARRIER 2" RIGID INSUL. W/ 1" X FURRING R-12.4 1" AIR SPACE (FURRING) R-5.5 TOTAL R-VALUE =

COA NEW CONSTRUCTION AND ADDITIONS: WOOD FRAME R-VALUE 42.87

W4-X 1 Hour Firewall @ Garage (AS PER GP CUT SHEET BELOW)

HISTORIC BUILDING

TOTAL R VALUE = 21

W3 (Historic Existing CMU),

3/4" AIR GAP

2 X 4 FRAMING

CONCRETE MASONRY UNIT


DRAINAGE MAT (BELOW GRADE ONLY)

WATERPROOFING (BELOW GRADE ONLY)

3.5" CLOSED CELL SPRAY FOAM INSULATION, R-21 5/8" GWB

add continuous insulation (interior) at habitable spaces,

to add R-5 to R-9.3 to assembly for thermal comfort

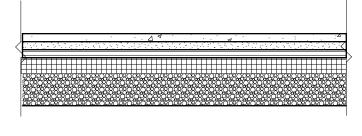

SLAB ON GRADE • 2" RIGID INSULATION • 15 MIL VAPOR RETARDER • 4" GRAVEL • UNDISTURBED OR COMPACTED **SUBGRADE** F1 (Existing Historic slab)

> • 3/4" PLYWOOD(UNDERLAYMENT GRADE) 1X2 SLEEPERS2" RIGID INSULATION • 15 MIL VAPOR RETARDER • 4" GRAVEL • UNDISTURBED OR COMPACTED SUBGRADE

CARPET AND PAD

• PAVERS (AS PER LANDSCAPE PLAN)

• 2" POLYISO RIGID INSUL = R 13.0

• WSMM SNOW MELTING MAS

R Value of Assembly = R13.0


SAND BASE

• 4" GRAVEL

F2 (floor at entry)

• CRUSHED GRAVEL

F3 (Existing Historic slab)

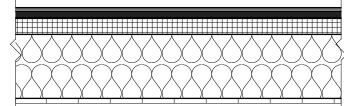

HISTORIC ROOF

HAT CHANNEL'S

WOOD T&G

torch applied 3 layer asphalt1/2" DENSDECK, THERMAL, MOISTURE, WIND BARRIER (Not on file) • 1 1/2" POLYISO RIGID INSUL R7.5 (Not

on file, not with permit, COA client) • 3/4" SHEATHING WOOD RAFTERS RE: STRUCT • SPRAY FOAM (7.5" @ R7 /in) R 52.5

TOTAL R VALUE = R60 THIS ROOF WAS INSTALLED BY THE CITY OF ASPEN, PLEASE SEE JEFF PENDARVIS' CUT SHEETS AND PERMIT. THIS IS A HISTORIC CITY OF ASPEN INSTALLATION BY THE CITY'S ROOFER


R1 (Removing drop ceiling, adding new insulation. Sistering new rafters 2 x 12", assuming 7.5" minimum spray foam)

CURRENT HISTORIC STRUCTURE ROOF, INSTALLED BY THE CITY OF ASPEN, CAPITAL ASSETS DIVISION Permit 0003.2013.ARGR

Owner (City of Aspen) contracted with GZO Sheet metal to replace tar and gravel roof with torch applied asphalt (3 layer torch down) this replaced the 1991 roof that was a mansville built up, spec 4GNG.

The work performed does not comply with grading and drainage. As per the City of Aspen, changed existing trim and fascia profile and gutter, 01/11/13 tear off existing deck membrane and roof, add box gutter to front of deck

0112.2012.ARGR A 14" aspen was removed in 2014, in order to install patio with pavers (assuming west patio)

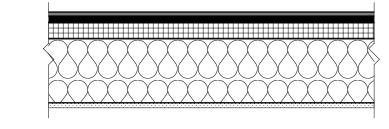

• TEE-LOCK STANDING SEAM METAL ROOF • 1/2" DENSDECK


• THERMAL, MOISTURE, WIND BARRIER • 2" POLYISO RIGID INSUL R13.0

• 3/4" SHEATHING • WOOD RAFTERS RE: STRUCT • SPRAY FOAM (7.5" @ R7 /in) R52.5 HAT CHANNEL'S INTERIOR GWG

EAVES (CLASS 1(A) FIRE/FLAME SPREAD RATING TOTAL R VALUE = R 66.06

R2 (Garage, new), UL 790 CLASS A ROOF

• EXTERIOR: FIBER CEMENT BOARD AT ALL

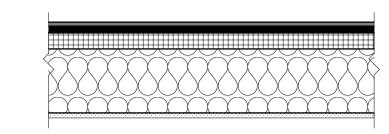

• SYTHETIC DECKING MATERIAL

 SLEEPERS • 1/2" DENSDECK B.56 • THERMAL, MOISTURE, WIND BARRIER

• 2" POLYISO RIGID INSUL R13.0 • 3/4" SHEATHING • WOOD RAFTERS RE: STRUCT SPRAY FOAM (7.5" @ 7 R/in) R52.5 HAT CHANNEL'S

TOTAL R VALUE = R66.06

R3 (Primary Bed, Decking)



Jeffrey H. Woodruff AIA, NCARB, LEED AP Cloud Hill Design, LLC Snowmass CO 81654 USA

INTEGRATED DESIGN TEAM

Civil Grading and Drainage Jay Engstrom, P.E. Crystal River Civil, LLC

Landscape Architect Jennifer M. Dolecki-Smith, RLA Escape Garden Design, LLC Structural Engineer Brian Rossiter, P.E.

Contractor Adam Rothberg Rothberg Development

bwr.pe



312 W Hyman Ave

312 W Hyman Ave Lots P+Q, Block 46 Aspen CO 81611 USA/ Pitkin County UGB, City of Aspen

312 W Hyman Ave Aspen CO 81611 USA

Powder Day Skiiing, LLC, David A Tarrab Mees

Account # R000145 Parcel ID # 273512464006

08/22/21 COA- HPO Site Visit

02/26/22 COA- HPC Conceptual I

04/27/22 COA- HPC Conceptual II

07/27/22 COA- HPC Final

04/12/23 COA- HPC Substantial

06/28/23 COA- Permit Submittal

10/12/22 COA- City Council Call Up

07/29/24 COA- Building comments, #4


PROJECT NO: Project No. 116

MODEL FILE: 312_W_Hyman_07292024.pln


DRAWN BY: Jeffrey H Woodruff COPYRIGHT:


SHEET TITLE

Assemblies & Plan **Details**

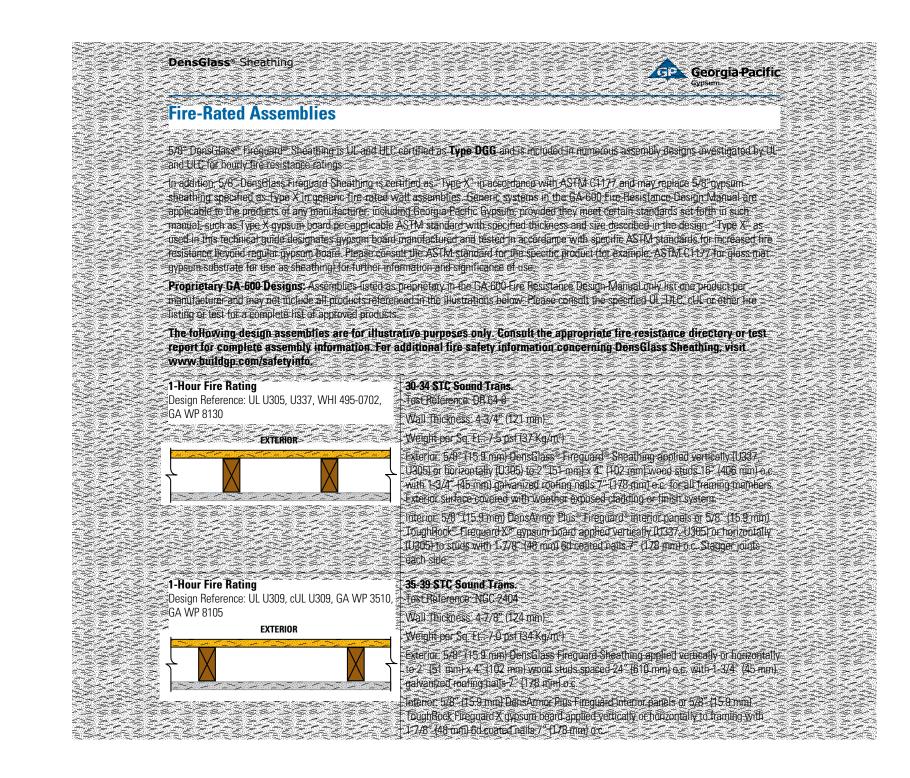



Loewen Wood Clad Plan Details (Generic Assembly)

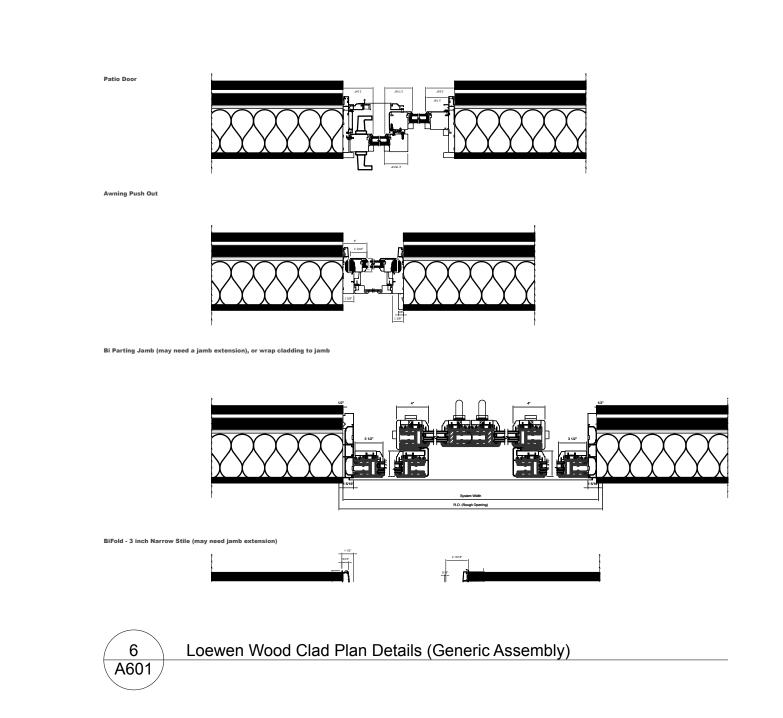

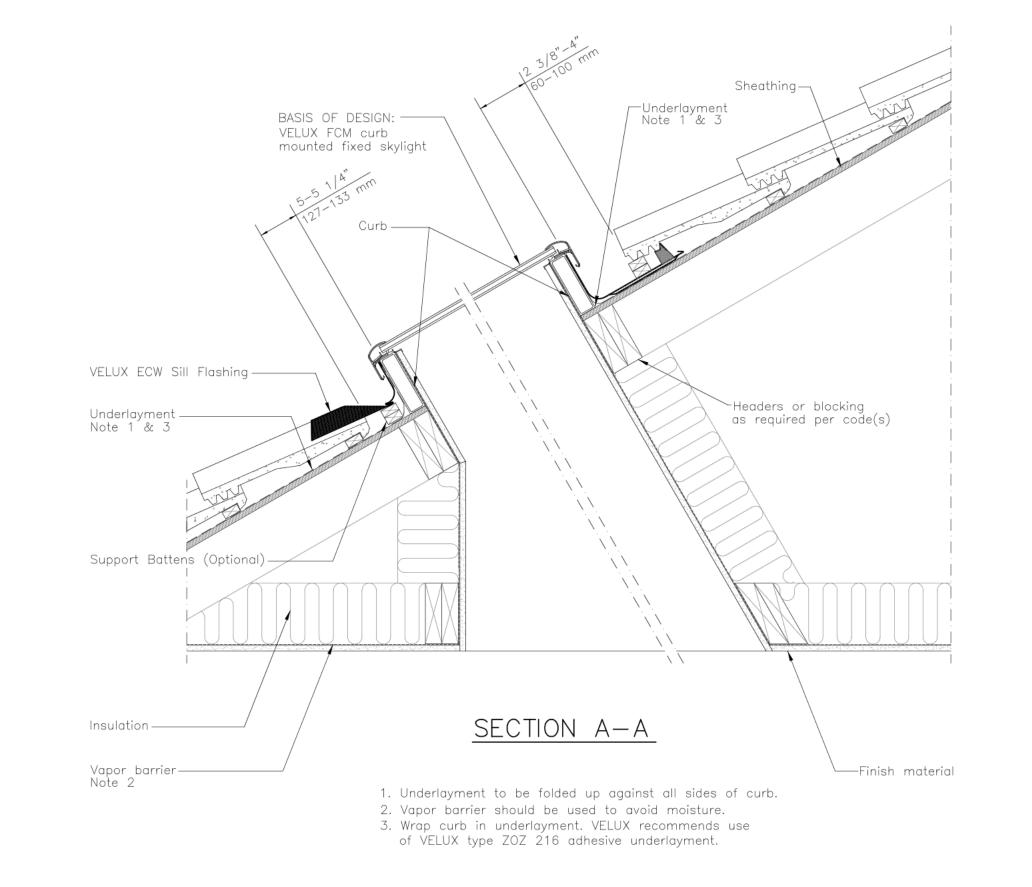


light shaft DASI, VELUX Digital Asset Storage Infrastructure

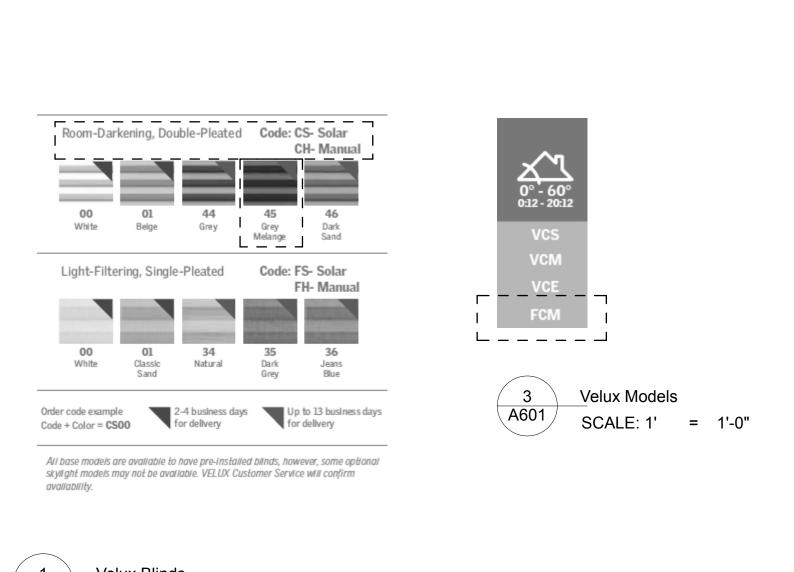

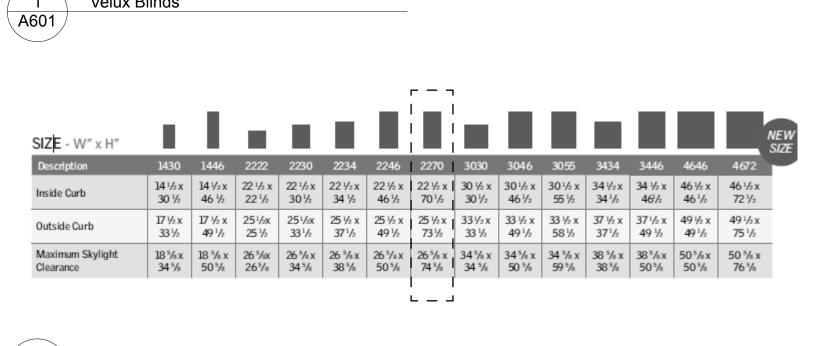

Standard Velux Sizes

SCALE: 1' = 1'-0"

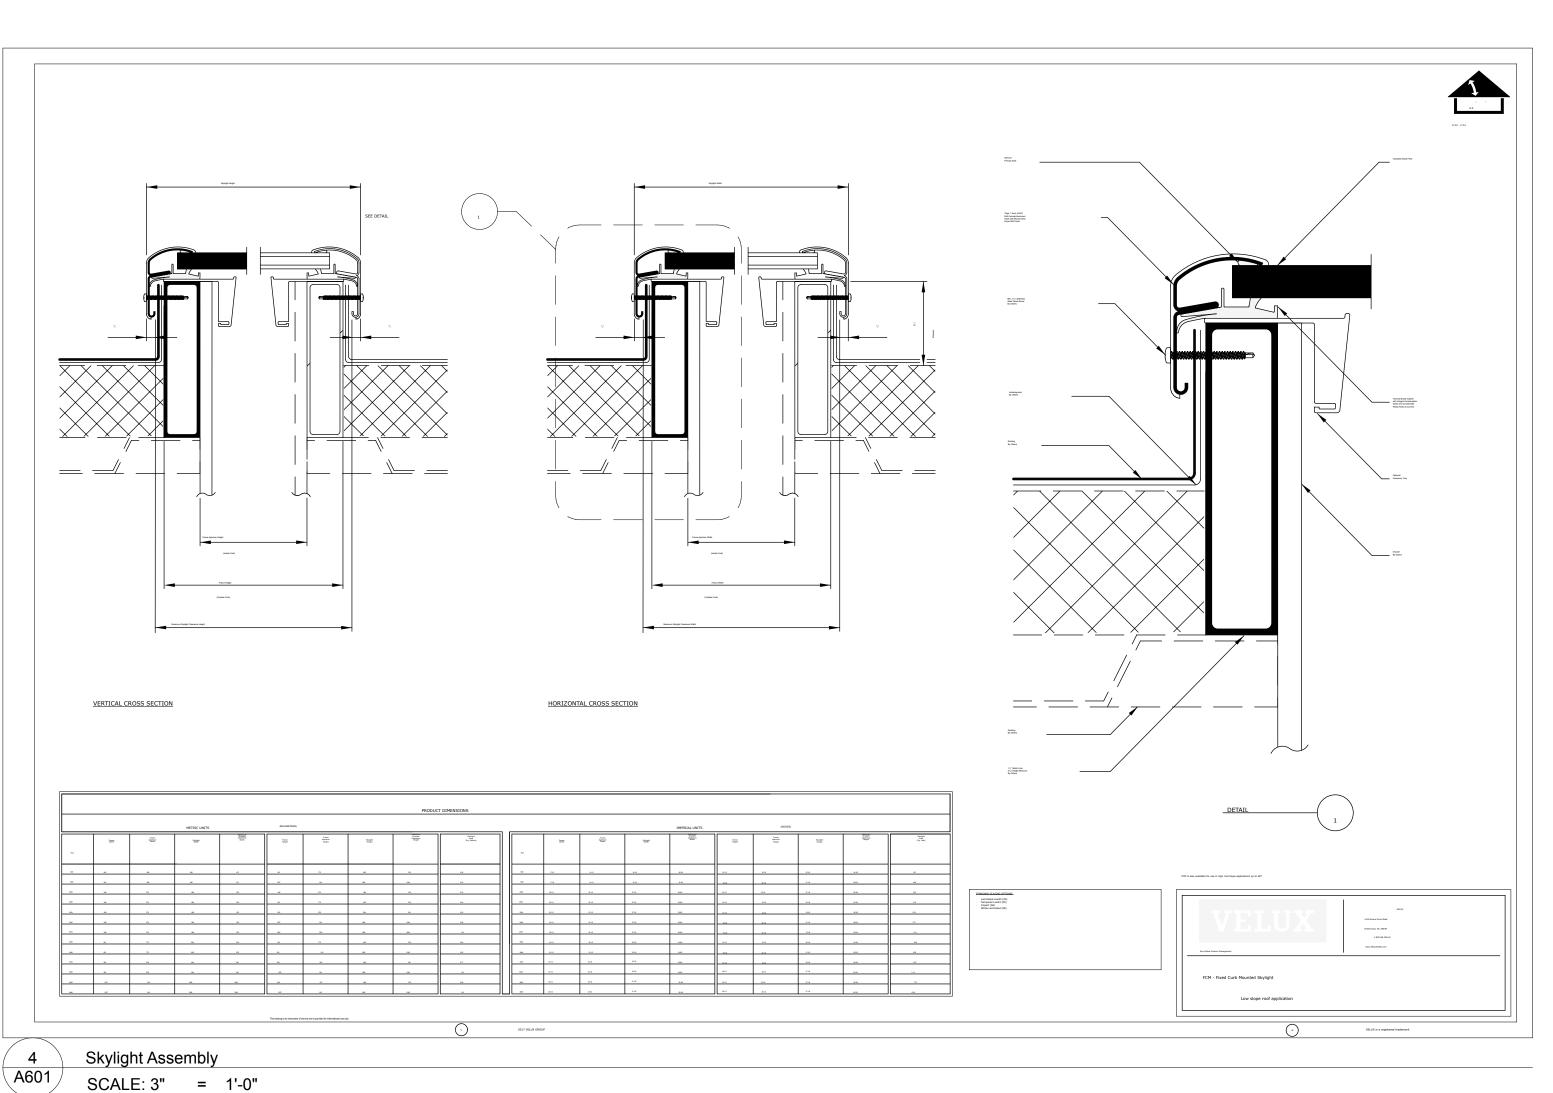

cloud hill design. Ilc

Jeffrey H. Woodruff AIA, NCARB, LEED AP Cloud Hill Design, LLC Snowmass CO 81654 USA


INTEGRATED DESIGN TEAM

Civil Grading and Drainage Jay Engstrom, P.E. Crystal River Civil, LLC

Landscape Architect Jennifer M. Dolecki-Smith, RLA Escape Garden Design, LLC

Structural Engineer Brian Rossiter, P.E. bwr.pe

Contractor Adam Rothberg Rothberg Development

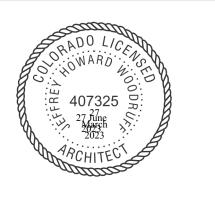

312 W Hyman Ave 312 W Hyman Ave Lots P+Q,

Block 46 Aspen CO 81611 USA/ Pitkin County UGB, City of Aspen

312 W Hyman Ave Aspen CO 81611 USA

Powder Day Skiiing, LLC, David A Tarrab Mees

> Account # R000145 Parcel ID # 273512464006

08/22/21 COA- HPO Site Visit

02/26/22 COA- HPC Conceptual I

04/27/22 COA- HPC Conceptual II

07/27/22 COA- HPC Final

10/12/22 COA- City Council Call Up

04/12/23 COA- HPC Substantial

06/28/23 COA- Permit Submittal

07/29/24 COA- Building comments, #4

PROJECT NO: Project No. 116

MODEL FILE:

312_W_Hyman_07292024.pln

DRAWN BY: Jeffrey H Woodruff COPYRIGHT:

SHEET TITLE

Assemblies- Skylights, Fenestration

A601



ACCESSORIES

Optional



1. Heavy Metal and RDX only 2. Heavy Metal and RDX glasses are 7½" in height 3. Heavy Metal and RDX glasses are 4" in diameter

CAST GUARD WITH GLASS ENCLOSURE Cast guard can be specified in all standard and specialized finishes, and will match shade finish unless otherwise specified (Note: For galvanized shade finishes, cast guard is unfinished Raw Aluminum) • Glass is available in clear (-CGG), frosted (-FGG) or opal (-OGG) ¹ See fixture pages for availability -FGG (Frosted Glass w/ Cast Guard)

WIRE CAGE WITH GLASS ENCLOSURE • Wire cage can be specified in all standard and specialized finishes, and will match shade finish unless otherwise specified (Note: For galvanized shade finishes, wire cage is finished in Painted Natural Aluminum) Glass is available in clear (-CGWC) or frosted (-FGWC)

-CGWC (Clear Glass w/ Wire Cage) -FGWC (Frosted Glass w/ Wire Cage)

See fixture pages for availability

GLASS ENCLOSURE

See fixture pages for availability

-CG (Clear Glass Enclosure)

-OGG (Opal Glass w/ Cast Guard)

• Glass is available in clear (-CG), frosted (-FG) or opal (-OG)



. Heavy Metal and RDX only


2. Heavy Metal and RDX cast guards are 8" in height 3. Heavy Metal and RDX cast guards are 5½" in diameter





A- E101

Light at the property line < .5 Foot Candles as per code. The existing lighting is a mix of jelly jars and exposed lamps.

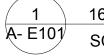

16 RLM-Catalog_2022-V2 page 58-59

SCALE: 1' = 1'-0"

12 April 2023

City of Aspen

Jeffrey Woodruff, Cloud Hill Design, LLC, rep Powderdayskiing, LLC

RE: Electrical service needs at 312 West Hyman, as per HPC conceptual review and follow up

City of Aspen 312 W Hyman Ave #Upst 01-25036520-00 City of Aspen 312 W Hyman Ave #DWST 01-250360-00

Currently we have 300 Amp total building services, far exceeding our current and anticipated needs

312 W Hyman Ave #Upst on a 200 Amp service (need to confirm again with provider)

312 W Hyman Ave #DWST on a 100 Amp

Efficiency

Renewables - Energy Neutral- Renewable Electrification

Work with City of Aspen Electric (no incentives), CORE (rebates and grants), Federal ITC. No REMP (< 64 SQ FT hot tub, no snowmelt)

Building Envelope

Building Mechanical Systems- Building Loads Windows- all outmoded, end of useful life single pane with no UV protection. Solution to existing single pane, "installing double pane glass of the thinnest dimension, with a dark spacer"

Current ACH > 1.2. Will provide blower door (pre and) post construction.

Thermal loads- assuming two units, need of 40 A/unit

Thermal loads- assuming one or two units, need of 40 A/unit (assuming potential for electric back up - for low temp, id est negative temperature and hyper heat performs with less efficiency)

Mitsubishi Hyper-Heat Electrical Requirements Model:

MXZ-8C48NAHZ2 (48,000 BTU/H) MXZ-8C60NA2 (60,000 BTU/H)

Power Supply Voltage, Phase, Hertz 208 / 230V, 1-Phase, 60 Hz Recommended Fuse/Breaker Size

MCA 35 A

Voltage Indoor - Outdoor S1-S2 A C 208 / 230 Indoor - Outdoor S2-S3

Kitchen Needs

+12 VDC to +24 VDC

Dishwasher Induction Electric cooking

Electrical requirements

WasherDryer(s)

Electric refrigeration

Hot water heater/heat pump/Energy Star (heat pump/hybrid) (AO Smith or Rheem) AO Smith (and Water Softener)

LED lighting and controls all run on < 15 AMP (if all LED)

Outdoor energy consumption

Fossil fuel needs- outdoor gathering space outdoor electric space heaters (preferred)

Hot tub <64 Sq Ft. (to avoid REMP fees), Crown XL Eave snowmelt (linear feet, health safety at entry) Walkway snowmelt (low albedo pavers)

Car charger in detached garage Onsite renewable energy and storage Solar array (on garage roof)

5 Tesla Powerwalls (work with CORE)



ECO 3" LED DOWNLIGHT ED3AIC, ED3ANC, ED3NC, ED3RM

ED3LAIC, ED3LANC, ED3LNIC, ED3LRIC



SILENT VU™ OPTICS TECHNOLOGY

50° Installed, 10°, 30°, 80° available

0° to 45° tilt (Adjustable housings only)

Clear, Solite, Frosted, Linear Spread

TRIAC, ELV, 0-10V, dims to 1%

Champagne w/ White Flange

120/277V, 50/60Hz

Below Ceiling Access

TRIM COLORS

Champagne

New Construction includes (2) galvanized steel adjustable hanger bars

(Note: polycell spray-in foam insulation must be kept 3" from housing)

OPTICS

ADJUSTABLE

POWER SUPPLY

INPUT VOLTAGE

SERVICABILITY

TRIM OPTIONS

Fixed or Adjustable

Round or Square

DIMMING

	ED3ANC, ED3LANC
D LIGHT ENGINE	
ATED WATTAGE	20.1W, 13.4W, 11.3W
ELIVERED LUMENS	Up to 1929 Im
FICACY	Up to 108 LPW
CT @ 90CRI	2700K, 3000K, 3500K, 4000K, Warm Dim
OLOR QUALITY	90+ CRI, 2-Step SDCM
ED LIFETIME	55,000 hours @ L90

ED3 (20.1W)	10° Optic	30° Optic	50° Optic	80° Optic
2700K (90CRI)	1669 lm	1744 lm	1592 lm	1125 lm
3000K (90CRI)	1803 lm	1884 lm	1720 lm	1216 lm
3500K (90CRI)	1846 lm	1929 lm	1761 lm	1244 lm
4000K (90CRI)	1900 lm	1985 lm	1812 lm	1281 lm
ED3 NIC, RIC (13.4W)	10° Optic	30° Optic	50° Optic	80° Optic
Warm Dim (98 CRI, R9>90)	868 lm	938 lm	846 lm	604 lm
ED3 AIC, ANC (20.1W)	10° Optic	30° Optic	50° Optic	80° Optic
Warm Dim (98 CRI, R9>90)	1195 lm	1291 lm	1165 lm	832 lm
ED3L (11.3W)	10° Optic	30° Optic	50° Optic	80° Optic
2700K (90CRI)	1061 lm	1108 lm	1012 lm	715 lm
3000K (90CRI)	1146 lm	1198 lm	1093 lm	773 lm
3500K (90CRI)	1173 lm	1226 lm	1119 lm	791 lm
4000K (90CRI)	1207 lm	1262 lm	1152 lm	814 lm
ED3S (13.4W)	10° Optic	30° Optic	50° Optic	80° Optic
2700K (90CRI)	1214 lm	1269 lm	1158 lm	819 lm
SUUUK (OUCBI)	1212 lm	1971 lm	1252 lm	005 lm

ED3 (20.1W)	10° Optic	30° Optic	50° Optic	80° Optic
2700K (90CRI)	1669 lm	1744 lm	1592 lm	1125 lm
3000K (90CRI)	1803 lm	1884 lm	1720 lm	1216 lm
3500K (90CRI)	1846 lm	1929 lm	1761 lm	1244 lm
4000K (90CRI)	1900 lm	1985 lm	1812 lm	1281 lm
ED3 NIC, RIC (13.4W)	10° Optic	30° Optic	50° Optic	80° Optic
Warm Dim (98 CRI, R9>90)	868 lm	938 lm	846 lm	604 lm
ED3 AIC, ANC (20.1W)	10° Optic	30° Optic	50° Optic	80° Optic
Warm Dim (98 CRI, R9>90)	1195 lm	1291 lm	1165 lm	832 lm
ED3L (11.3W)	10° Optic	30° Optic	50° Optic	80° Optic
2700K (90CRI)	1061 lm	1108 lm	1012 lm	715 lm
3000K (90CRI)	1146 lm	1198 lm	1093 lm	773 lm
3500K (90CRI)	1173 lm	1226 lm	1119 lm	791 lm
4000K (90CRI)	1207 lm	1262 lm	1152 lm	814 lm
ED3S (13.4W)	10° Optic	30° Optic	50° Optic	80° Optic
2700K (90CRI)	1214 lm	1269 lm	1158 lm	819 lm
3000K (90CRI)	1312 lm	1371 lm	1252 lm	885 lm
3500K (90CRI)	1343 lm	1403 lm	1281 lm	905 lm
4000K (90CRI)	1382 lm	1445 lm	1319 lm	932 lm
Warm Dim (98 CRI, R9>90)	868 lm	938 lm	846 lm	604 lm

3500K (90CRI) 4000K (90CRI)	1846 lm 1900 lm	1929 lm 1985 lm	1761 lm 1812 lm	1244 lm 1281 lm	Standard or Trimless	Blac
ED3 NIC, RIC (13.4W)	10° Optic	30° Optic	50° Optic	80° Optic	• Wall Wasii	Cha
Warm Dim (98 CRI, R9>90)	868 lm	938 lm	846 lm	604 lm	HOUSING INSTALLATION	
ED3 AIC, ANC (20.1W)	10° Optic	30° Optic	50° Optic	80° Optic	New Construction includes (2) ga	alva
Warm Dim (98 CRI, R9>90)	1195 lm	1291 lm	1165 lm	832 lm	Remodel option available	
			T		• 5/8" ~ 2" ceiling thickness	
ED3L (11.3W)	10° Optic	30° Optic	50° Optic	80° Optic	 Min Plenum Height: 2½" Shallov 	V
2700K (90CRI)	1061 lm	1108 lm	1012 lm	715 lm	Ceiling Material: Drywall, T-bar g	
3000K (90CRI)	1146 lm	1198 lm	1093 lm	773 lm		_
3500K (90CRI)	1173 lm	1226 lm	1119 lm	791 lm	 Steel junction box with up to (4) AIC, NIC, RIC, SNIC models are A 	
4000K (90CRI)	1207 lm	1262 lm	1152 lm	814 lm	AIC, SNIC models are CCEA com	
					(Note: polycell spray-in foam insulation	
ED3S (13.4W)	10° Optic	30° Optic	50° Optic	80° Optic	(Note: polyeon spray-in learn insulance	<i>)</i> 11 111
2700K (90CRI)	1214 lm	1269 lm	1158 lm	819 lm	LISTINGS AND WARRANTY	
3000K (90CRI)	1312 lm	1371 lm	1252 lm	885 lm	cULus Listed	Α
3500K (90CRI)	1343 lm	1403 lm	1281 lm	905 lm	UL Listed for Damp Location (All Styles)	U
4000K (90CRI)	1382 lm	1445 lm	1319 lm	932 lm	IC Rated and Non IC Rated Available	C
W D: (00 0D) D0 00)	0001	0001	0.40.1	2041	Five (F) years limited warranty	0

LISTINGS AND WARRANTY	
cULus Listed	ASTM E283 Certified Airtight (AIC, NIC, RIC, SNIC Models)
UL Listed for Damp Location (All Styles)	UL Listed for Wet Location (Wet Location Trim Style)
IC Rated and Non IC Rated Available	CCEA (Chicago Plenum) Approved (AIC, SNIC Models)

• Steel junction box with up to (4) ½" knockouts

Five (5) years limited warranty CA Title 24-JA8 Compliant (AIC, NIC, RIC, SNIC Models) LISTED WET IC 555
RATED AIRTIGHT CCEA DIMMABLE SOMPLIANT WARM DIM STREET WARRANTY

14508 Nelson Ave. City of Industry. CA 91744 • tel: 626.336.4511 • fax: 626.330.4266 • www.csllighting.com

Black w/ White Flange

Silver w/ White Flange



Patent: csllighting.com/patents

©2022 Creative Systems Lighting, A Division of Troy-CSL Lighting, Inc. All rights reserved. Subject to change without notice.

cloud hill design. Ilc

Jeffrey H. Woodruff AIA, NCARB, LEED AP Cloud Hill Design, LLC Snowmass CO 81654 USA


INTEGRATED DESIGN TEAM

Civil Grading and Drainage Jay Engstrom, P.E. Crystal River Civil, LLC

Landscape Architect Jennifer M. Dolecki-Smith, RLA Escape Garden Design, LLC

Structural Engineer Brian Rossiter, P.E. bwr.pe

Contractor Adam Rothberg Rothberg Development

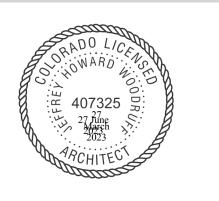

312 W Hyman Ave 312 W Hyman Ave Lots P+Q, Block 46 Aspen CO 81611 USA/

312 W Hyman Ave Aspen CO 81611 USA

Pitkin County UGB, City of Aspen

Powder Day Skiiing, LLC, David A **Tarrab Mees**

Account # R000145 Parcel ID # 273512464006

08/22/21 COA- HPO Site Visit

02/26/22 COA- HPC Conceptual I

04/27/22 COA- HPC Conceptual II

07/27/22 COA- HPC Final

10/12/22 COA- City Council Call Up

04/12/23 COA- HPC Substantial

06/28/23 COA- Permit Submittal

07/29/24 COA- Building comments, #4

PROJECT NO: Project No. 116

MODEL FILE: 312_W_Hyman_07292024.pln

DRAWN BY: Jeffrey H Woodruff

COPYRIGHT:

SHEET TITLE

Electrical- Lamps

A- E101



SUNPOWER®

390–400 W Residential A-Series Panels

SunPower® Maxeon® Technology

SunPower® Maxeon® cell-based panels maximize energy production and savings by combining industry-leading power, efficiency, and durability with the most comprehensive power, product, and service warranty in the industry.^{1,2}




Highest Power Density Available

unPower's new Maxeon Gen 5 cell is 65% larger than prior generations, delivering the most powerful cell and highest efficiency panel in residential solar.² The result is more power per square meter than any commercially available solar.¹

Designed to deliver up to 54% more energy from the same space over the first 25 years in real-world conditions like partial shade and high

Years of Operation

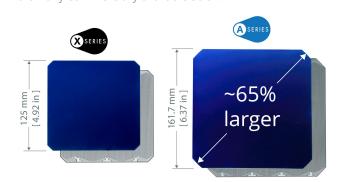

Maximum Lifetime Energy and Savings

SunPower Maxeon Solar Cell Technology



Fundamentally Different. And Better.

- Cell efficiencies of over 25% Delivers leading reliability³
- Patented solid metal foundation prevents breakage and corrosion

As sustainable as the energy it produces.

 Achieved the #1 ranking on the Silicon Valley Toxics Coalition's Solar Scorecard for 3 years running

SunPower modules can contribute to

your business's LEED certification⁴

Best Reliability, Best Warranty

temperatures.¹

SunPower technology is proven to last and we stand behind our panels with the industry's most comprehensive 25-year Combined Power, Product and Service Warranty.



POWERWALL

Tesla Powerwall is a fully-integrated AC battery system for residential or light commercial use. Its rechargeable lithium-ion battery pack provides energy storage for solar self-consumption, time-based control, and backup.

Powerwall's electrical interface provides a simple connection to any home or building. Its revolutionary compact design achieves market-leading energy density and is easy to install, enabling owners to quickly realize the benefits of reliable, clean power.



PERFORMANCE SPECIFICATIONS MECHANICAL SPECIFICATIONS

AC Voltage (Nominal)	120/240 V	Dimensions ¹		1150 mm x 7		
Feed-In Type	Split Phase			(45.3 in x 29		
Grid Frequency	60 Hz	Weight ¹	114 kg (251.3			
Total Energy	14 kWh	Mounting option	ons	Floor or	wal	
Usable Energy	13.5 kWh		¹ Dimensions and weight differ slightly Contact Tesla for additional information			
Real Power, max continuous	5 kW (charge and discharge)		753 mm (29.6 in)			
Real Power, peak (10 s, off-grid/backup)	7 kW (charge and discharge)	-	-	-		
Apparent Power, max continuous	5.8 kVA (charge and discharge)					
Apparent Power, peak (10 s, off-grid/backup)	7.2 kVA (charge and discharge)		T = 5 l			
Maximum Supply Fault Current	10 kA					
Maximum Output Fault Current	32 A					
Overcurrent Protection Device	30 A					
Imbalance for Split-Phase Loads	100%					
Power Factor Output Range	+/- 1.0 adjustable					
Power Factor Range (full-rated power)	+/- 0.85					
Internal Battery DC Voltage	50 V					
Round Trip Efficiency ^{1,3}	90%	E	-			
Warranty	10 years	ENVIRON	NMENTAL S	PECIFIC	A	

COMPLIANCE INFORMATION

²In Backup mode, grid charge power is limited to 3.3 kW.

³AC to battery to AC, at beginning of life.

TESLA

¹Values provided for 25°C (77°F), 3.3 kW charge/discharge powe

Certifications	UL 1642, UL 1741, UL 1973,	
	UL 9540, IEEE 1547, UN 38.3	
Grid Connection	Worldwide Compatibility	
Emissions	FCC Part 15 Class B, ICES 003	
Environmental	RoHS Directive 2011/65/EU	
Seismic	AC156, IEEE 693-2005 (high)	

Dimensions¹ Weight¹ Mounting options		1150 mm x 755 mm x 147 mm (45.3 in x 29.6 in x 5.75 in) 114 kg (251.3 lbs) Floor or wall mount				
					T S L A	147 mm (5.75 in) 1150 mm (45.3 in)

ATIONS

Operating Temperature	-20°C to 50°C (-4°F to 122°F)
Recommended Temperature	0°C to 30°C (32°F to 86°F)
Operating Humidity (RH)	Up to 100%, condensing
Storage Conditions	-20°C to 30°C (-4°F to 86°F) Up to 95% RH, non-condensing State of Energy (SoE): 25% initial
Maximum Elevation	3000 m (9843 ft)
Environment	Indoor and outdoor rated
Enclosure Type	NEMA 3R
ngress Rating	IP67 (Battery & Power Electronics) IP56 (Wiring Compartment)
Wet Location Rating	Yes
Noise Level @ 1m	< 40 dBA at 30°C (86°F)

TESLA.COM/ENERGY

-chargepoin+

ChargePoint Home Flex Specifications and Ordering Information

Ordering Information

Description		Model Number
	16A-50A, NEMA 6-50 plug, 7010.4 mm (23') Charging Cable	CPH50-NEMA6-50-L23
	16A-50A, NEMA 14-50 plug, 7010.4 mm (23') Charging Cable	CPH50-NEMA14-50-L23
Replacement Cable	7010.4 mm (23') Charging Cable	CPH50Cable-T1-50A-L23-F



ChargePoint® Home Flex

Shell: Eclipse | Cabinet: Charcoal

works with amazon alexa



312 W Hyman Ave Lots P+Q, Block 46 Aspen CO 81611 USA/

design. Ilc

Jeffrey H. Woodruff

AIA, NCARB, LEED AP

Cloud Hill Design, LLC

Snowmass CO 81654 USA

INTEGRATED DESIGN TEAM

Civil Grading and Drainage Jay Engstrom, P.E. Crystal River Civil, LLC

Structural Engineer Brian Rossiter, P.E.

Contractor Adam Rothberg Rothberg Development

bwr.pe

Landscape Architect Jennifer M. Dolecki-Smith, RLA Escape Garden Design, LLC

Pitkin County UGB, City of Aspen

312 W Hyman Ave Aspen CO 81611 USA

Powder Day Skiiing, LLC, David A **Tarrab Mees**

Account # R000145 Parcel ID # 273512464006

08/22/21 COA- HPO Site Visit

02/26/22 COA- HPC Conceptual I

04/27/22 COA- HPC Conceptual II

07/27/22 COA- HPC Final

10/12/22 COA- City Council Call Up

04/12/23 COA- HPC Substantial

06/28/23 COA- Permit Submittal

07/29/24 COA- Building comments, #4

PROJECT NO: Project No. 116 MODEL FILE:

312_W_Hyman_07292024.pln DRAWN BY: Jeffrey H Woodruff

SHEET TITLE

COPYRIGHT:


Electrical- Exterior

A- E102

SHEET 67

Lower Level PUZ-HA42NKA1 0.0 ft Pipe Dia. Liquid / Gas Model 19611156. LL Living/Mud 7.9 357 Pipe Length (Elbows) Address/Group / Room / Tag Ref. Bath 2 1.2 6.2 32,351 BTU/h (30,523 BTU/h) Est. Cooling Discharge Air Temp: 60.6 a4,086 BTU/h Est. Heating Discharge Air Temp: 91.3 2.7 7.7 Bed 3 16.0ft (4) 2.3 34.1 16 770 PVA-A42AA7 33.3 32.1 1040 PUZ-HA42NKA1 Pipe Dia. Liquid / Gas Model Number Elevation Clg Total (5 Htq.Total | 1 Htq.Total | 1 Address/Group / Room / Tag Ref. PUZ-HA42NKA1 0.0 ft Upper Level Great Room 12.2 609 32,142 BTU/h (28,161 BTU/h) Est. Cooling Discharge Air Temp: 62.1 33,345 BTU/h Est. Heating Discharge Air Temp: 90.8 4.3 Bedroom 1 2.3 124 Bath 1 & closet 34.3 18.8 32.4 1024 PEAD-A42AA7 PUZ-HA42NKA1 EH10-MPA-LB



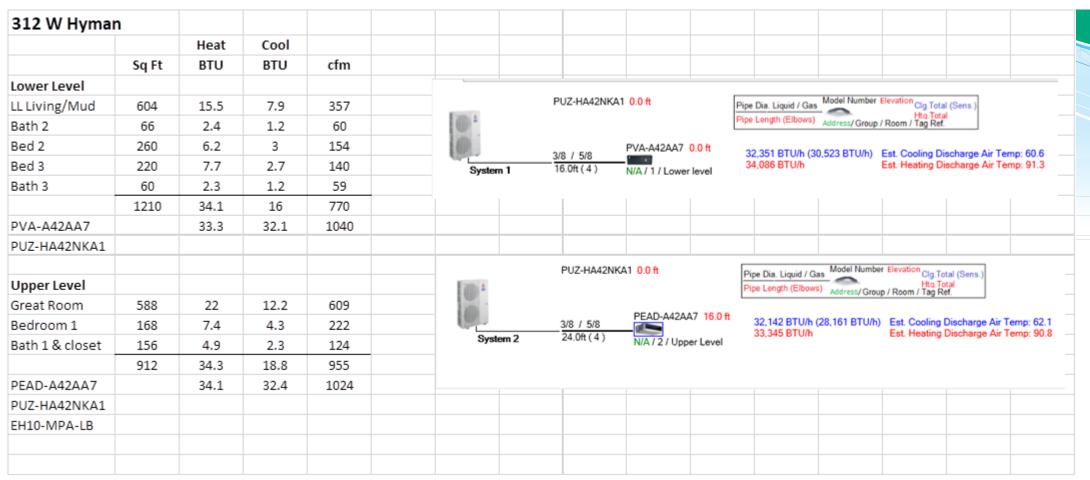

312 W Hyman Cold Sourced Heat Pump- Manual J

CLASSIC SERIES NORDIC HOT TUBS

CROWN XL DIMENSIONS Seating 6 person

84 in (213 cm) Diameter Depth 38.5 in (89 cm) 400 lbs (181 kg) Weight (Dry) 330 gal (1249 L) Operating Capacity

JETS Total Jets

5" Nordic Star™ Directional Whirlpool 5" Nordic Star™ Dual Rotational 3" Nordic Star™ Directional 3" Nordic Star™ Dual Rotational 2" Nordic Star™ Directional 1" Ozone Ready Jet (Ozonator Optional)

EQUIPMENT

Bluetooth Stereo

220v Amps Control Pad 4 button Topside w/LED Display Insulation: Foam (Standard) Nordic Wrap (Optional) Footwell LED (Standard) Mood Lighting Package (Optional) Pump (1) 3hp Continuous Duty

Color samples are for reference only. Actual product color may vary slightly.

Nordic Products Inc. reserves the right to change any specifications without notice.



Optional Upgrade