A.F.F.	ABOVE FINISH FLOOR	INFO.	INFORMATION
ADJ.	ADJUSTABLE	INSUL.	INSULATION
ALT.	ALTERNATE	JST.	JOIST
A.B.	ANCHOR BOLTS	L.L.	LIVE LOAD
&	AND	LONGINT.	LONGITUDINAL
ARCH.	ARCHITECTURAL	N.I.C.	NOT IN CONTRACT
(a),	AT	O.C.	ON CENTER
BM.	BEAM	OPP.	OPPOSITE
BM. PKT.	BEAM POCKET	O/	OVER
BRG.	BEARING	PTD.	PAINTED
BLK'G.	BLOCKING	PERF.	PERFORATED
BOT.	BOTTOM	PL.	PLATE
B.F.	BOTTOM OF FOOTING	PLY.	PLYWOOD
BLDG.	BUILDING	PROP. LINE	PROPERTY LINE
B.O.	BY OWNER	REINF.	REINFORCEMENT
CAB.	CABINET	RDWD.	REDWOOD
CLG.	CEILING	REQ'D.	REQUIRED
CL.	CENTER LINE	RESIL.	RESILIENT
C.T.	CERAMIC TILE	REV.	REVISED
CLR.	CLEAR	S.M.	SHEET METAL
COL.	COLUMN	SIM.	SIMILAR
CONC.	CONCRETE	S.F. OR SQ. FT.	SQUARE FEET
CONN.	CONNECTION	STD.	STANDARD
CONT.	CONTINUOUS	STL.	STEEL
DTL.	DETAIL	STDS.	STUDS
DBL.	DOUBLE	THK.	THICK
DWL.	DOWEL	TLT.	TOILET
E.W.	EACH WAY	T.F.	TOP OF FOOTING
ELEV. OR	ELEVATION	T.P.	TOP OF PLATE
EL.	EXISTING	T.L.	TOP OF LEDGE
EXIST'G	EXTERIOR	T.W.	TOP OF WALL
EXT.	FINISHED FLOOR	TOT.	TOTAL
F.F.	FLOOR DRAIN	T.B.	TOWEL BAR
F.D.	FLOOR	TRANSV.	TRANSVERSE
FLR.	FOOTING	TYP.	TYPICAL
FTG.	FOUNDATION	U.N.O.	UNLESS NOTED OTHERW
FND.	GAUGE	V.I.F.	VERIFY IN FIELD
GA.	GLU-LAM	VERT.	VERTICAL
G.L.	GYPSUM WALL BOARD	V.W.C.	VINYL WALL COVERING
G.W.B.	GAS STUB	W.C.	WATER CLOSET
G.S.	HOSE BIB	W.H.	WATER HEATER
HB.	HEIGHT	W.P.	WATERPROOF
HT.	HOOK	W.R.	WATER RESISTANT
		TTTTNT	

WIN.

W/

WD.

HORIZONTAL

HYDRANT

HORIZ.

HYD.

WINDOW

WITH

WOOD

312 W Hyman Ave Powder Day Skiiing, LLC, David A Tarrab Mees

312 W Hyman Ave Lots P+Q, Block 46 Aspen CO 81611 USA/Pitkin County UGB, City of Aspen

PROJECT: Renovation, Energy Upgrades and Historic Preservation ADDRESS: 312 W Hyman Ave, Aspen, CO 81611

COUNTY: Pitkin County PARCEL NUMBER: 2735-124-64-006

Interior Renovation and Energy Upgrades, IECC Compliance PROJECT DESCRIPTION:

ZONING: R6 Medium Density Residential

CONSTRUCTION TYPE: OCCUPANCY GROUP: RESIDENTIAL FIRE PROTECTION: Non-sprinklered NUMBER OF STORIES: TWO

ELEVATION 100= 7901.36' SITE RS6 = 6000 SF

BUILDING

Currently Adopted COA I-Codes.

The client will conform with currently adopted IECC (Assemblies and Fenestration) and the updated land use code for Energy Efficiency on Earth Day 2020.

Snow-load: Up to 8000' Elevation, Elevation is 7901.36' Building 100' as per Civil = 7901.36', Garage = 7902.86'

Roof Duration = 1.0Seismic Design Category = B or C, as per Figure R301.2 (2) As per soil design category

Weathering probability for Concrete = Severe Termite Infestation Probability = None to slight Wind Speed = 115 mph (ultimate design) Wind Exposure = B or C, Section R301.2.1.4 Frost Depth = 36", up to 8000' Elevation

Ice Barrier Underlayment = Required Mean Annual Temp = variable

Insulation = as per Minimum R-Values per 2021 IECC, Table 402.1.1 As per State House Bill 09-1091, CO alarms are required within 15 feet of all sleeping rooms

Project summary as per Land Use Code:

1. The historic building and the site remains key elements of the property and the new development does not compromise the visual integrity of the historic property; and

2. The new construction is reflective of the proportional patterns found in the historic building's forms, materials and openings, or the work removes later alterations and restores the historic building to its appearance during its period of

3. The project is compatible with the character of the neighborhood in which it is located; and

4. Historic outbuildings site and landscape features are retained and stabilized and restored, as appropriate.

The project conforms to City of Aspen Chapter 26: Title 26- Land Use Regulations

Part 400- Development Permit as of Right

Part 500- Supplementary Regulations





Relationship to the Neighborhood

1. CONTRACTOR TO COMPLY WITH CODES, LAWS, ORDINANCES, RULES, AND REGULATIONS OF PUBLIC AUTHORITIES GOVERNING THE WORK.

2. CONTRACTOR TO REVIEW DOCUMENTS, VERIFY DIMENSIONS AND FIELD CONDITIONS AND CONFIRM THAT WORK IS BUILDABLE AS SHOWN, CONTRACTOR TO REPORT ANY CONFLICTS OR OMISSIONS TO THE ARCHITECT FOR CLARIFICATION PRIOR TO PERFORMING ANY WORK IN QUESTION. 3. FOR SUBSTITUTIONS, REFER TO THE SPECIFICATIONS.

4. DO NOT SCALE DRAWINGS. DIMENSIONS SHALL TAKE PRECEDENCE OVER SCALES SHOWN ON DRAWINGS, GENERAL CONTRACTOR SHALL VERIFY ALL DIMENSIONS, GRADES AND CONDITIONS AT

PRIOR TO COMMENCING THE WORK. 5. MAINTAIN DIMENSIONS MARKED 'CLEAR'. ALLOW FOR THICKNESS OF FINISHES.

6. CEILING HEIGHT DIMENSIONS ARE TO FINISHED SURFACES.

7. CONTRACTOR TO COORDINATE AND PROVIDE BACKING FOR MILLWORK AND ITEMS ATTACHED OR MOUNTED TO WALLS OR CEILINGS.

8. EXCEPT WHERE SHOWN IN DIMENSIONAL DETAIL, THE LOCATIONS OF PLUMBING, MECHANICAL EQUIPMENT. DUCTS, PIPING AND FITTINGS ARE ONLY APPROXIMATE. THE EXACT LOCATIONS SHALL BE DETERMINED BY THE CONTRACTOR, SUBJECT TO APPROVAL BY THE ARCHITECT. 9. CONTRACTOR SHALL PROVIDE AND INSTALL ALL STIFFENERS, BRACING, BLOCKING, AND

SUPPORTING BRACKETS REQUIRED FOR THE INSTALLATION OF ALL CASEWORK. TOILET ROOM ACCESSORIES, FIXTURES AND PARTITIONS AND ALL WALL MOUNTED OR SUSPENDED MECHANICAL,

ELECTRICAL OR MISCELLANEOUS EQUIPMENT AND FURNISHINGS.

10. ALL WORK PERFORMED SHALL COMPLY WITH THE CONTRACT DOCUMENTS, DRAWINGS, SPECIFICATIONS, AND GEOTECHNICAL INVESTIGATION AND PAVEMENT RECOMMENDATIONS.

11. SPECIFICATIONS, BOUND SEPARATELY, ARE PART OF THE CONTRACT DOCUMENTS. 12. ALL MATERIALS AND WORKMANSHIP SHALL CONFORM TO THE DRAWINGS AND SPECIFICATIONS. IF

CONFLICT IS FOUND BETWEEN DRAWINGS, GENERAL NOTES AND SPECIFICATIONS, CONSULT THE ARCHITECT BEFORE PROCEEDING WITH THE WORK. 13. THE STRUCTURAL, MECHANICAL AND ELECTRICAL DRAWINGS ARE SUPPLEMENTARY TO THE

ARCHITECTURAL DRAWINGS. IT SHALL BE THE RESPONSIBILITY OF THE CONTRACTOR TO CHECK WITH THE ARCHITECTURAL DRAWINGS BEFORE THE INSTALLATION OF STRUCTURAL, MECHANICAL AND ELECTRICAL WORK. SHOULD THERE BE A DISCREPANCY BETWEEN THE ARCHITECTURAL DRAWINGS

THE CONSULTING ENGINEERS' DRAWINGS THAT WOULD CAUSE AN AWKWARD INSTALLATION, IT SHALL

BROUGHT TO THE ARCHITECT'S AND ENGINEERS' ATTENTION FOR CLARIFICATION PRIOR TO THE INSTALLATION OF SAID WORK.

14. GENERAL NOTES ARE NOT A SUBSTITUTE NOR A REPLACEMENT FOR THE PROJECT SPECIFICATIONS. THESE NOTES ARE INTENDED AS A GUIDE TO THE DESIGN AND/OR CONSTRUCTION REQUIREMENTS ESTABLISHED FOR THIS PROJECT.

15. NO CONTRACTOR SHOULD ATTEMPT TO BID OR CONSTRUCT ANY PORTION OF THE WORK WITHOUT CONSULTING THE PROJECT SPECIFICATIONS.

16. THE CONTRACTOR SHALL COORDINATE THE INTENT OF THE GENERAL NOTES WITH ALL TRADES



SHEET INDEX A001 Cover Sheet Improvement Survey V2 Topographic Survey Plat C.001 Title Snowmass CO 81654 USA C.002 **Existing Conditions** C.003 **Demolition Plan** C.004 Grading Plan C.005 Basins INTEGRATED DESIGN TEAM C.006 Subbasins Civil Grading and Drainage Jay Engstrom, P.E. Crystal River Civil, LLC Drainage Layout Drainage Profiles Landscape Architect C.009 Utility Plan Jennifer M. Dolecki-Smith, RLA Escape Garden Design, LLC **Erosion Control** Structural Engineer Brian Rossiter, P.E. C.011 Details bwr.pe Engineering & Drainage Report Contractor Engineering & Drainage Report Adam Rothberg Tree Removal and Mitigation Rothberg Development L2.002 Proposed Landscape Plan General Notes and Typical Details S 1.0 Foundation Plan S 1.1 Upper Level & Garage Roof Framing Plans S1.2 Roof Framing Plan S2.0 Details S2.1 Details SH-1 Shoring Plan Floor Area Calculations

Z002

Z003

Z005

Z006

A202

A300

A500

A501

Floor Area Calculations

Height Measurements

Forestry Site Coverage

HPC Approved and SAM Architectural Site Plan

Contractor Site Plan CMP

Main Level Proposed Plan Second Level Proposed Plan

Roof Plan Proposed

Roof Plan Existing

Second Level RCP

Interior Stairs Enlarged

Elevations Proposed

Elevations Proposed

Existing Elevations

Existing Elevations

Garage Elevations

Building Sections

Bedroom #3

Bedroom #1

Schedules

Schedules

A- E101 Electrical- Lamps A- E102 Electrical- Exterior

A - P100 Plumbing Narrative

Main Level RCP

Main Level Existing Plan

Second Level Existing Plan

Exterior Stairways Enlarged

Interior Elevations Entry & Gym

Interior Elevations Kitchen/Dining

Interior Elevations Bedroom #2 Bathe #2

Interior Elevations 1/2 & Mud

Bedroom # 1 Bathe #1

Interior Elevations Living

Finish Flooring Plan

Interior Elevations Storage

Second Level Finish Flooring

Assemblies- Skylights, Fenestration

Assemblies & Plan Details

Site Coverage

Zoning Summary

Wall Demolition Calculations

Existing, HPC Approved, HPO Approved

407325

cloud hill

design. llc

Jeffrey H. Woodruff

AIA, NCARB, LEED AP

Cloud Hill Design, LLC

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10/28/24 Interiors

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SHEET TITLE

Cover Sheet

Architectural Site Plan

SCALE: 1/8" = 1'-0"



Jeffrey H. Woodruff AIA, NCARB, LEED AP Cloud Hill Design, LLC Snowmass CO 81654 USA

INTEGRATED DESIGN TEAM
Civil Grading and Drainage

Civil Grading and Drainage Jay Engstrom, P.E. Crystal River Civil, LLC

Landscape Architect Jennifer M. Dolecki-Smith, RLA Escape Garden Design, LLC

Structural Engineer Brian Rossiter, P.E. bwr.pe

Contractor Adam Rothberg Rothberg Development



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Architectural Site Plan

A101



INTEGRATED DESIGN TEAM

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Contractor Site Plan CMP

A102

SHEET 41

CMP Site Plan

SCALE: 1/4" = 1'-0"



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Main Level Proposed Plan

A103


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(**D**)

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SHEET TITLE

Second Level Proposed Plan

A104

SHEET 43

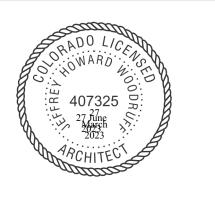Smoke Alarms

R314.2.1 New Construction-provided in dwelling units

R314.3 Location in each sleeping room, outside each separate sleeping area in the immediate vicinity of the bedrooms Required in uninhabitable attics

R314.3.1 Installation near cooking appliances R314.5 Combination alarms-


combination smoke and carbon monoxide alarms shall be permitted (in lieu of smoke alarms) In every bedroom (habitable space), outside every bedroom and on every floor and garage, monitored


Heat detection, in each mechanical space and in the garage (as per AFPD/AHJ), monitored


Carbon Monoxide Alarms R315.2.1 Carbon Monoxide New Construction- required due to attached garage with an opening that communicates with the dwelling unit.

R315.3 Location- in dwelling units, outside of each separate sleeping area in the vicinity of the bedrooms.

As per AFPD Heat detection in Mechanical and

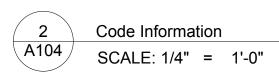

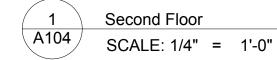

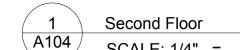

Today this is a cold roof with attic vents. The current attic vents and

screens are in disrepair (upon viewing from the attic). We are

exposing the rafters, adding insulation and updating the light and

The attic vent(s) will be converted to fenestration of the same size

rough opening, (a hopper for light and vent, will not interfere with

Section R910 Snow shed design. Roofs shall be designed so

that they do not shed ice and snow onto adjoining properties or

potentially occupied areas such as a walkway, stairway, alley,

where there is potential for personal injury or property damage

Section 1513 Snow shed design. Roofs shall be designed so

that they do not shed ice and snow onto adjacent properties and potentially occupied areas such as a walkway, stairway, alley,

where there is potential for personal injury or property damage

Roof Plan

SCALE: 1/4" = 1'-0"

deck, pedestrian and vehicular exit from buildings or areas

and areas directly above or in front of gas utility or electric

deck, pedestrian and vehicular exit from buildings or areas

and areas directly above or in front of gas utility or electric

Two bar snow pipes as per submittal, specifications.

removing the dropped ceiling, removing the attic vents and

U-Value for horizontal fenestration = .50 as per IECC 2021


vent in a Chalet style.

the south facing Juliet balcony).

utility meters. (Ord. 40-2016)

utility meters.

As per currently adopted IRC

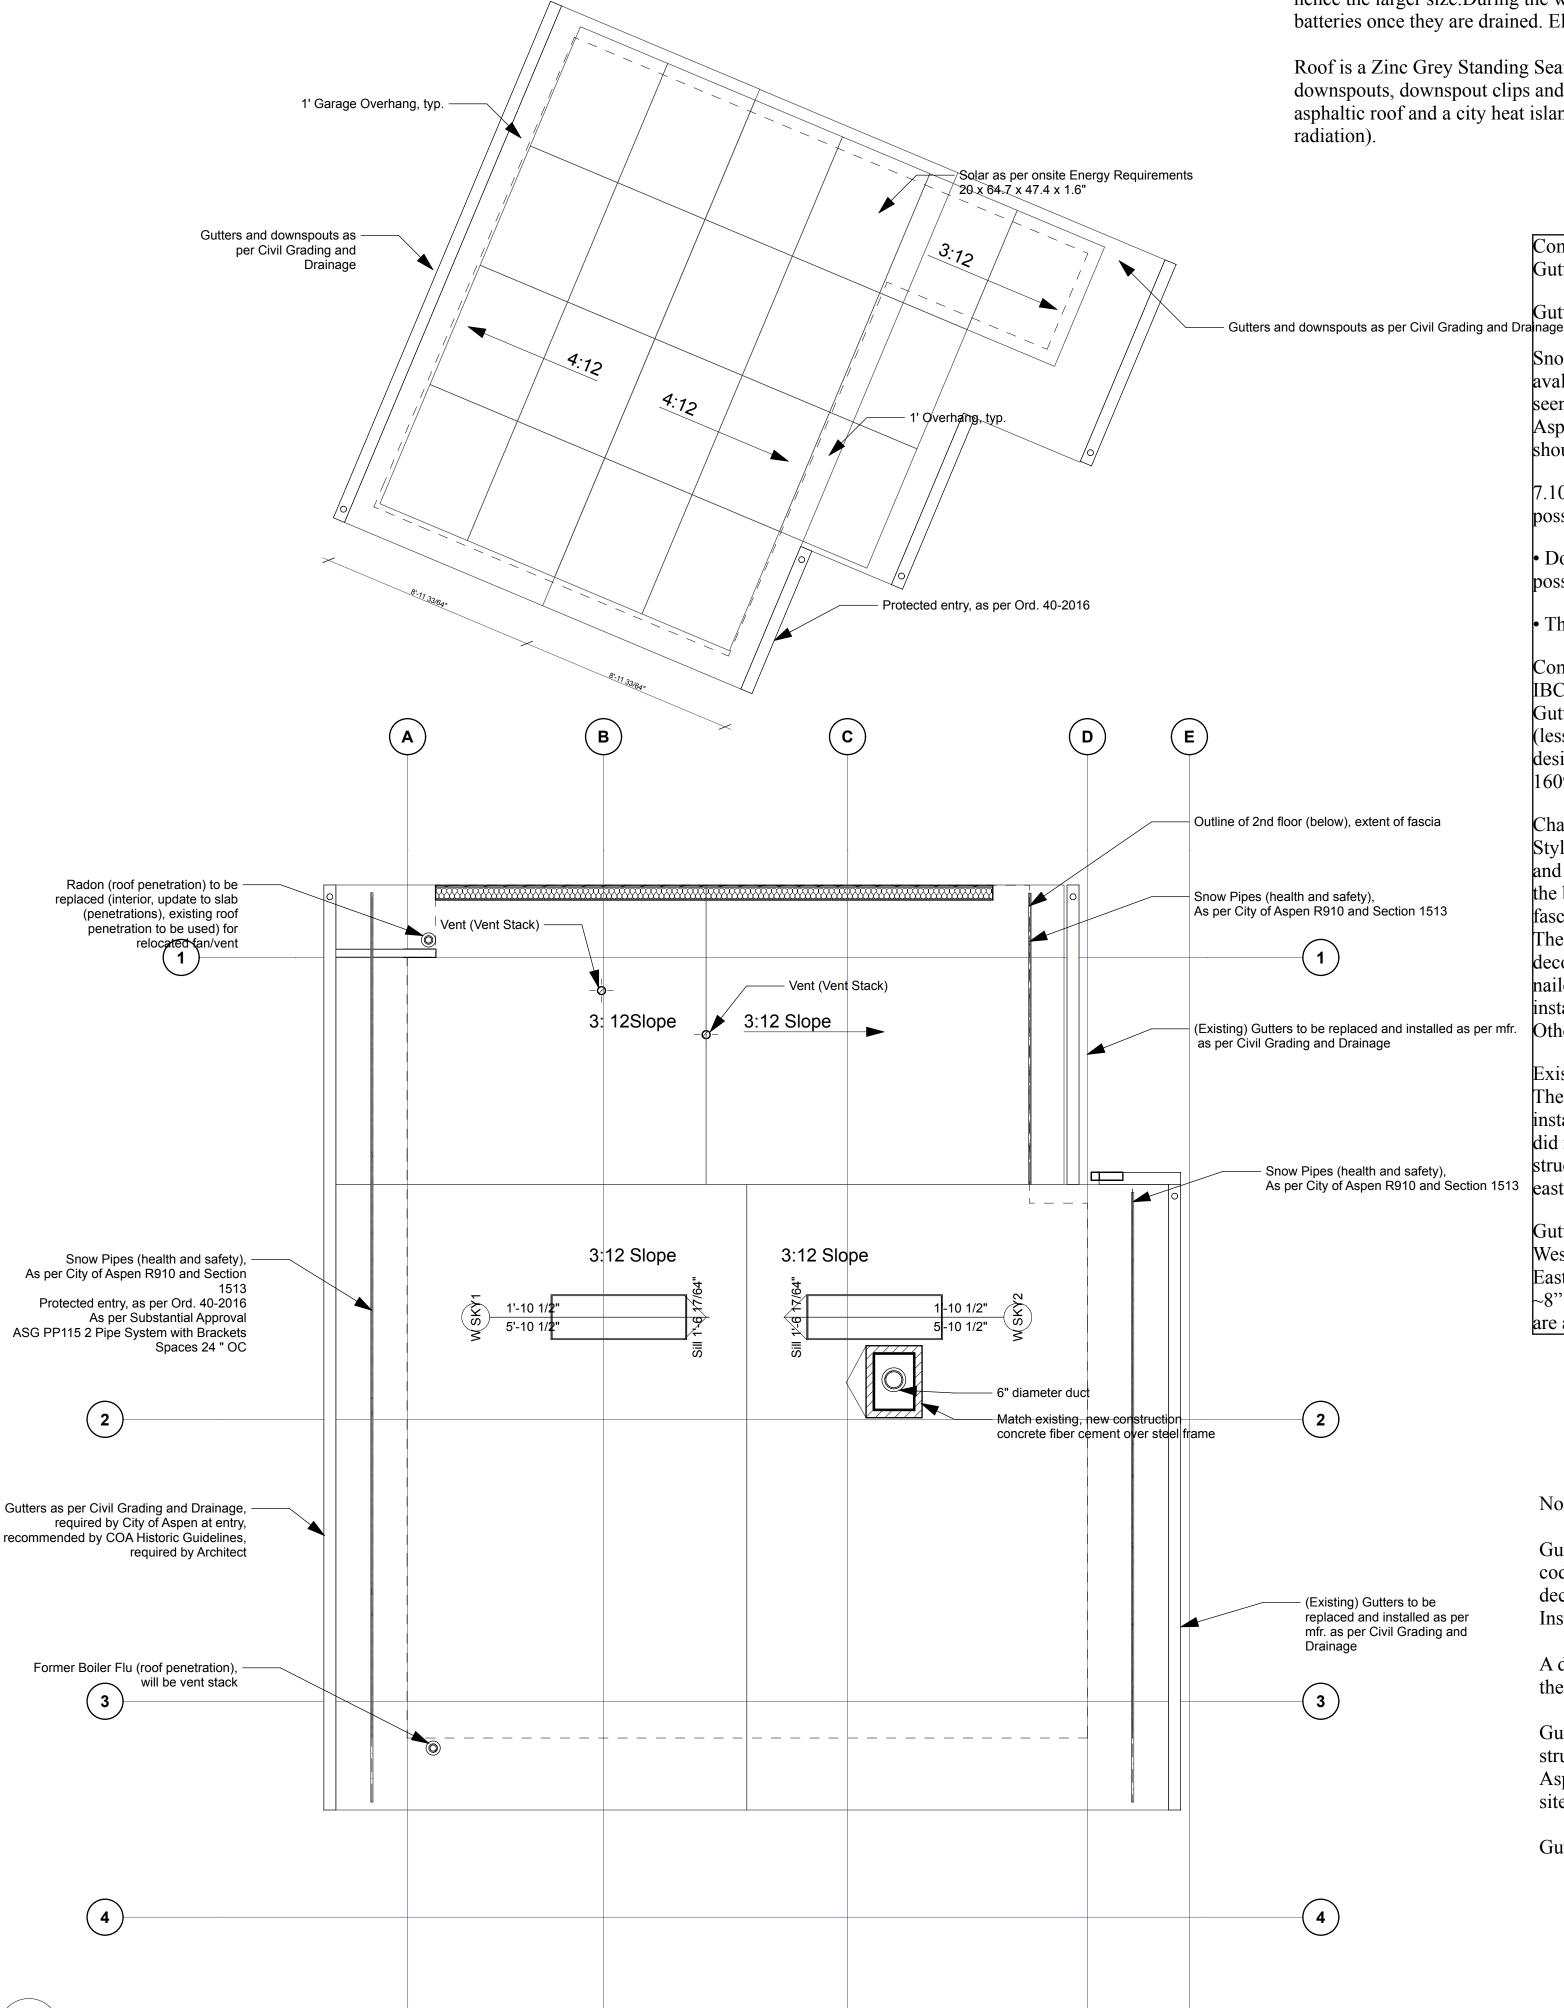

6kw solar electric system for (2) separate meters based on 16 panels on the garage. With 10% shade loss and 15% snow loss for the year the system will produce about 14,862kWh. For the batteries= (5). The homeowner's goals are to have the batteries supplying power for both panels during a grid outage for hours or days during the winter, hence the larger size. During the winter with snow coverage, the panels would not produce much to replenish the batteries once they are drained. Electric car charger hook up as per City of Aspen.

Roof is a Zinc Grey Standing Seam Tee-Panel (profile) Metal Roof by Berridge Manufacturing Company. Gutters, downspouts, downspout clips and elbows are all Zinc Grey. Fascia is Zinc Grey. (The main chalet is a black asphaltic roof and a city heat island. The garage will be Zinc Grey and the solar panels will absorb the solar

> Complying with Chapter 7 Historic Preservation Guidelines Gutters, Downspouts, Snowstops, and Snow Fences

Gutters and downspouts are used to divert water away from a structure.

Snow fences are used to protect inhabitants and the building from the sudden snow avalanches that rip off architectural details and can cause serious injury. Gutters can be seen in some 19th century photos of historic buildings and are more common on AspenModern structures. Overall, the visual impact of these functional elements should be minimized.

- 7.10 Design gutters so that their visibility on the structure is minimized to the extent
- Downspouts should be placed in locations that are not visible from the street if possible, or in locations that do not obscure architectural detailing on the building.
- The material used for the gutters should be in character with the style of the building.

Complying with IBC

IBC 1504.6.1Gutter securement for low-slope roofs.

Gutters that are used to secure the perimeter edge of the roof membrane on low-slope (less than 2:12 slope) built-up, modified bitumen, and single-ply roofs, shall be designed, constructed and installed to resist wind loads in accordance with Section 1609 and shall be tested in accordance with Test Methods G-1 and G-2 of SPRI GT-1

Character of gutter, downspout, downspout straps and elbows

Style of Gutter: Box Style A1, 24 Gage Galvalume, Box Downspout, downspout straps and Elbow in 3" x 4" in 24 Gage Galvalume, color to match decorative trim. (Today the brown decorative fascia has a brown gutter in ~K style on the East decorative

The existing gutters to be removed, and re-installed with Box Style A1 to match the decorative trim. Blocking should be added (interior face of the decorative trim, toe nailed to the rafters, painted to match and guarddog 2" (or sim.) screws should used to linstall the new gutters (piercing the decorative trim and the newly installed blocking) (Existing) Gutters to be replaced and installed as per mfr. Otherwise the existing (east) gutters will shear from the decorative trim.

Existing conditions

The decorative fascia is not covered by the current East gutters. The former owner installed gutters without accounting for the run off from the west side of the site and did not file a construction management plan; so the water is imperiling the fascia, the structure and not handled onsite as per City Engineering. The installed gutters on the east side of the building threaten the decorative fascia.

Gutters, Box Style A measure 3" deep/high and 4" wide (minimum as per mfr.) West: The interior measurement of the fascia on the West is 10 1/4" deep/high. East: The east gutters will not cover the decorative fascia, which appear narrower at ~8" deep. The east gutters, as currently installed do not cover the decorative facia, but are a building and health and safety concern (all hardware daylights, shiners, typ).

Note:

Gutters exist on the East fascia, as per City of Aspen adopted building code, they were not properly installed and jeopardize the historic decorative trim.

Install as per mfr. with blocking toenailed to the rafters, as per arch.

A dry well holds run-off from the east gable. The Trex deck drains to the dry well to the south.

Gutters on the west gable and a new dry well to the North of the structure bring the historic structure into compliance with the city of Aspen adopted building code (protection of occupants at entry and onsite capture and dispersion of water events).

Gutters and snow guards are required as per city of aspen 2016 Ord .40.



N



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bwr.pe



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SHEET TITLE

Roof Plan Proposed

A105



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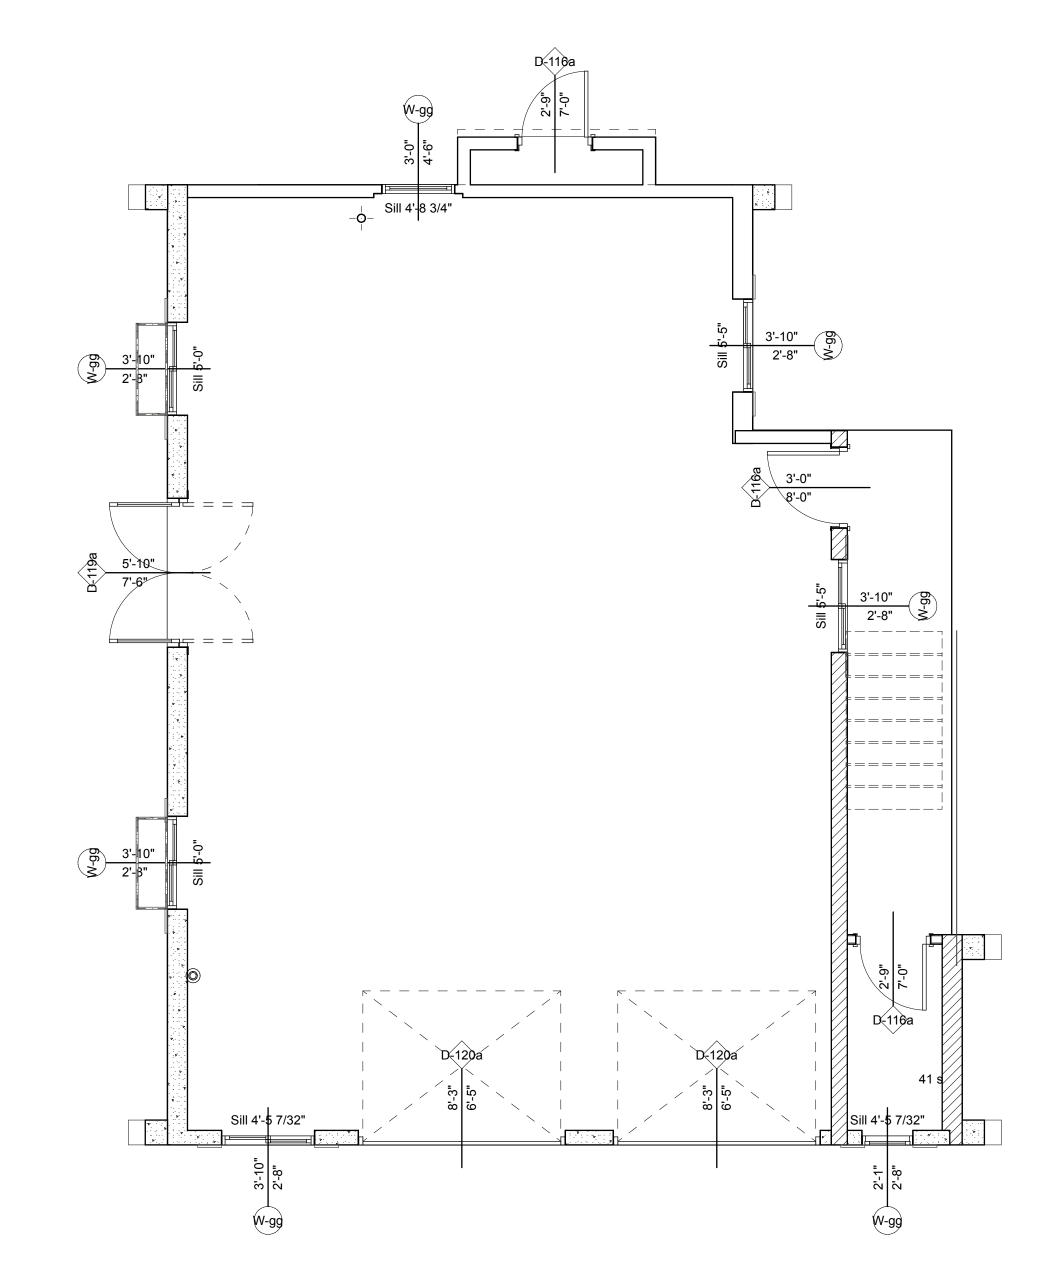
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SHEET TITLE

Main Level Existing Plan

A106





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1 Z004



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10/25/24 COA- Vault Setback, #5

10/28/24 Interiors

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N

Second Level Existing Plan

A107

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Civil Grading and Drainage
Jay Engstrom, P.E.
Crystal River Civil, LLC

Landscape Architect
Jennifer M. Dolecki-Smith, RLA
Escape Garden Design, LLC

Structural Engineer
Brian Rossiter, P.E.
bwr.pe

Contractor Adam Rothberg Rothberg Development



312 W Hyman Ave
312 W Hyman Ave Lots P+Q,
Block 46 Aspen CO 81611 USA/
Pitkin County UGB, City of Aspen

312 W Hyman Ave Aspen CO 81611 USA

Powder Day Skiiing, LLC, David A Tarrab Mees

Account # R000145 Parcel ID # 273512464006

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10/28/24 Interiors

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MODEL FILE:
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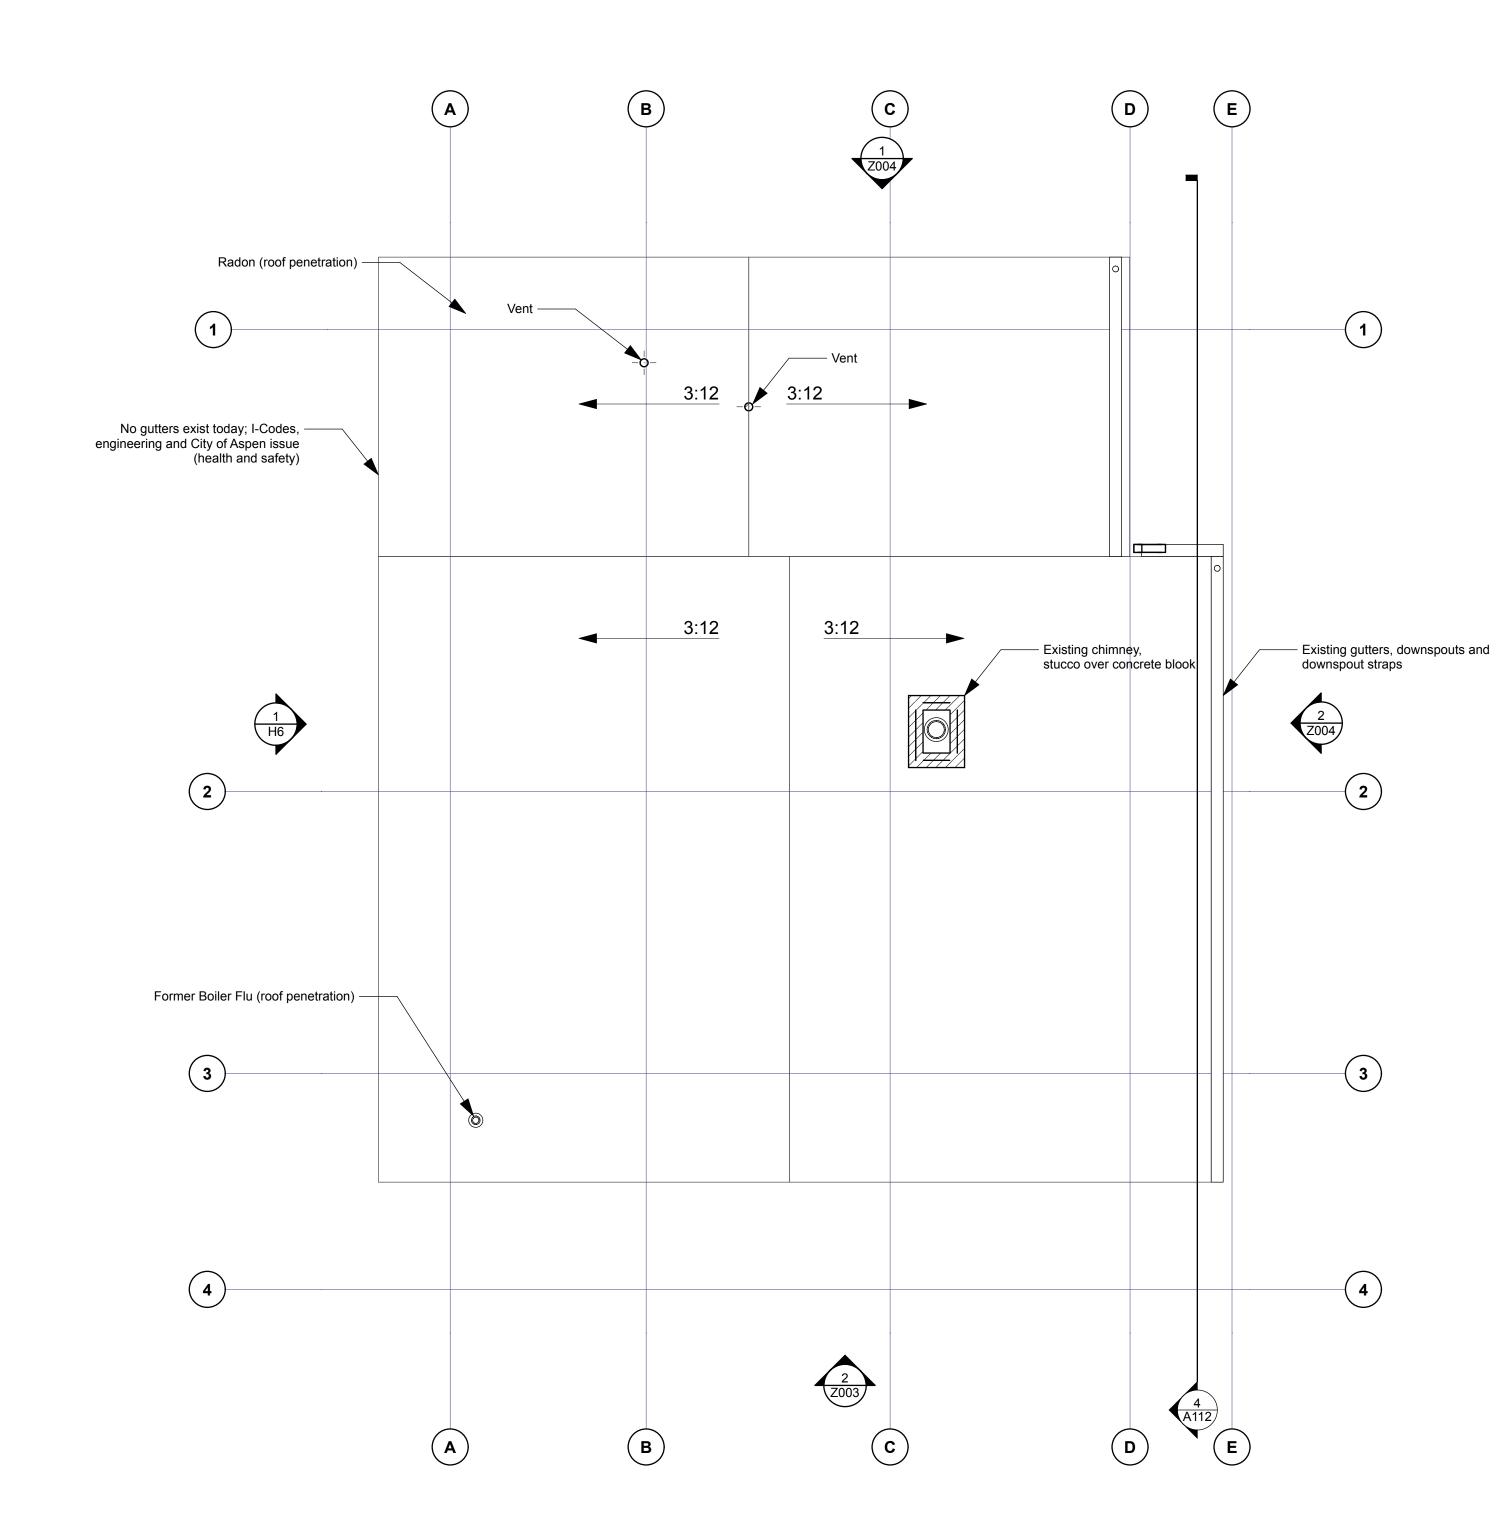
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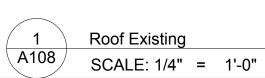
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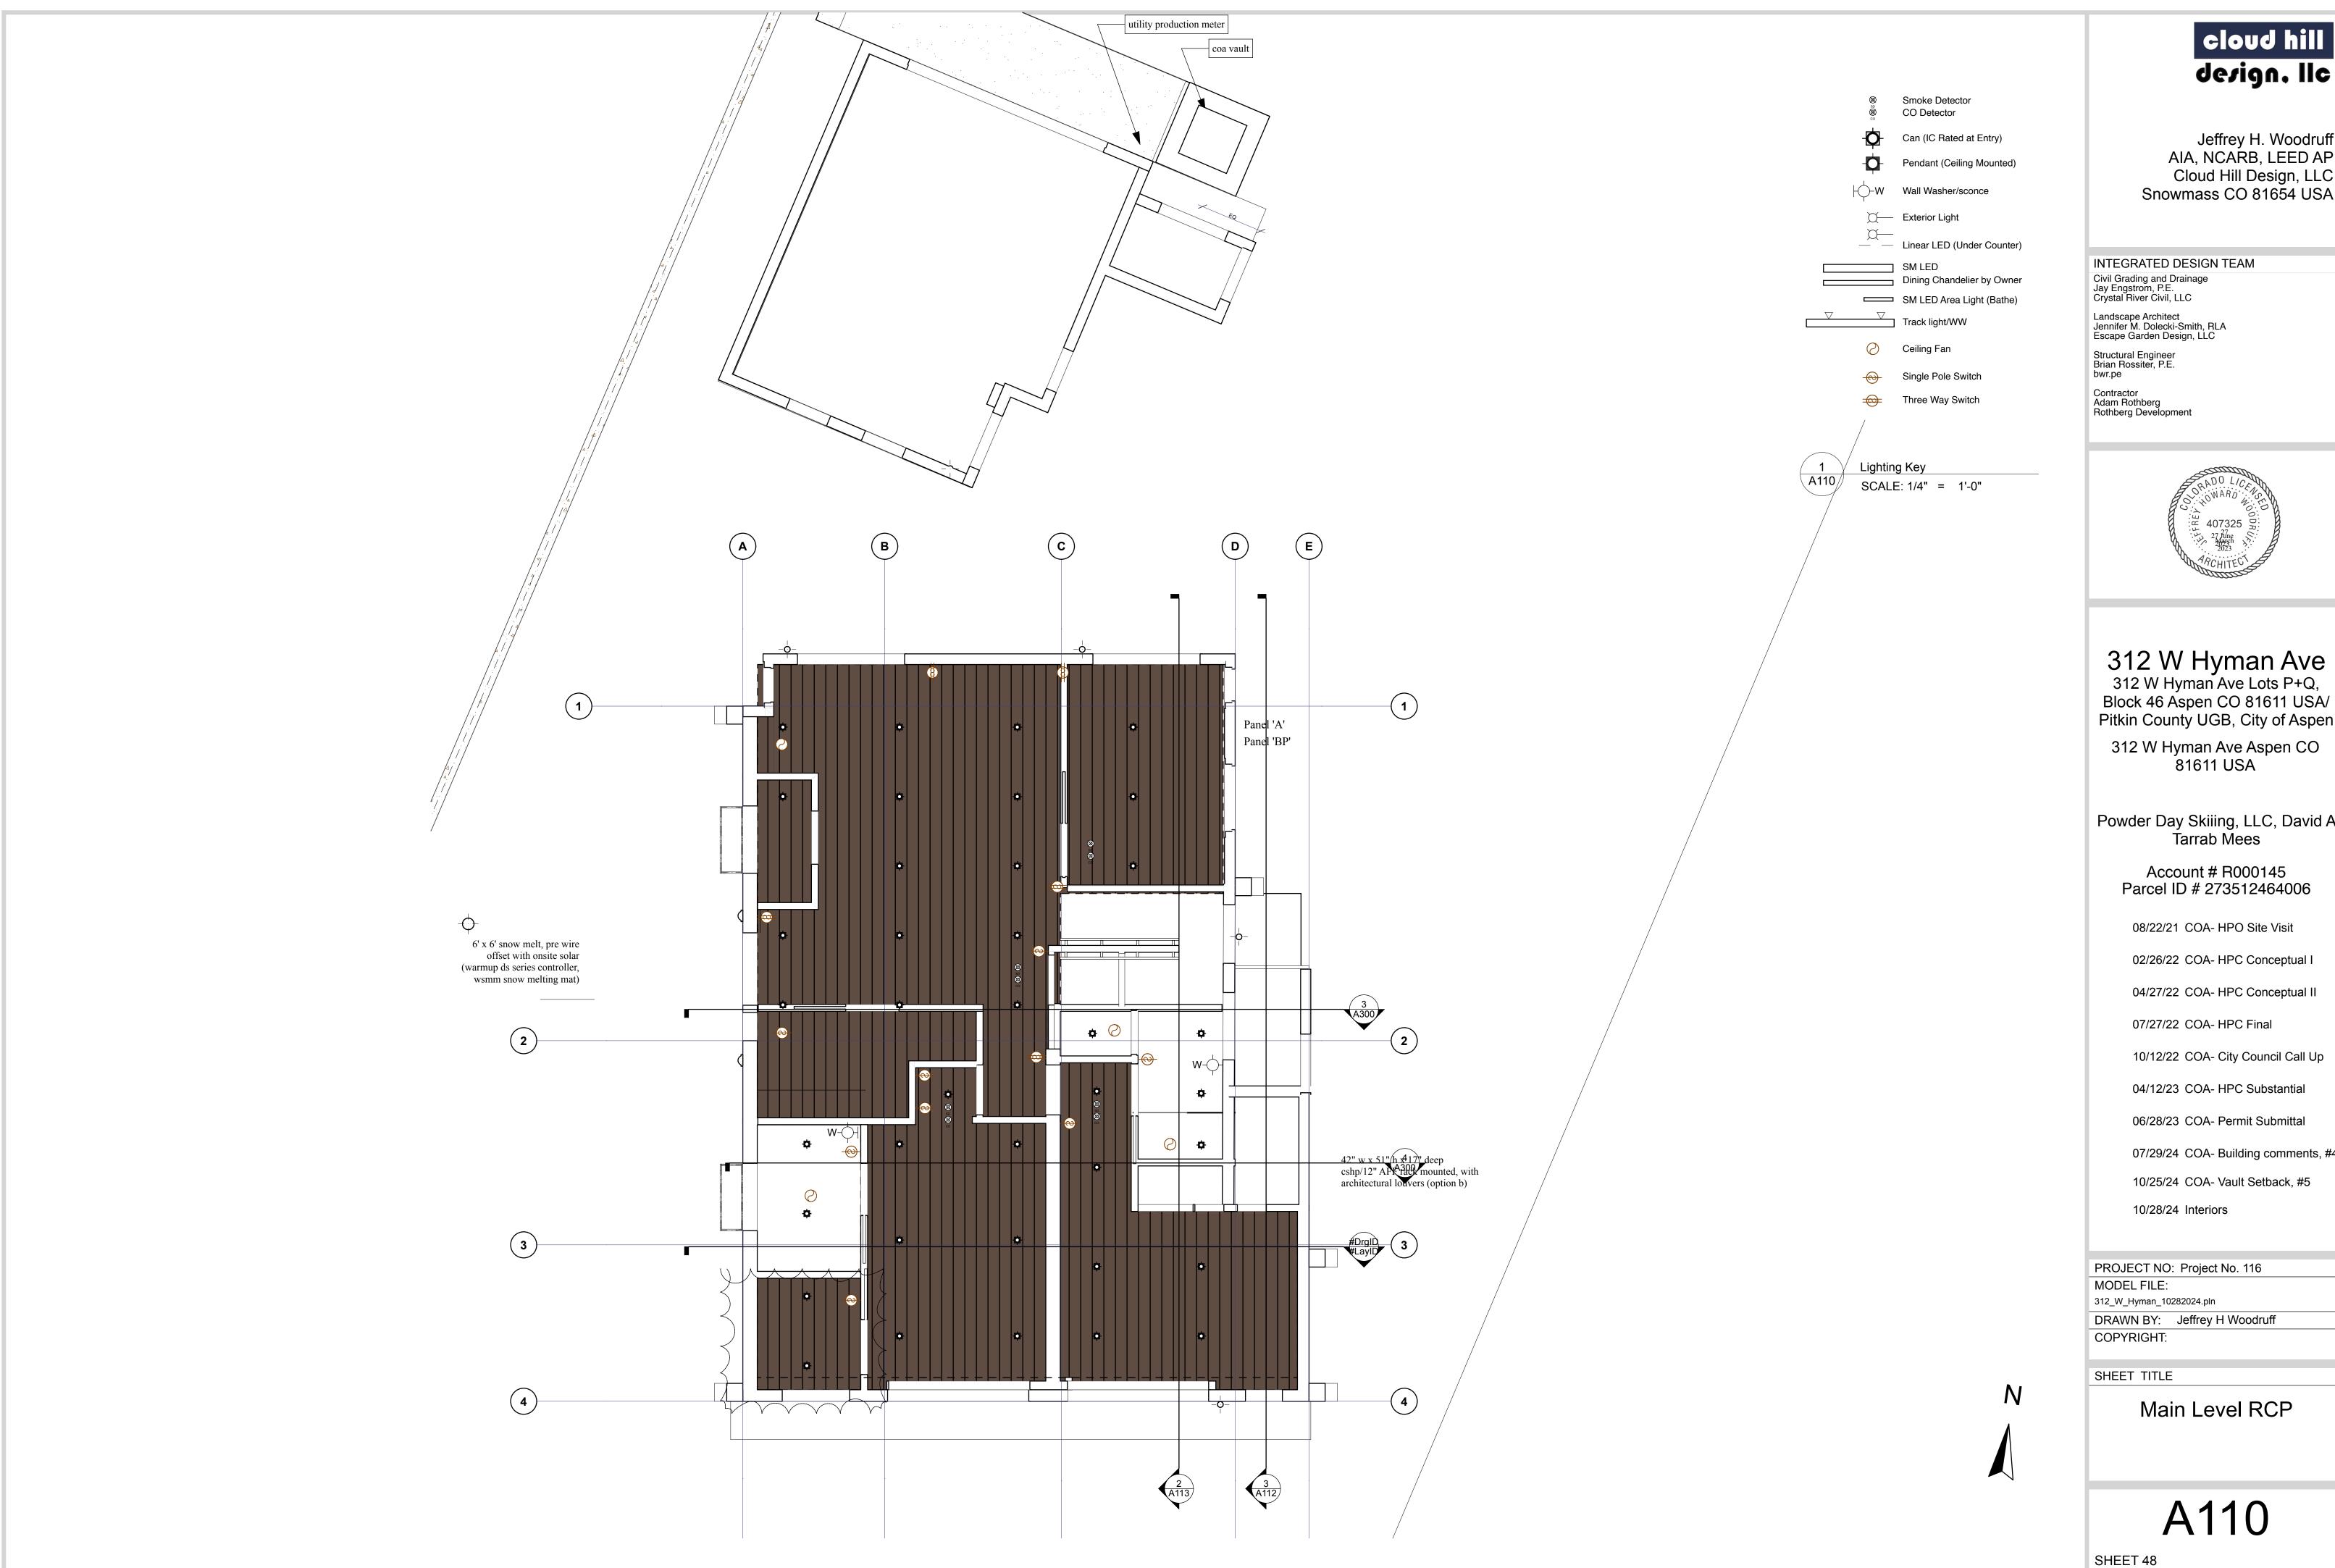
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Roof Plan Existing

A108











Block 46 Aspen CO 81611 USA/ Pitkin County UGB, City of Aspen

312 W Hyman Ave Aspen CO

Powder Day Skiiing, LLC, David A

Account # R000145 Parcel ID # 273512464006

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2 First Floor RCP SCALF: 1/4" = 1'-0"



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bwr.pe

Contractor Adam Rothberg Rothberg Development

Smoke Detector CO Detector

-W Wall Washer/sconce

C Exterior Light

SM LED

Track light/WW

Lighting Key

Ceiling Fan

Three Way Switch

SCALE: 1/4" = 1'-0"

Can (IC Rated at Entry)

Linear LED (Under Counter)

_____ Dining Chandelier by Owner

SM LED Area Light (Bathe)

Single Pole Switch

Pendant (Ceiling Mounted)



312 W Hyman Ave 312 W Hyman Ave Lots P+Q,

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SHEET TITLE

Second Level RCP

A111

SHEET 49

N

2 Second Floor RCP A111 SCALE: 1/4" = 1'-0"

WOOD SIDING, T&G, ASTM E119 STRUCTURAL EXT PLY, DENSGLASS POSTS, AS PER STRUCT STRUCTURAL EXT PLY, DENSGLASS WOOD SIDING, T&G, ASTM E119
TOTAL R-VALUE = NOT HEATED, EXTERIOR DECK

W12 (North Deck Exterior

30" DECK ASSEMBLY NORTH BEDROOM SCALE: 1" = 1'-0"


The existing stairs are moving 4'- 4" to the North, adjacent to door - D 1E.


1011.10 Handrails There is no change to the existing railing. A single 2 x 8" trek board. This matches the historic structure deck railing. As installed by the City of Aspen. 0112.2012.AGGR.

1011.2 Width and capacity: the tread width is 44" clear,


1011.55. the nosing is not less than 1/16"

1011.5.51 nosing projection is 1" beyond the tread below 1011.7 The stringer, no change in the existing structural stringers. The number of treads and risers are unchanged. The stairs are moving 4'-4" to the North to give more habitable space to the new bedroom in the South East corner of the residence.

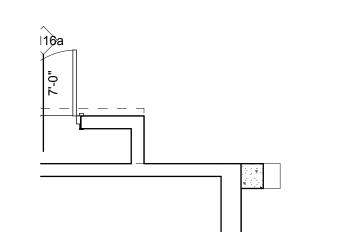

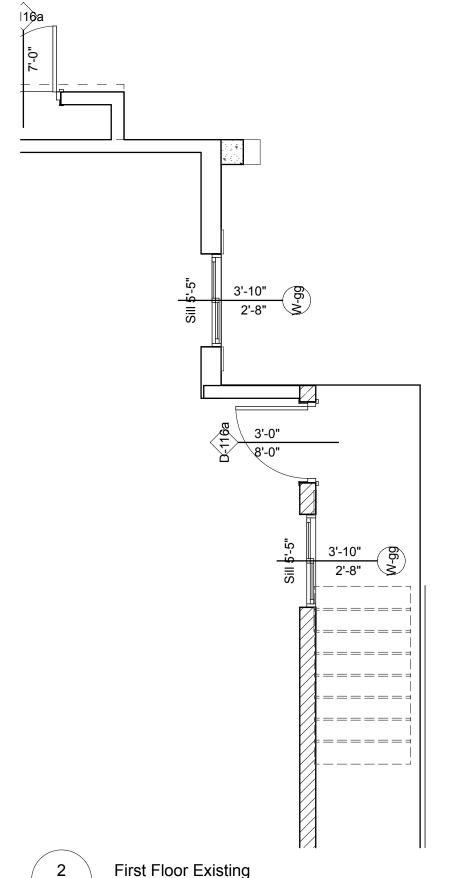

SCALE: 1/4" = 1'-0"

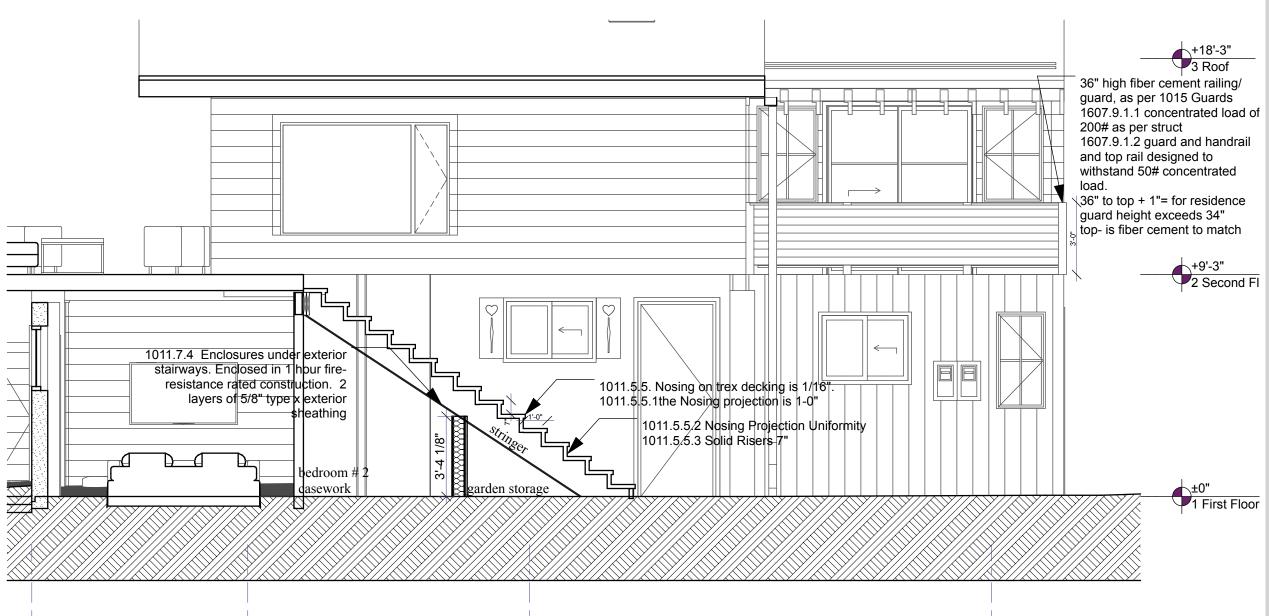

The stairs are moving 4'- 4" to the North, adjacent to door - D

1011.10 Handrails There is no change to the existing railing. A single 2" x 8" trek board. This matches the historic structure deck railing. As installed by the City of Aspen.


0112.2012.AGGR.

1011.2 Width and capacity: the tread width is 44" clear,

1011.55. the nosing is not less than 1/16"

1011.5.51 nosing projection is 1" beyond the tread below

1011.7 The stringer, no change in the existing structural stringers. The number of treads and risers are unchanged. The stairs are moving 4'-4" to the North to give more habitable space to the new bedroom in the South East corner of the residence.

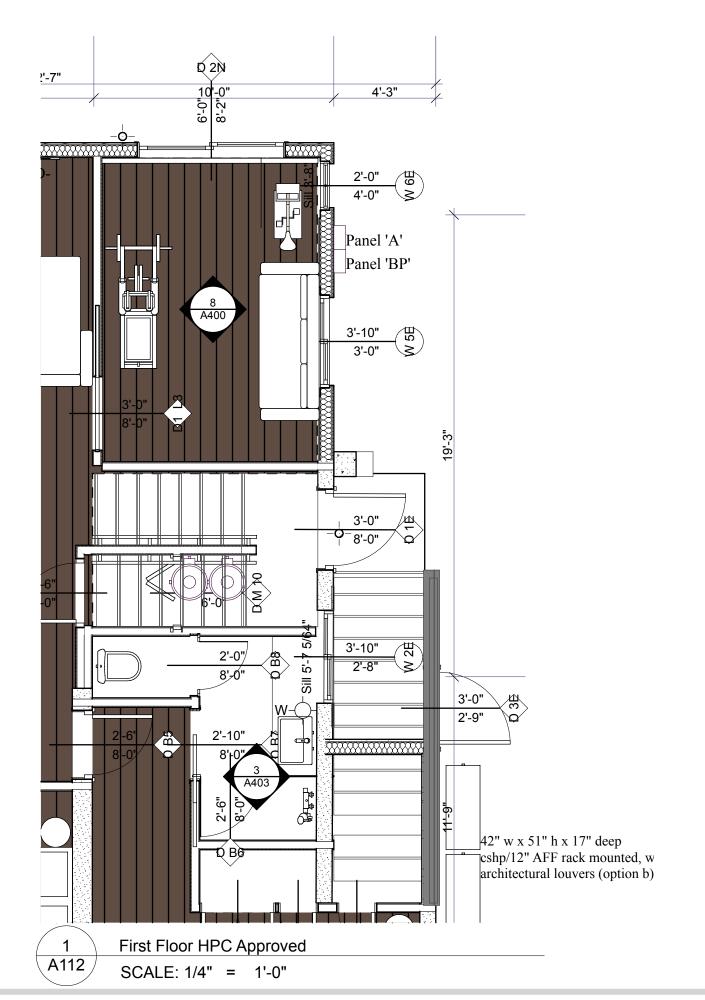



Jeffrey H. Woodruff AIA, NCARB, LEED AP Cloud Hill Design, LLC Snowmass CO 81654 USA

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Contractor Adam Rothberg Rothberg Development



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Parcel ID # 273512464006

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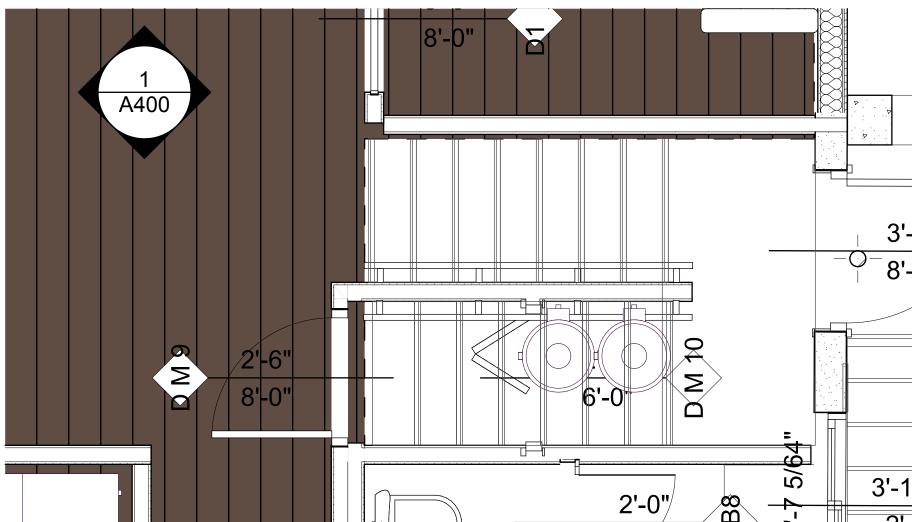
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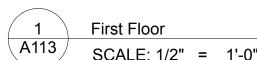
Exterior Stairways Enlarged

A112

East side of landing is drywall- the East existing door is not visible from the interior of the stairwell. The door is visible from the exterior into the mechanical.

1011.7 Stairway construction Wood handrails with leather stitched wrap handrail





1011.1 General 1011.5.5 Nosing curvature of 1/16" 1011.5.5.1 Nosing Projection Size .5" Nosing projection
1011.5.4 Dimensional Uniformity Risers vertical, 7" Treads 11" 1011.3 Headroom not less than 80" maintained, see section, 8'-3" > 80"

3'-0"

Stairs- Enclosed in 1 hour fire-resistance rated construction.

2 layers of 5/8" type x sheathing.

Section at new interior stairs

SCALE: 1/2" = 1'-0"


Two layers below stringer in mechanical



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INTEGRATED DESIGN TEAM



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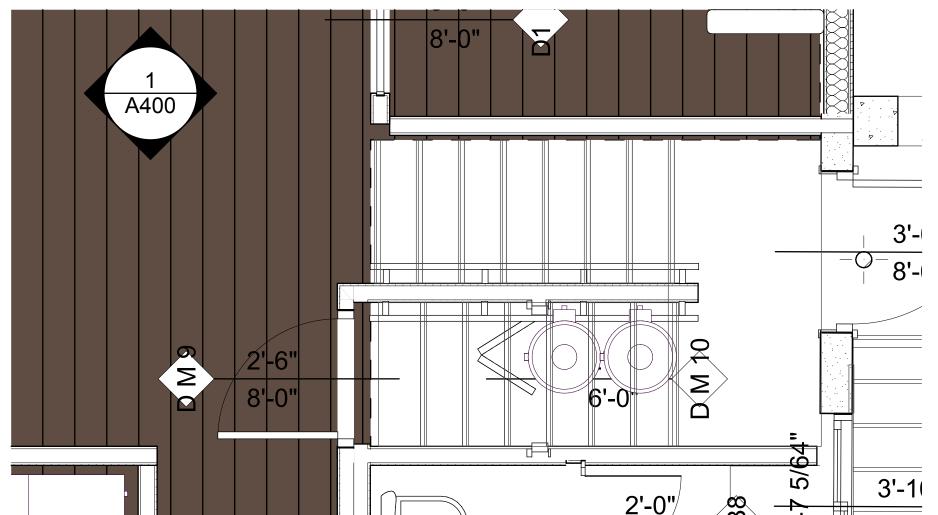
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SHEET TITLE

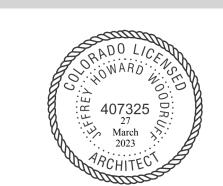Interior Stairs Enlarged

A113





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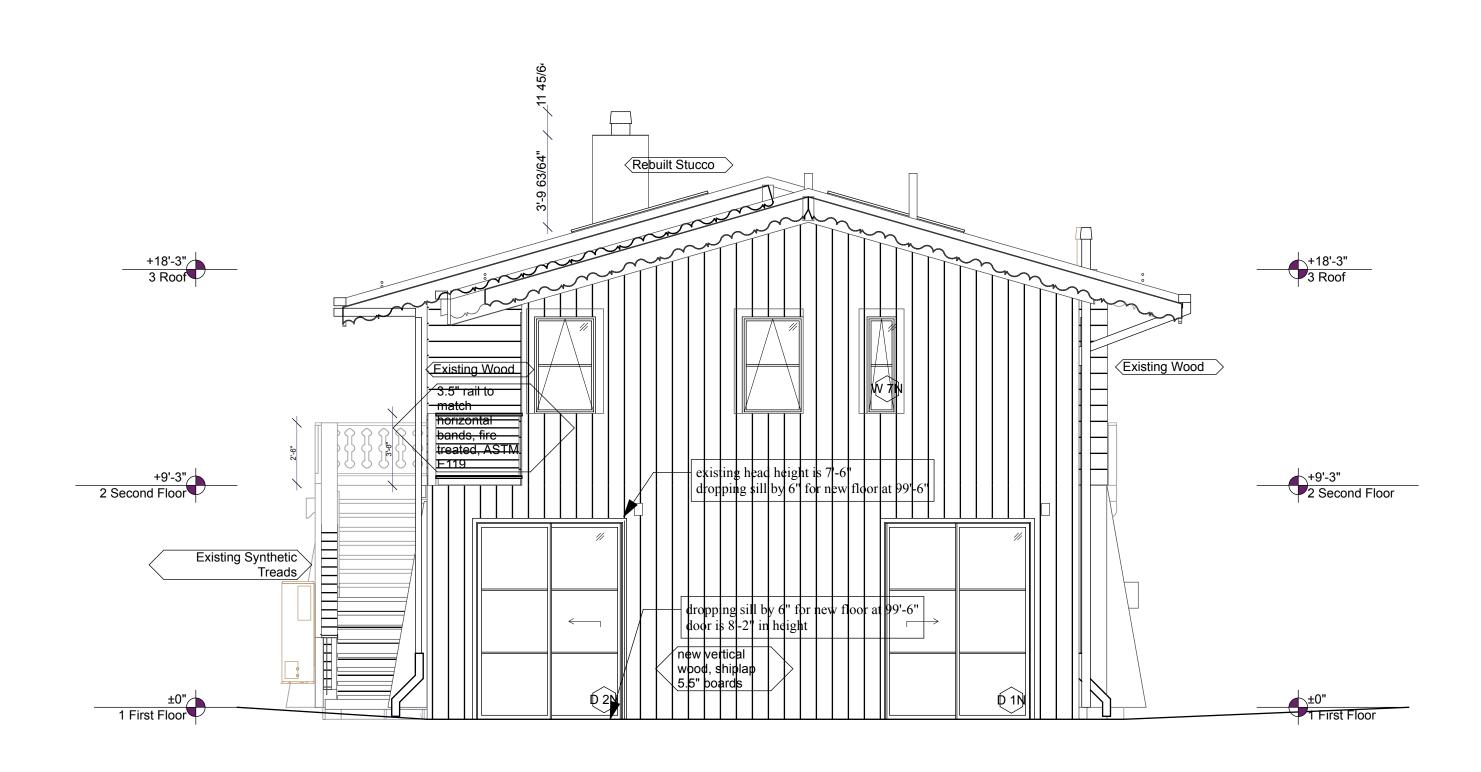
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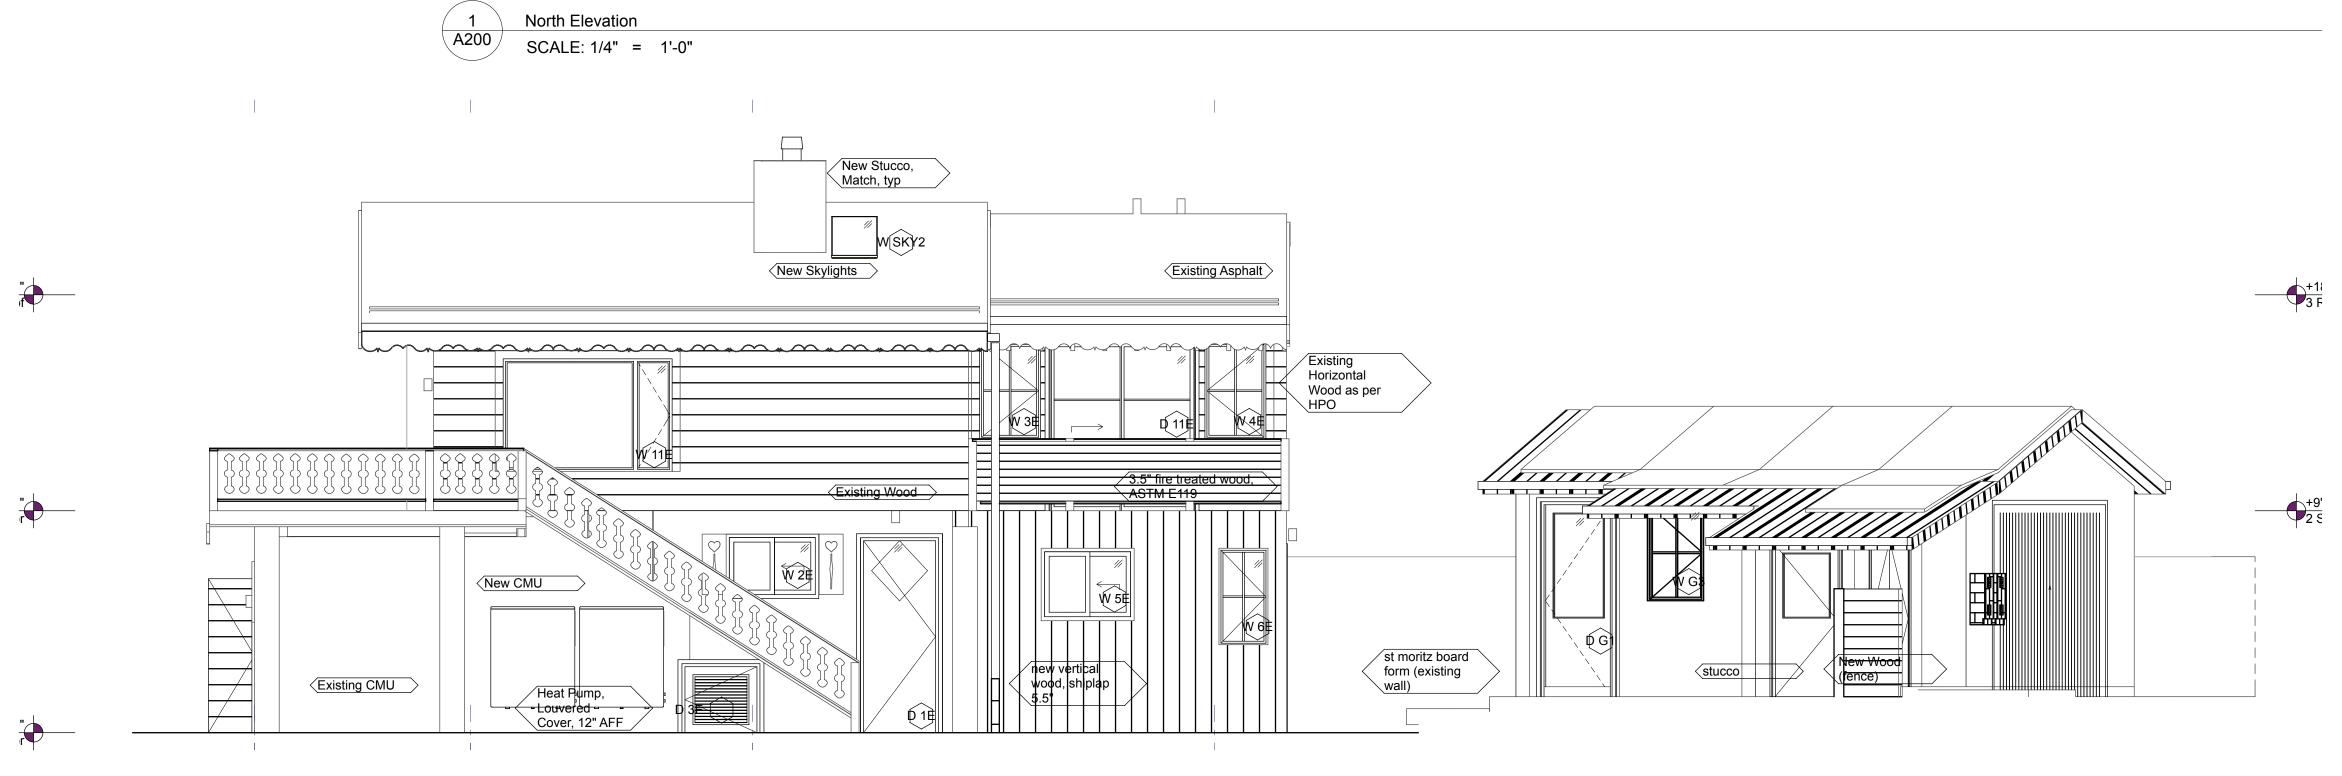
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Elevations Proposed

A200

SHEET 52





East Elevation

SCALE: 1/4" = 1'-0"

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Civil Grading and Drainage
Jay Engstrom, P.E.
Crystal River Civil, LLC

Landscape Architect
Jennifer M. Dolecki-Smith, RLA
Escape Garden Design, LLC

Jennifer M. Dolecki-Smith, R Escape Garden Design, LLC Structural Engineer Brian Rossiter, P.E. bwr.pe

Contractor Adam Rothberg Rothberg Development



312 W Hyman Ave Lots Rt O

312 W Hyman Ave Lots P+Q, Block 46 Aspen CO 81611 USA/ Pitkin County UGB, City of Aspen

312 W Hyman Ave Aspen CO 81611 USA

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10/28/24 Interiors

PROJECT NO: Project No. 116

MODEL FILE:

312_W_Hyman_10282024.pln

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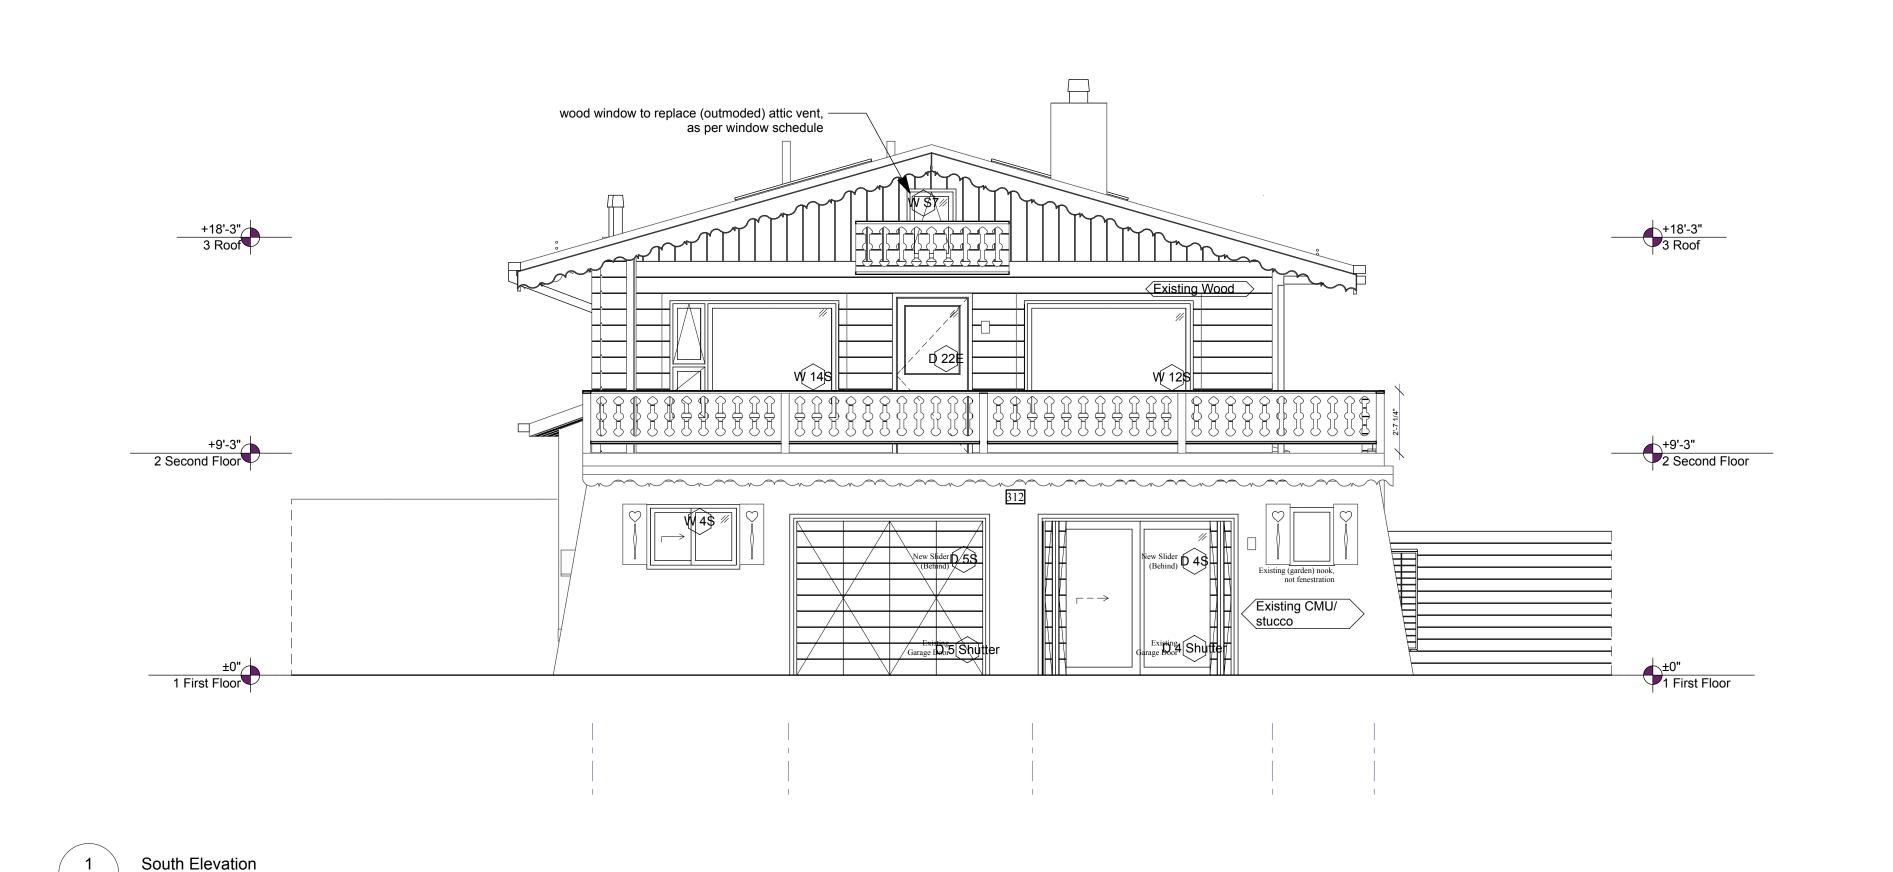
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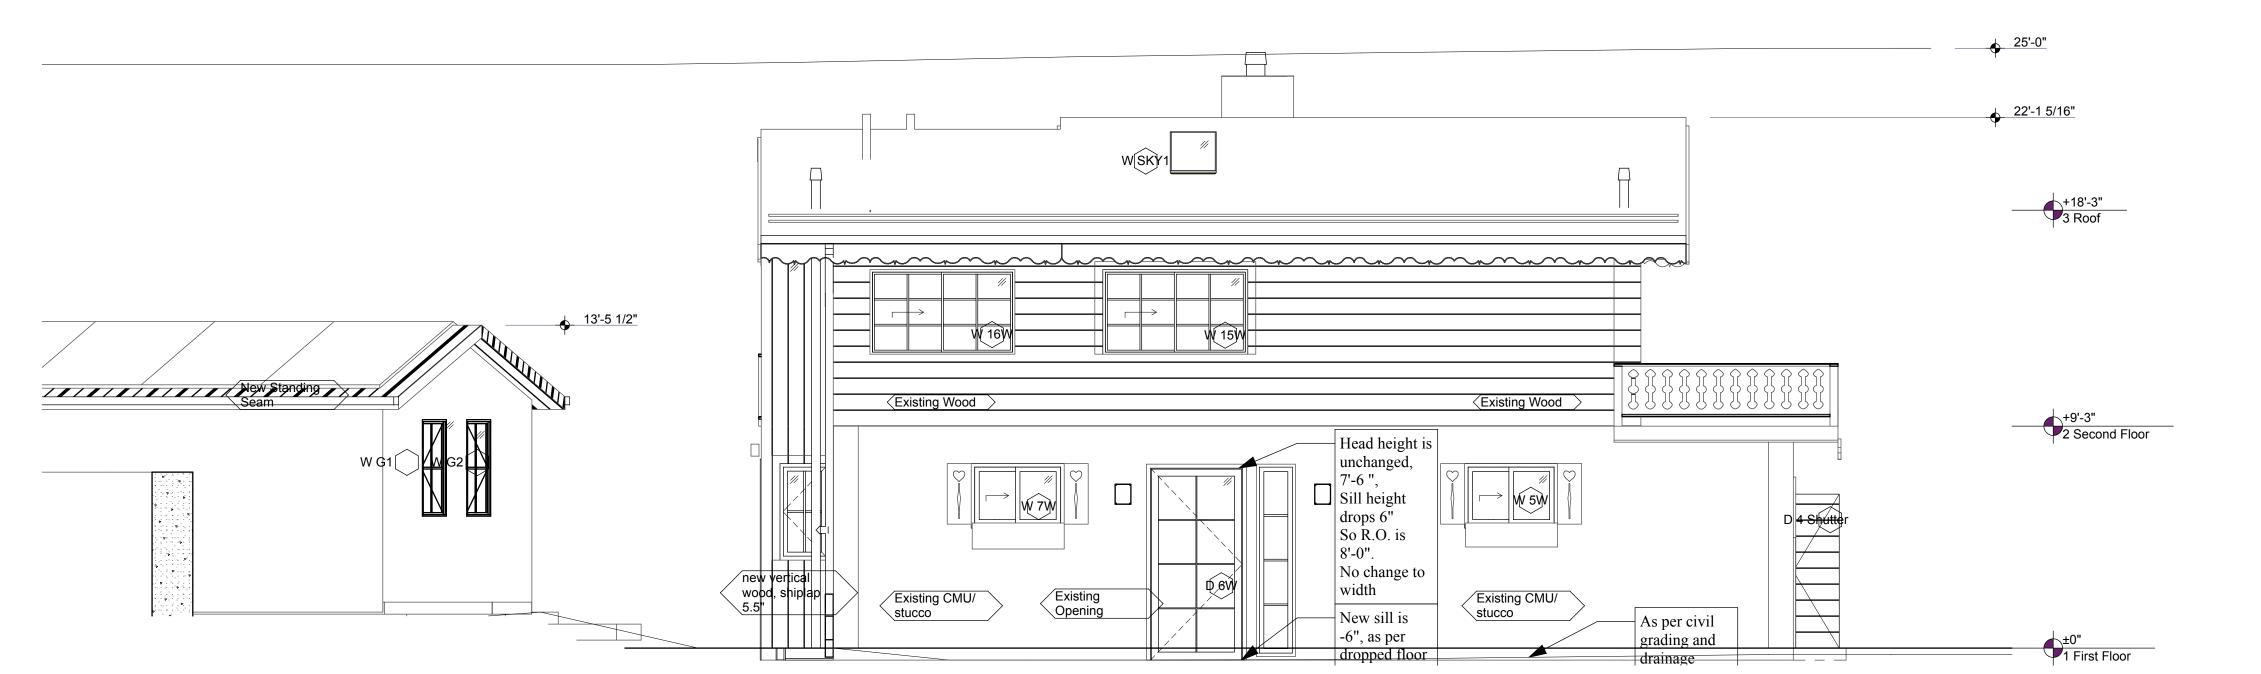
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Elevations Proposed

A201

SHEET 53





A201 SCALE: 1/4" = 1'-0"

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Landscape Architect Jennifer M. Dolecki-Smith, RLA Escape Garden Design, LLC

Structural Engineer Brian Rossiter, P.E. bwr.pe

Contractor Adam Rothberg Rothberg Development



312 W Hyman Ave 312 W Hyman Ave Lots P+Q, Block 46 Aspen CO 81611 USA/ Pitkin County UGB, City of Aspen

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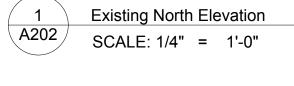
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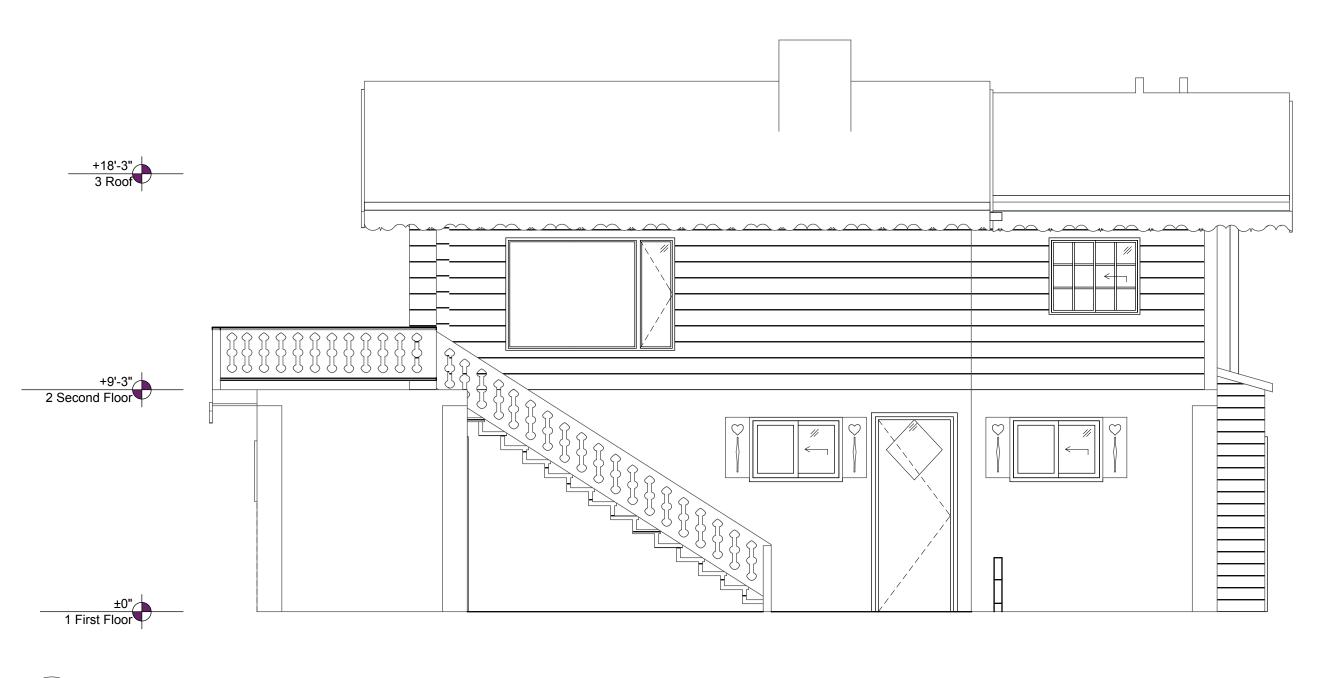
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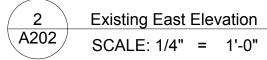
Existing Elevations

A202









SCALE: 1/4" = 1'-0"



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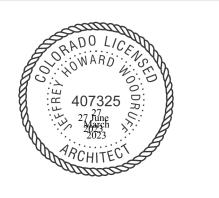
INTEGRATED DESIGN TEAM

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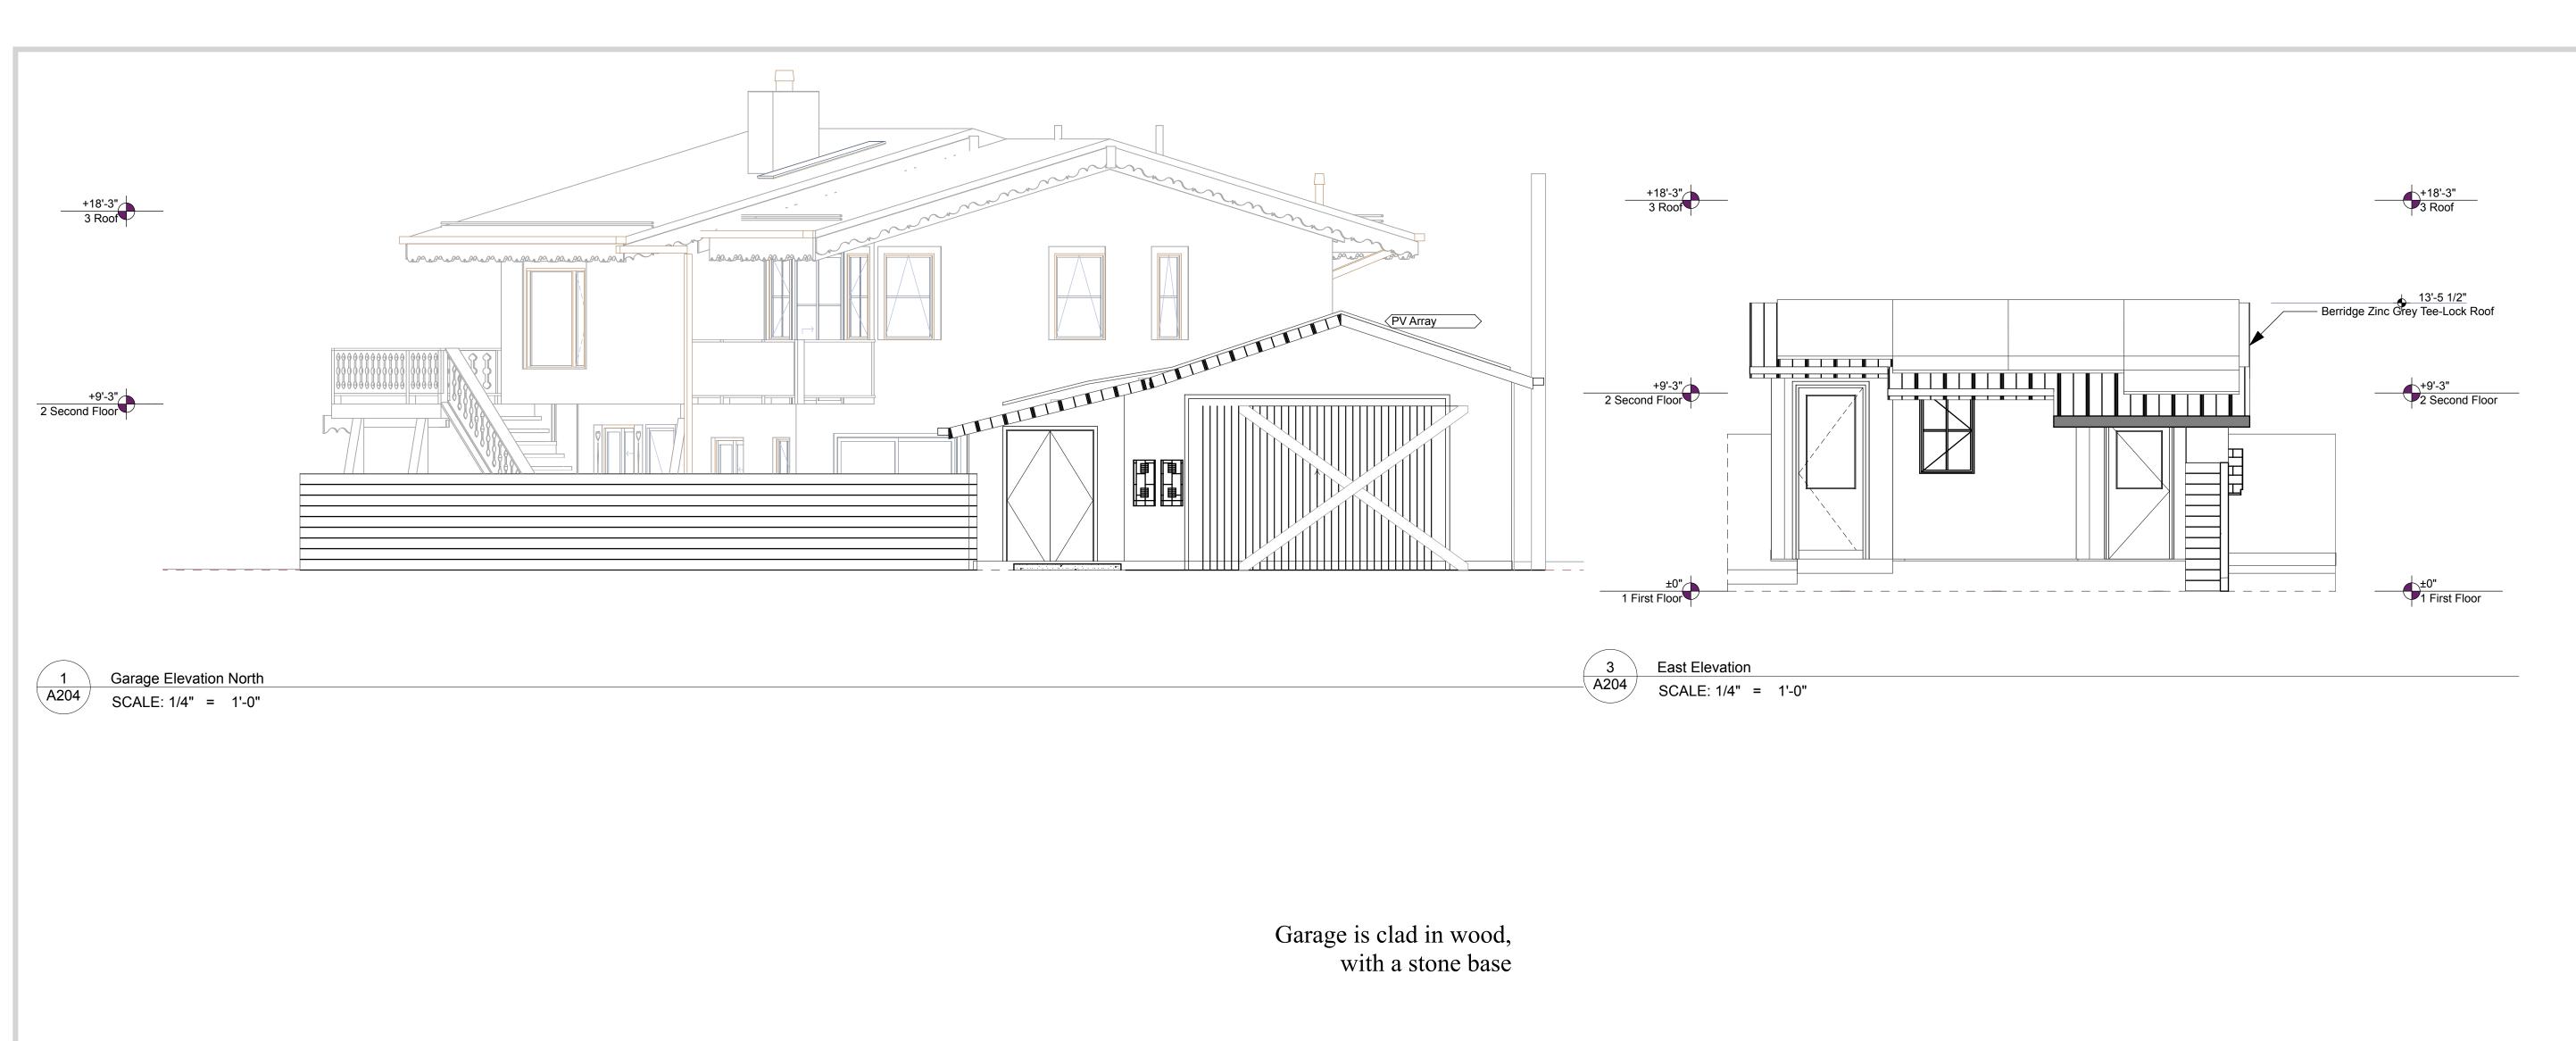
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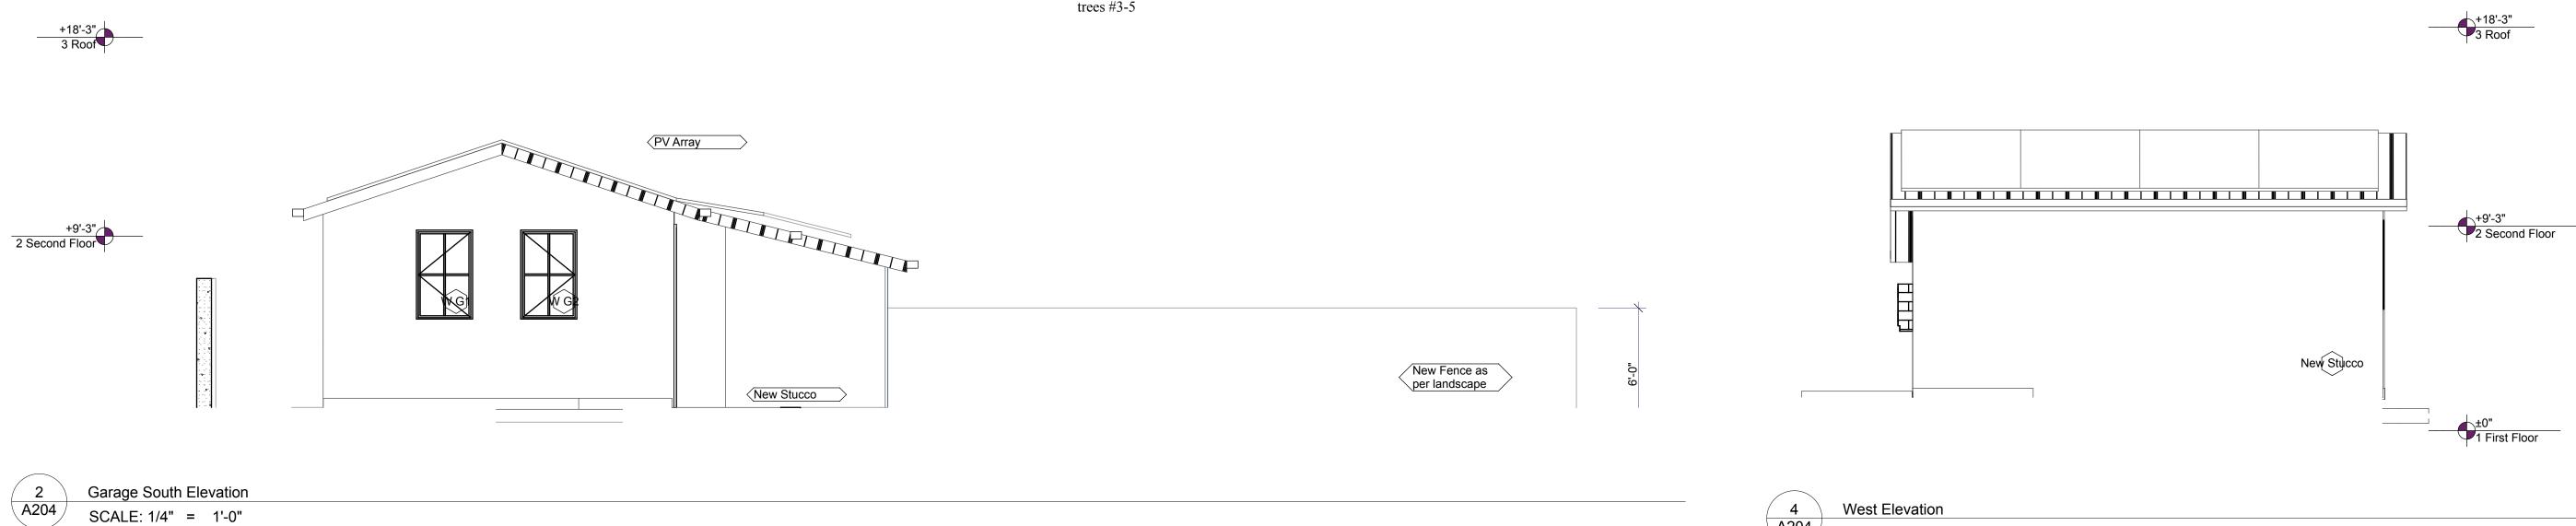
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Existing Elevations

A203





West Elevation

cloud hill design, llc

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Contractor Adam Rothberg Rothberg Development



312 W Hyman Ave Lots P+Q, Block 46 Aspen CO 81611 USA/ Pitkin County UGB, City of Aspen

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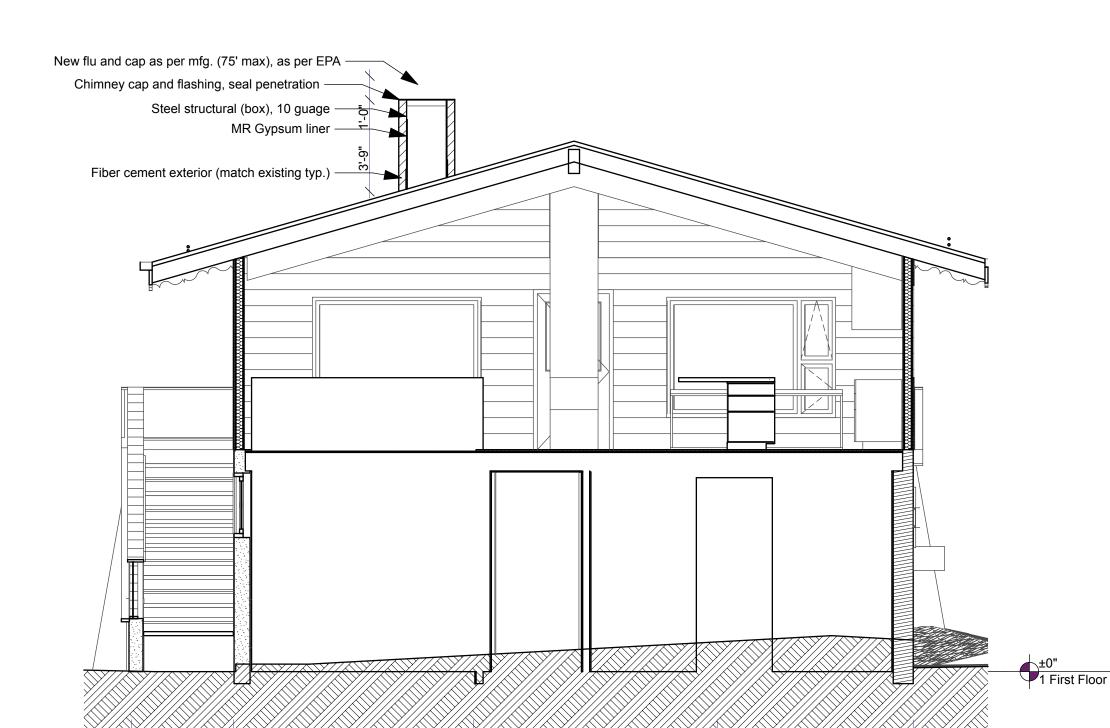
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SHEET TITLE

Garage Elevations

A204



C

transverse at chimney (new) SCALE: 1/4" = 1'-0"

transverse at Bedroom #2 SCALE: 1/4" = 1'-0"


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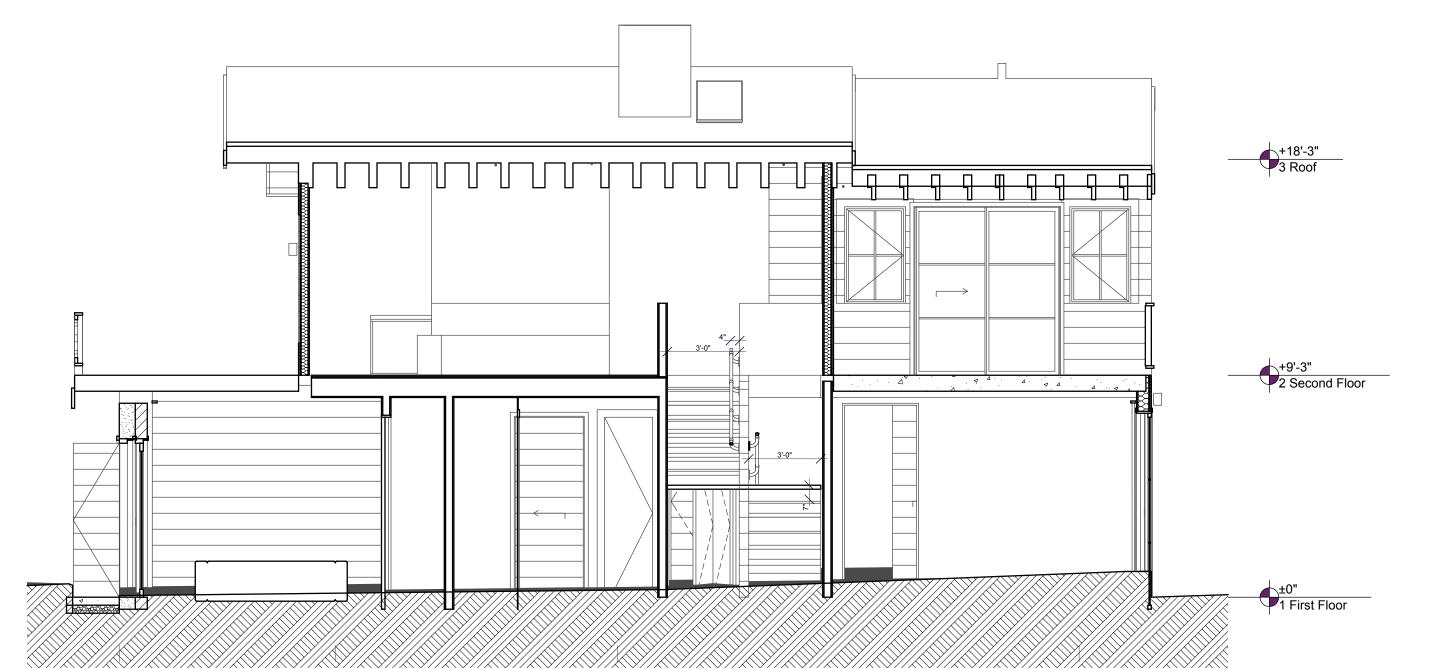
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longitudinal at Bedroom #2 and Garden Storage SCALE: 1/4" = 1'-0"

A300





Longitudinal at Stairs SCALE: 1/4" = 1'-0"

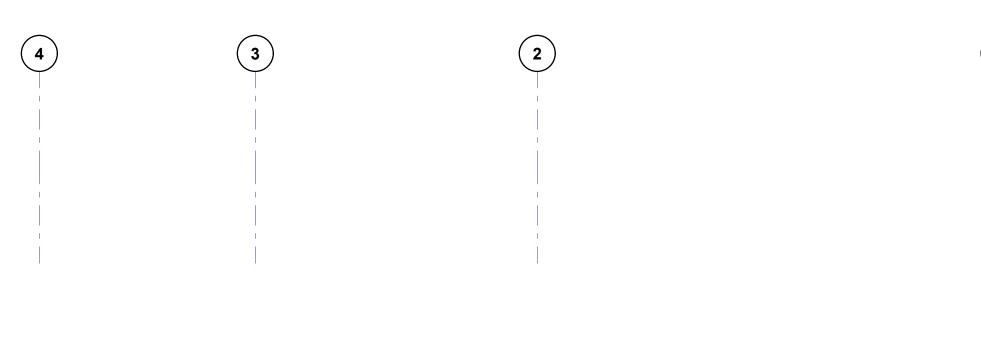


Jeffrey H. Woodruff AIA, NCARB, LEED AP Cloud Hill Design, LLC Snowmass CO 81654 USA

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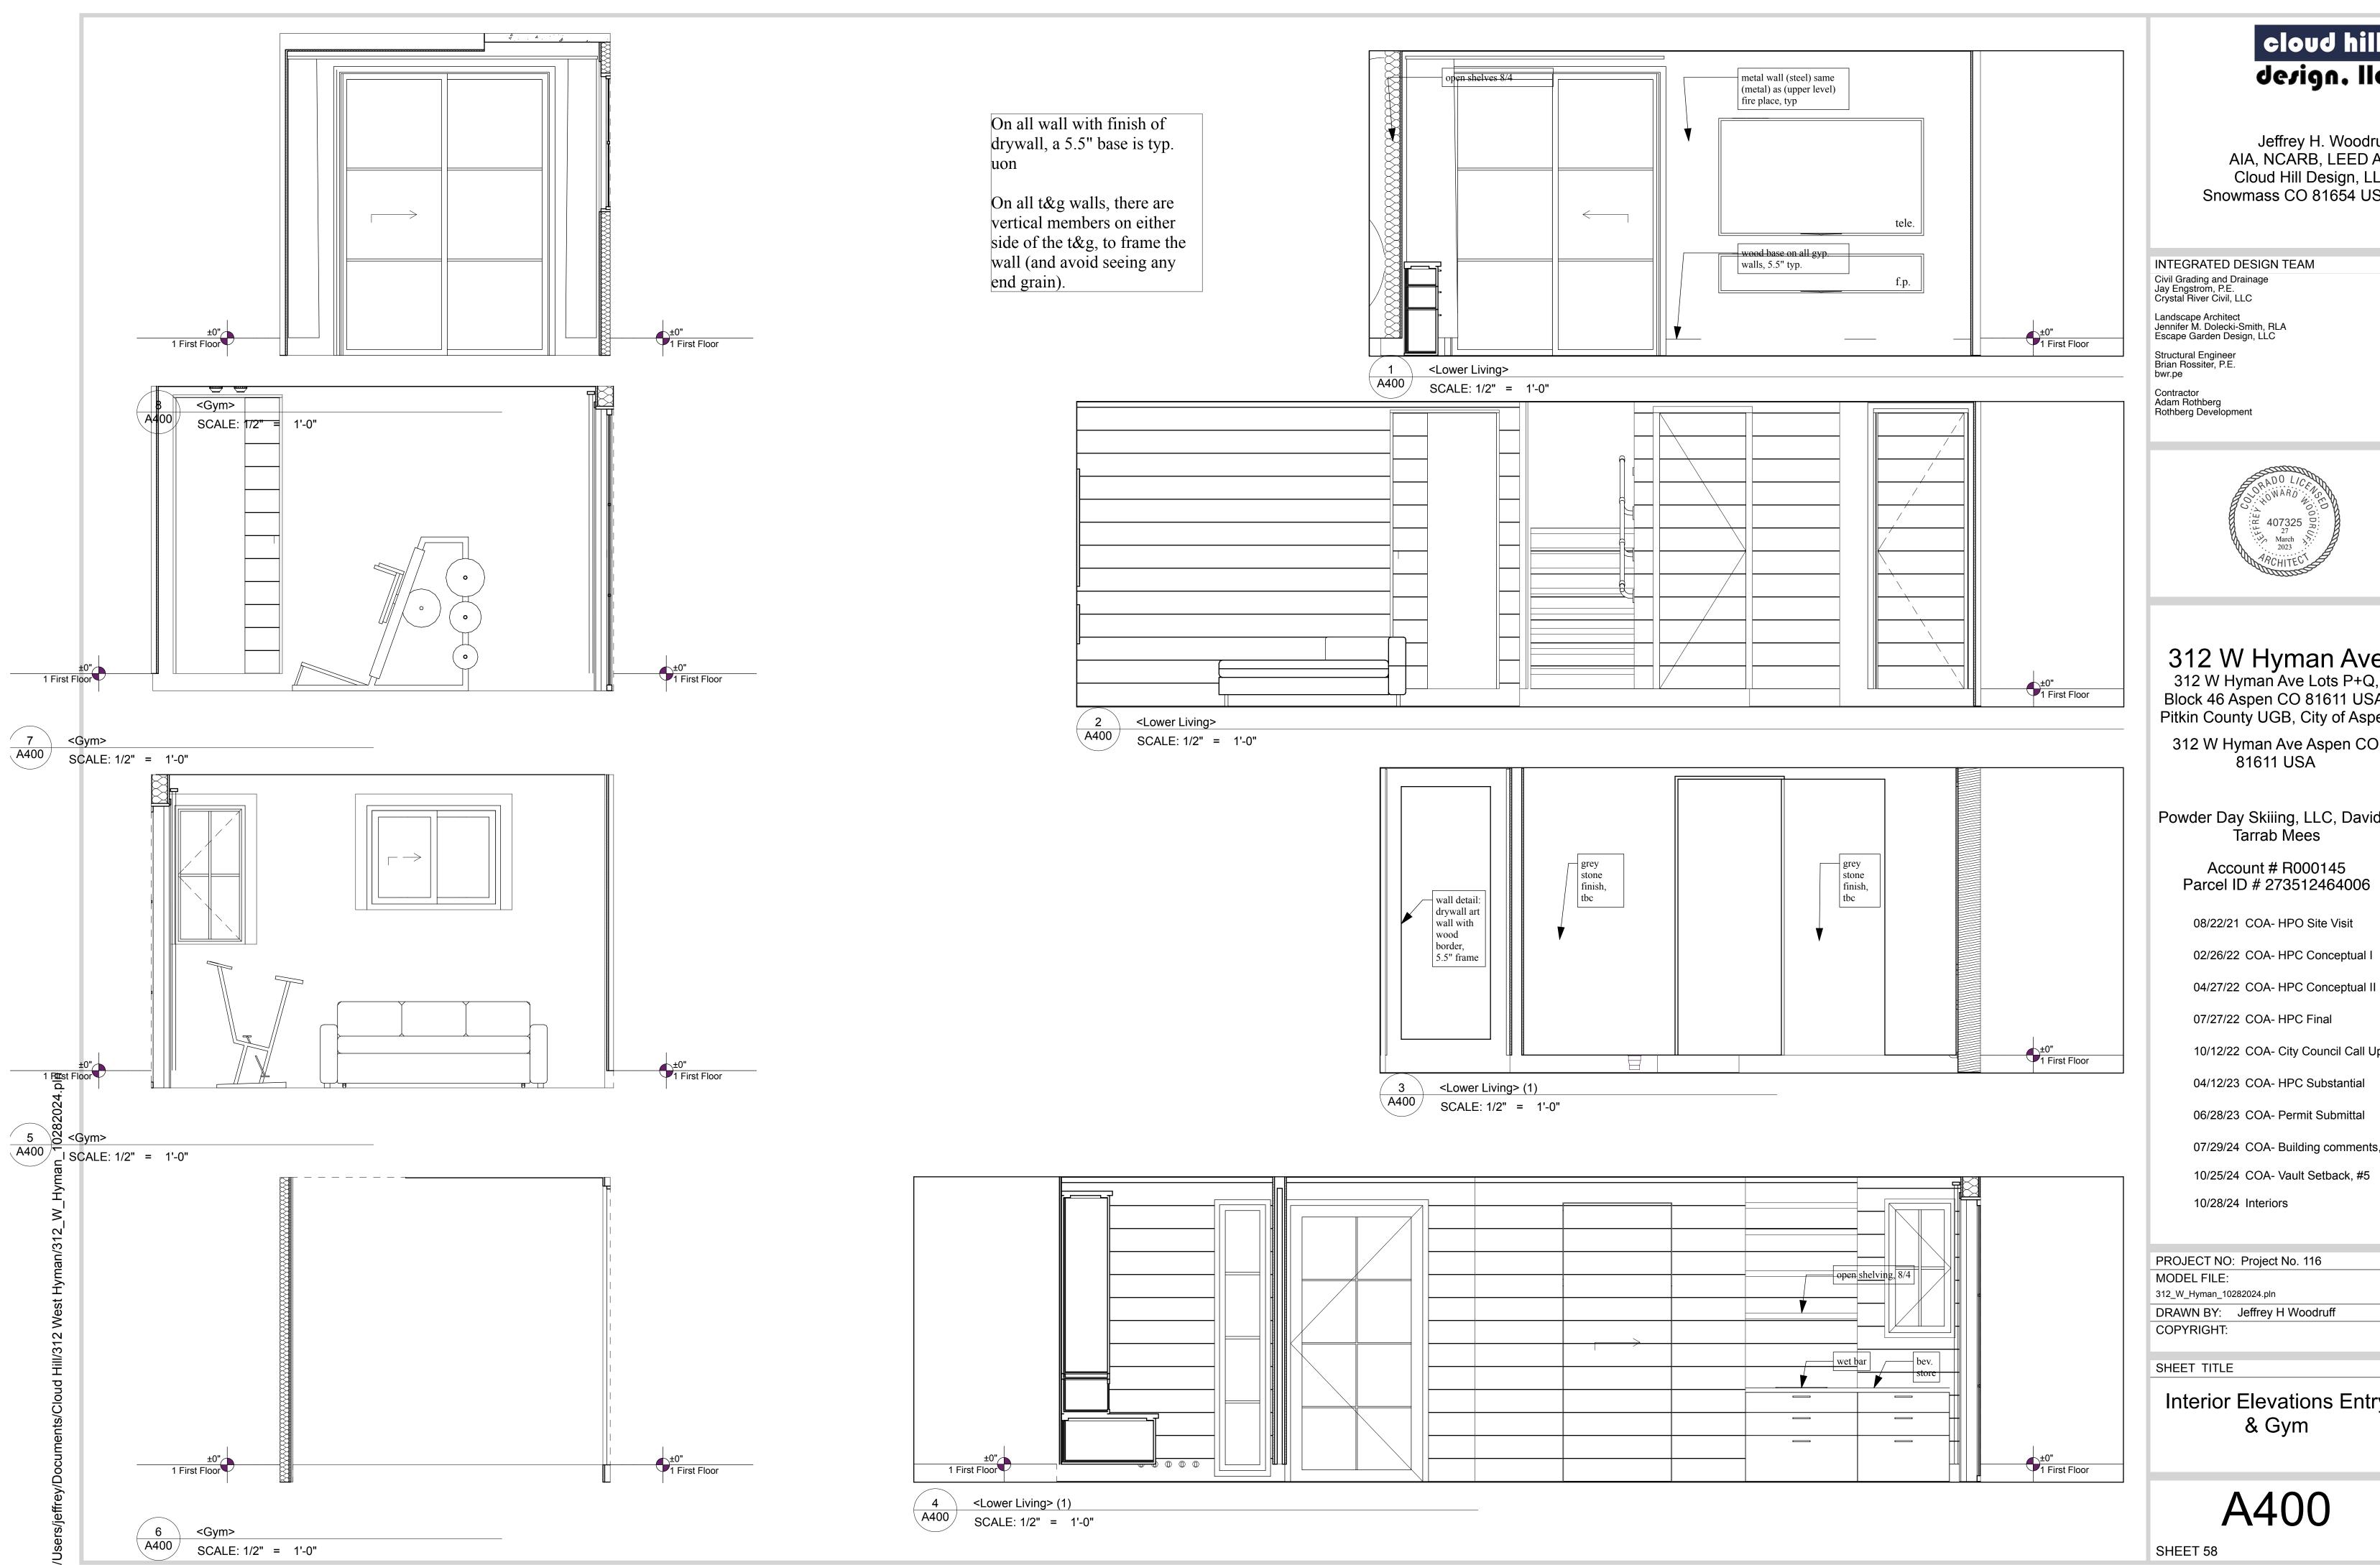
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Building Sections


A300



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Interior Elevations Entry & Gym

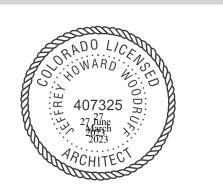A400

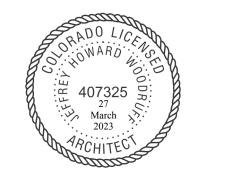

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Interior Elevations 1/2 & Mud

A401



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10/25/24 COA- Vault Setback, #5

10/28/24 Interiors

PROJECT NO: Project No. 116 MODEL FILE: 312_W_Hyman_10282024.pln DRAWN BY: Jeffrey H Woodruff COPYRIGHT:

SHEET TITLE

Interior Elevations Bedroom #2 Bathe #2

A402




Jeffrey H. Woodruff AIA, NCARB, LEED AP Cloud Hill Design, LLC Snowmass CO 81654 USA

INTEGRATED DESIGN TEAM Civil Grading and Drainage Jay Engstrom, P.E. Crystal River Civil, LLC

Landscape Architect Jennifer M. Dolecki-Smith, RLA Escape Garden Design, LLC Structural Engineer Brian Rossiter, P.E. bwr.pe

Contractor Adam Rothberg Rothberg Development

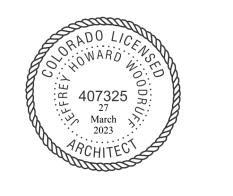

312 W Hyman Ave 312 W Hyman Ave Lots P+Q, Block 46 Aspen CO 81611 USA/ Pitkin County UGB, City of Aspen

312 W Hyman Ave Aspen CO 81611 USA

Powder Day Skiiing, LLC, David A Tarrab Mees

Account # R000145 Parcel ID # 273512464006

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02/26/22 COA- HPC Conceptual I

04/27/22 COA- HPC Conceptual II

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PROJECT NO: Project No. 116 MODEL FILE: 312_W_Hyman_10282024.pln

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SHEET TITLE

Bedroom #3

A403

<bedroom #1>

SCALE: 1/2" = 1'-0"




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PROJECT NO: Project No. 116 MODEL FILE:

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SHEET TITLE

Bedroom #1

A404

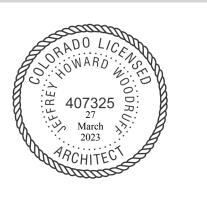


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Bedroom # 1 Bathe #1

A405

SCALE: 1/2" = 1'-0"

SCALE: 1/2" = 1'-0"

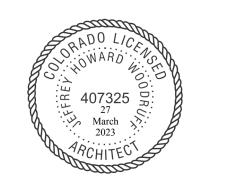

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Interior Elevations Kitchen/Dining

A406



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SHEET TITLE

Interior Elevations Living

A407




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SHEET TITLE

Interior Elevations Storage

A408

1 A500 Window Legend

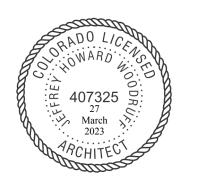SCALE: 1' = 1'-0"

Fixed	Fixed	Fixed	Fixed	Sliding	Sliding	Sliding	Undefined	Undefined	Undefined
6'-0"×3'-6"	7'-0"×4'-8"	7'-0"×5'-0"	7'-0"×5'-0"	3'-10"×2'-8"	3'-10"×3'-0"	6'-0"×3'-6"	2'-0"×3'-0"	2'-1"×2'-8"	2'-6"×4'-0"
Existing	Existing	Existing	Existing: installing dou	Existing: installing dou	NEW Loewen, Al Clad	Existing: installing dou	NEW Loewen, Awning	Existing: wall nook, not	NEW Loewen, Al Clad,

3 A500

Window Legend

SCALE: 1' = 1'-0"

								WINDO	W SCHEDULE				
WOC	NUMBER		WIDO\	W SIZE									
M	ID	ROOM NAME	NOMINAL WIDTH	NOMINAL HEIGHT	TYPE	HEAD DETAIL	JAMB DETAIL	SILL DETAIL	ACCESORIES	U-VALUE	E TEMPERED	REMARKS	
	Nook		2'-1"	2'-8"	Undefined	A600	A600	A600		Nook	N/A		Existing: wall nook, not a window
	W 2E		3'-10"	2'-8"	Sliding	A600	A600	A600		Loå2 -272	.25	\boxtimes	Existing: installing double pane glass of the thinnest dimension, with a dark spacer
	W 3E		2'-6"	4'-0"	Casement	A600	A600	A600		E272/I89	.27	\boxtimes	NEW Loewen, Al Clad
	W 4E		2'-6"	4'-0"	Casement	A600	A600	A600		E272/I89	.27	\boxtimes	NEW Loewen, Al Clad
	W 4S		3'-10"	2'-8"	Sliding	A600	A600	A600		Loå2 -272	.25	\boxtimes	Existing: installing double pane glass of the thinnest dimension, with a dark spacer
	W 5E		3'-10"	3'-0"	Sliding	A600	A600	A600		Loå2 -272	.25	\boxtimes	NEW Loewen, Al Clad
	W 5W		3'-10"	2'-8"	Sliding	A600	A600	A600		Loå2 -272	.25	\boxtimes	Existing: installing double pane glass of the thinnest dimension, with a dark spacer
	W 6E		2'-0"	4'-0"	Casement	A600	A600	A600		E272/I89	.27	\boxtimes	NEW Loewen, Al Clad
	W 6W		1'-7"	8'-0"	Fixed	A600	A600	A600		E272/I89	.27	\boxtimes	NEW Loewen, Al Clad
	W 7N		1'-2"	4'-0"	Casement	A600	A600	A600		E272/I89	.27	\boxtimes	NEW Loewen, Al Clad
	W 7W		3'-10"	2'-8"	Sliding	A600	A600	A600		Loå2 -272	.25	\boxtimes	Existing: installing double pane glass of the thinnest dimension, with a dark spacer
	W 8N		2'-6"	4'-0"	Undefined	A600	A600	A600		E272/I89	.27	\boxtimes	NEW Loewen, Al Clad, Awning
	W8W		2'-0"	4'-0"	Fixed	A600	A600	A600		E272/I89	.27	\boxtimes	NEW Loewen, Al Clad
	W 9N		2'-6"	4'-0"	Undefined	A600	A600	A600		E272/I89	.25	\boxtimes	NEW Loewen, Al Clad, Awning
	W 11E		7'-0"	4'-8"	Casement	A600	A600	A600		Loå2 -272	.25	\boxtimes	Existing: installing double pane glass of the thinnest dimension, with a dark spacer
	W 12S		7'-0"	5'-0"	Fixed	A600	A600	A600		Loå2 -272	.25	\boxtimes	Existing: installing double pane glass of the thinnest dimension, with a dark spacer
	W 14S		7'-0"	5'-0"	Casement	A600	A600	A600		Loå2 -272	.25	\boxtimes	Existing: installing double pane glass of the thinnest dimension, with a dark spacer
	W 15W		6'-0"	3'-6"	Sliding	A600	A600	A600		Loå2 -272	.25	\boxtimes	Existing: installing double pane glass of the thinnest dimension, with a dark spacer
	W 16W		6'-0"	3'-6"	Sliding	A600	A600	A600		Loå2 -272	.25	\boxtimes	Existing: installing double pane glass of the thinnest dimension, with a dark spacer
	W G1		2'-6"	4'-0"	Casement	A600	A600	A600		E272/I89	.27	\boxtimes	NEW Loewen, Al Clad
	W G2		2'-6"	4'-0"	Casement	A600	A600	A600		E272/I89	.27		NEW Loewen, Al Clad
	W G3		2'-6"	4'-0"	Casement	A600	A600	A600		E272/I89	.27		NEW Loewen, Al Clad
	W S7		2'-0"	3'-0"	Undefined	A600	A600	A600		E272/I89	.25	\boxtimes	NEW Loewen, Awning (Carbon/Wood Clad), Window at former attic

Cardinal LoĒ-272 - (2) Calculations based on 3 mm (1/8") glass, 13 mm (1/2") airspace, 3 mm (1/8") glass

cloud hill design, llc

Jeffrey H. Woodruff AIA, NCARB, LEED AP Cloud Hill Design, LLC Snowmass CO 81654 USA

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INTEGRATED DESIGN TEAM

Contractor Adam Rothberg Rothberg Development



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Schedules


A500


SHEET 67

jeffrey/Documents/Cloud Hill/312 West Hyman/312_W_Hyman_102

Window Schedule

SCALE: 1' = 1'-0"

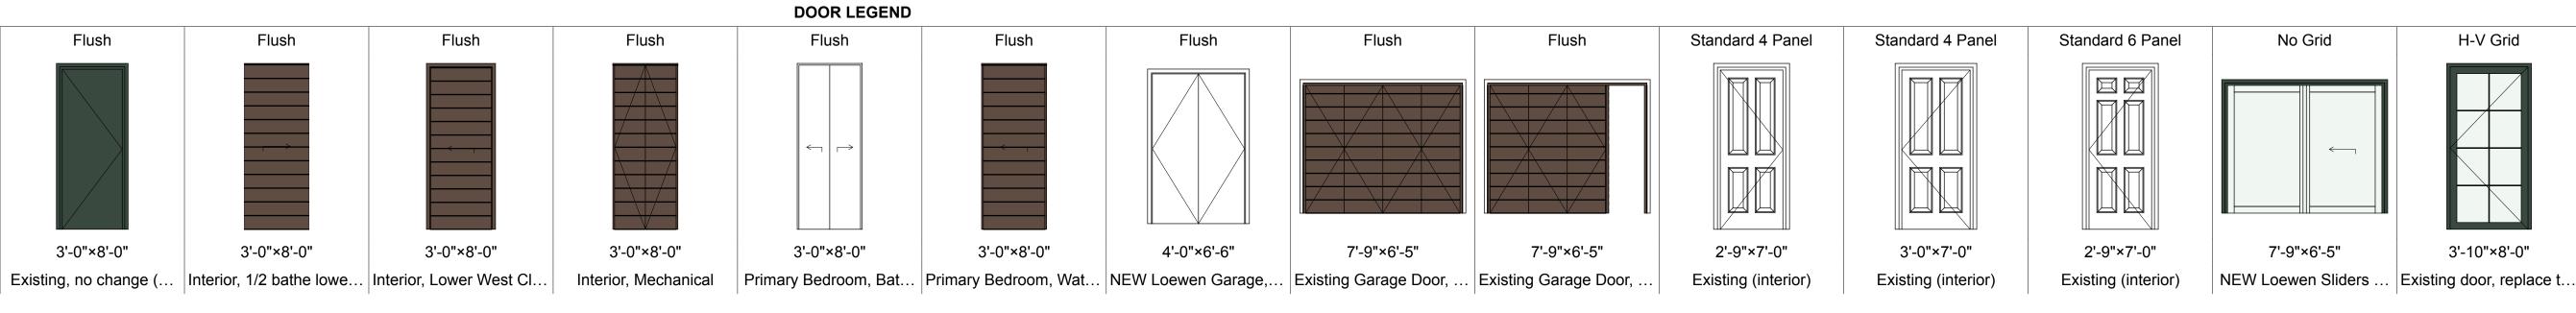

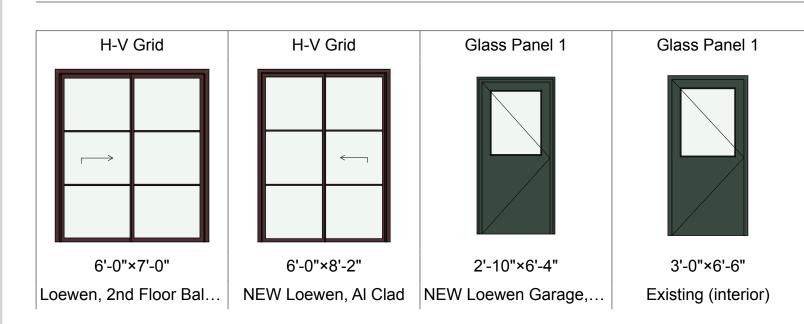

6 Door Legend A501 SCALE: 1' = 1'-0"

								DOOR SCH	IEDULE					
NUMBER				DOOR LEAF						HARD	RAT	INGS		
ID	ROOM NAME	NOMINAL WIDTH	NOMINAL HEIGHT	LEAF THICKNESS	MATERIAL	TYPE	HEAD DETAIL	JAMB DETAIL	SILL DETAIL	WARE ACCESORIES SET	FIRE	STC	REMARKS	
BR CL1		3'-0"	8'-0"	1 3/4"	SC WOOD		A600	A600	A600		1 hour		Interior, Mechanical	
BR CL2		1'-6"	8'-0"	1 3/4"	SC WOOD		A600	A600	A600		1 hour		Interior, Mechanical	
BR CL2		1'-6"	8'-0"	1 3/4"	SC WOOD		A600	A600	A600		1 hour		Interior, Mechanical	
D1 L1		3'-0"	8'-0"	1 3/4"	SC WOOD		A600	A600	A600		Non-Rated		Primary Bedroom, Water Closet	
D1 L2		3'-0"	8'-0"	1 3/4"	SC WOOD		A600	A600	A600		Non-Rated		Interior, 1/2 bathe lower level	
D1 L3		3'-0"	8'-0"	1 3/4"	SC WOOD		A600	A600	A600		Non-Rated		Primary Bedroom, Water Closet	
D 1E		3'-0"	8'-0"	1 3/4"	SC WOOD		A600	A600	A600		Non-Rated		Existing, no change (@ stairs)	
D 1N		6'-0"	8'-2"	1 3/4"	SC WOOD		A600	A600	A600		Non-Rated		NEW Loewen, Al Clad	
D 2N		6'-0"	8'-2"	1 3/4"	SC WOOD		A600	A600	A600		Non-Rated		NEW Loewen, Al Clad	
D 3E		3'-0"	2'-9"	1 3/4"	SC WOOD		A600	A600	A600		Non-Rated		Louvered stair door	
O 4 Shutter		7'-9"	6'-5"	1 3/4"	SC WOOD		A600	A600	A600		Non-Rated		Existing Garage Door, Cut to Make Bi-fold shutters, no locking HW (shutter)	
D 4S		7'-9"	6'-5"	1 3/4"	ALUM / GLASS		A600	A600	A600		Non-Rated		NEW Loewen Sliders at garage doors (sliders behind shutters at bedrooms)	
5 Shutter		7'-9"	6'-5"	1 3/4"	SC WOOD		A600	A600	A600		Non-Rated		Existing Garage Door, Cut to Make Bi-fold shutters, no locking HW (shutter)	
D 5S		7'-9"	6'-5"	1 3/4"	ALUM / GLASS		A600	A600	A600		Non-Rated		NEW Loewen Sliders at garage doors (sliders behind shutters at bedrooms)	
D 6W		3'-10"	8'-0"	1 3/4"	SC WOOD		A600	A600	A600		Non-Rated		Existing door, replace the screen door if needed, no change to historic door	
D 11E		6'-0"	7'-0"	1 3/4"	ALUM / GLASS		A600	A600	A600		Non-Rated		Loewen, 2nd Floor Balcony (Al. Clad)	
D 22E		3'-0"	6'-6"	1 3/4"	SC WOOD		A600	A600	A600		Non-Rated		Existing door, replace the screen door if needed, no change to historic door	
D B1		2'-6"	8'-0"	1 3/4"	SC WOOD		A600	A600	A600		Non-Rated		Interior, Lower West Bedroom	
D B2		2'-10"	8'-0"	1 3/4"	SC WOOD		A600	A600	A600		Non-Rated		Interior, Lower West Bathroom	
D B3		3'-0"	8'-0"	1 3/4"	SC WOOD		A600	A600	A600		Non-Rated		Interior, Lower West Closet	
D B5		2'-6"	8'-0"	1 3/4"	SC WOOD		A600	A600	A600		Non-Rated		Interior, Lower East Bedroom	
D B6		2'-6"	8'-0"	0 1/4"	ALUM / GLASS		A600	A600	A600		Non-Rated		Interior, Lower East Bathe/Shower Door	
D B7		2'-10"	8'-0"	1 3/4"	SC WOOD		A600	A600	A600		Non-Rated		Interior, 1/2 bathe lower level	
D B8		2'-0"	8'-0"	0 1/4"	SC WOOD		A600	A600	A600		Non-Rated		Interior, Lower East Bathe/Shower Door	
D G1		3'-0"	8'-0"	1 3/4"	SC WOOD		A600	A600	A600		Non-Rated		NEW Loewen Garage, entry door	
D G2		2'-10"	6'-4"	1 3/4"	SC WOOD		A600	A600	A600		Non-Rated		NEW Loewen Garage, entry door	
D G3		4'-0"	6'-6"	1 3/4"	SC WOOD		A600	A600	A600		Non-Rated		NEW Loewen Garage, entry door	
D GAR1		12'-0"	8'-0"	1 3/4"	SC WOOD		A600	A600	A600		Non-Rated		Garage door, new	
D M 9		2'-6"	8'-0"	1 3/4"	SC WOOD		A600	A600	A600		Non-Rated		Interior, Mechanical	
D M 10		2'-8"	6'-0"	1 3/4"	SC WOOD		A600	A600	A600		1 hour		Interior, Mechanical	
D PB1		2'-10"	8'-0"	1 3/4"	SC WOOD		A600	A600	A600		Non-Rated		Primary Bedroom	
D PB2		3'-0"	8'-0"	1 3/4"	SC WOOD		A600	A600	A600		Non-Rated		Primary Bedroom, Bathroom	

Door Schedule
A501

cloud hill design, llc

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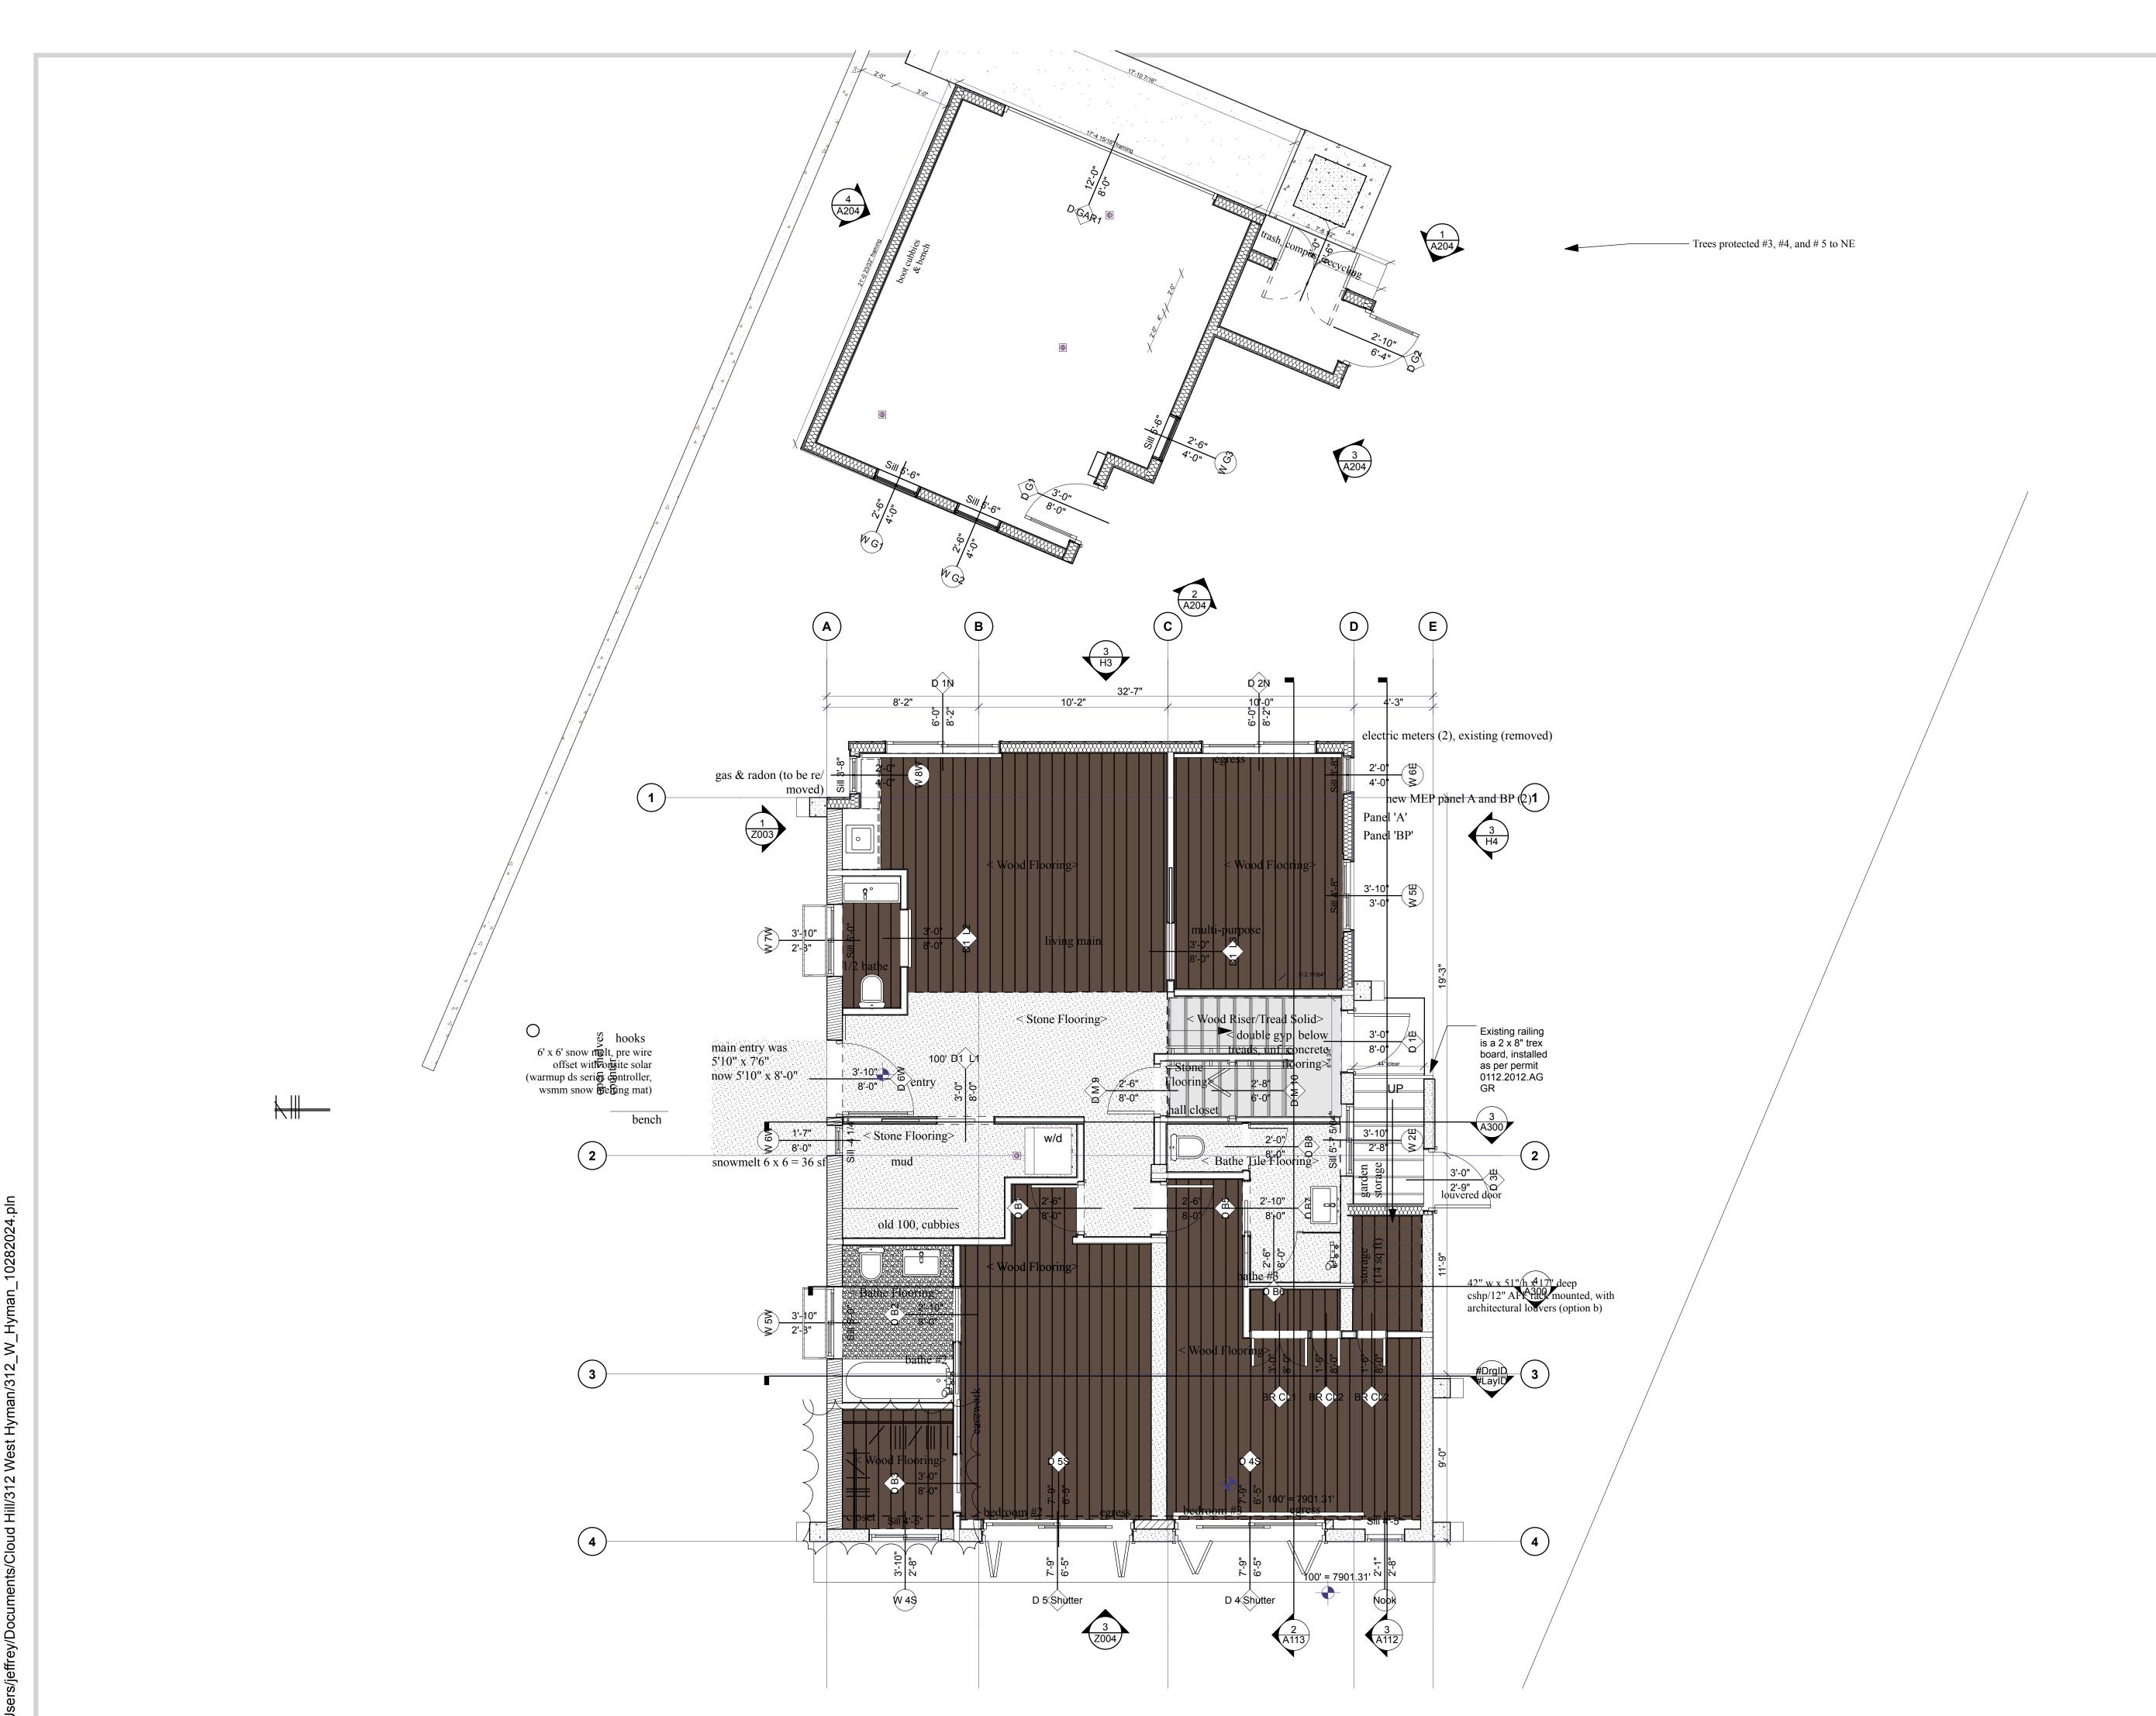
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Schedules

A501






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SHEET TITLE

N

Finish Flooring Plan

A502

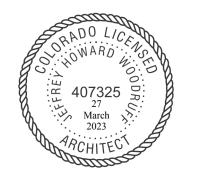SHEET 69

1 First Floor HPC Approved
A502 SCALE: 1/4" = 1'-0"

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10/28/24 Interiors

PROJECT NO: Project No. 116 MODEL FILE:

312_W_Hyman_10282024.pln DRAWN BY: Jeffrey H Woodruff

COPYRIGHT:


SHEET TITLE

N

Second Level Finish Flooring

A503


SHEET 70

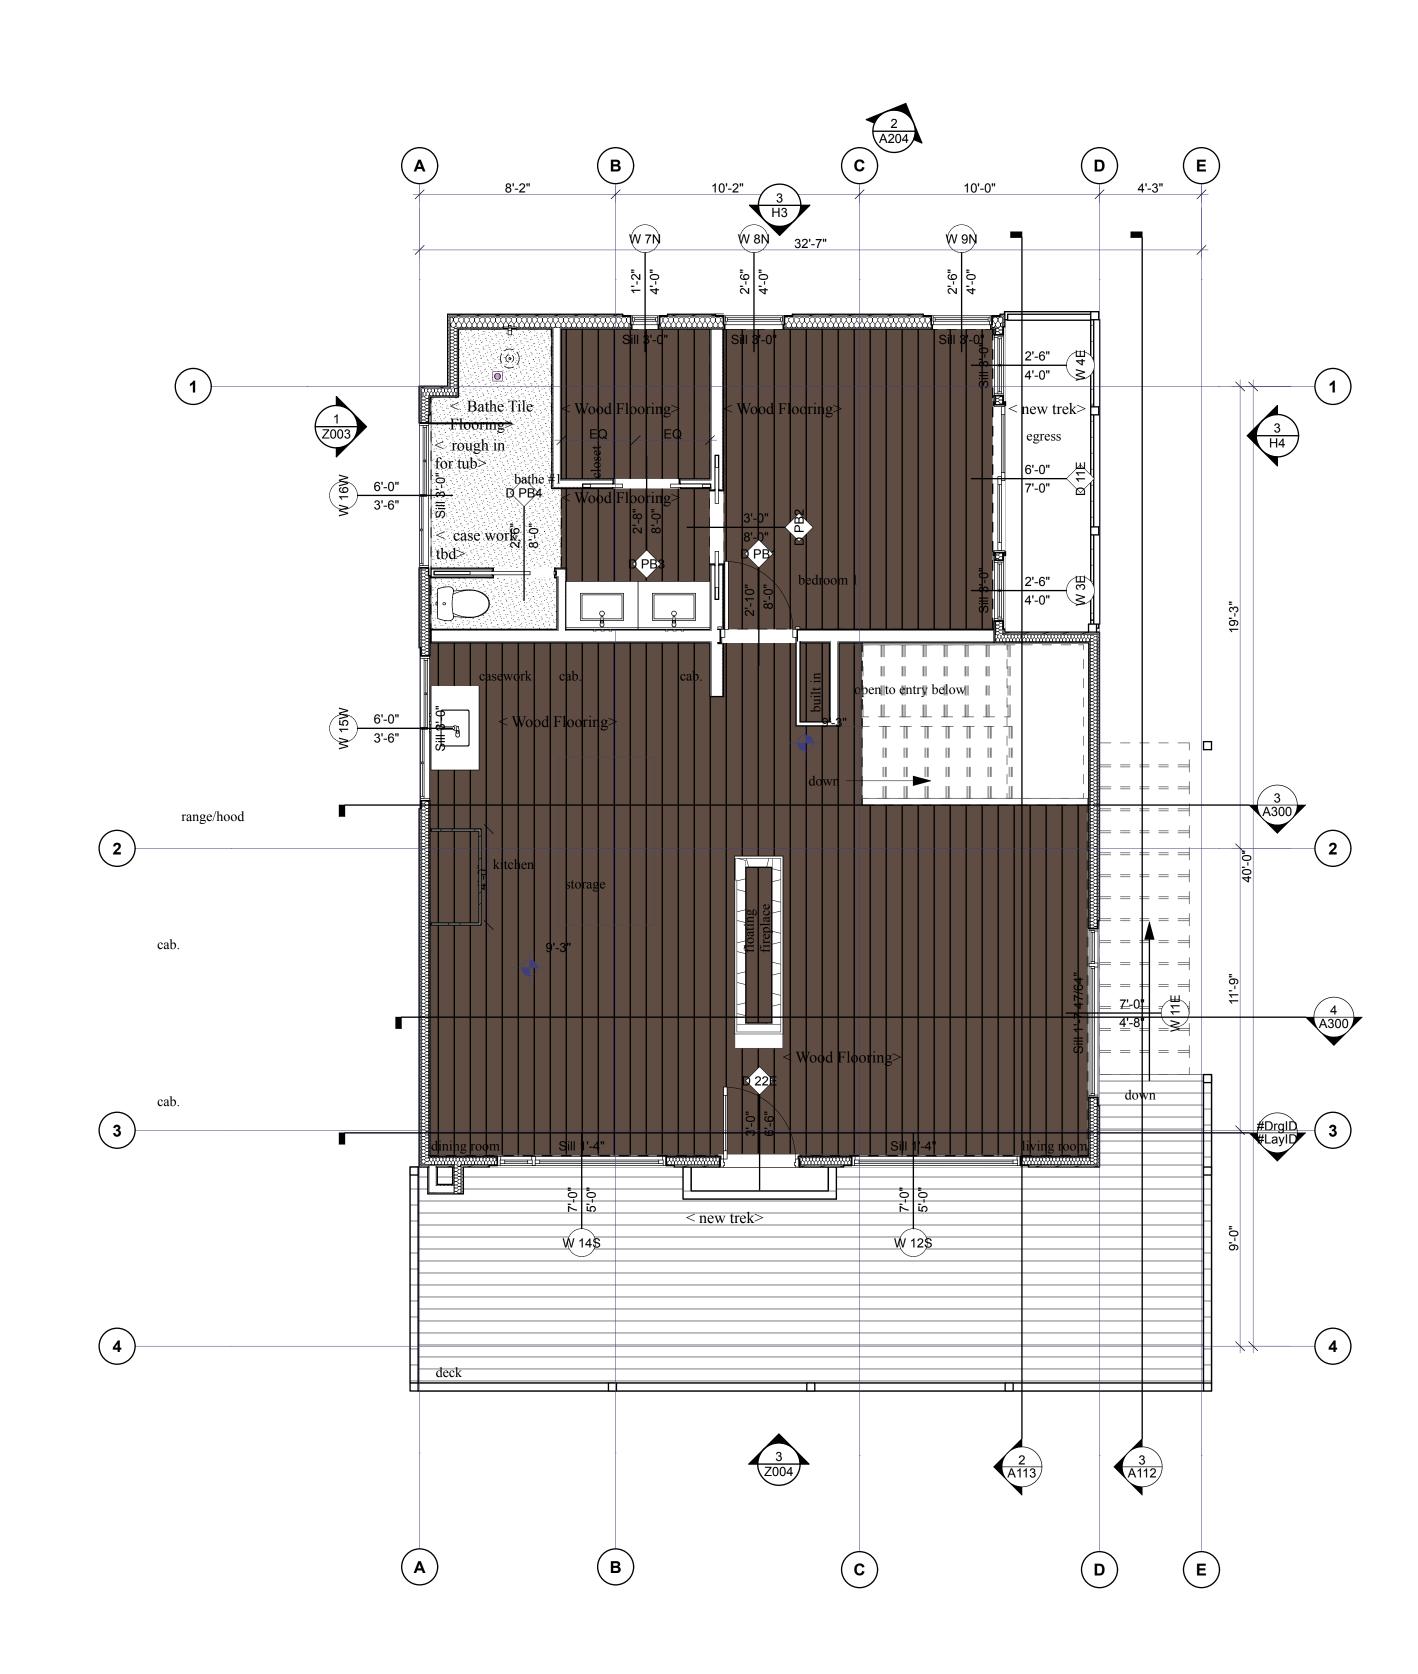

Second Floor- Flooring SCALE: 1/4" = 1'-0"

5/8" GWB R-.61 2X6 FRAMING R-21 BATT STRUCTURAL PLY AIR AND VAPOR BARRIER 1 1/2" RIGID INSUL. W/ 1 X FURRING R-9.3 AIR SPACE WOOD SIDING TOTAL R-VALUE = 30.91


W1 (HISTORIC EXISTING)

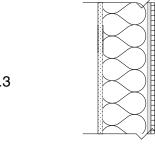

5/8" GWB (INTERIOR) 2 x 6 framing, Closed Cell Spray Foam R-7/Inch R-38.50 Exterior 2 x 5/8" DensGlass Fireguard Sheathing Applied Vertically or Horizontally to wood studs as per struct spaced as per struct with 1 3/4" galvanized roofing nails 7" AIR AND VAPOR BARRIER

"RIGID INSUL. W/ 1" X FURRING R-12.4 1" AIR SPACE (FURRING) VERTICAL WOOD CLADDING, SHIP LAP, CLASS B OR BETTER TOTAL R-VALUE = 50.9

W2 NEW CONSTRUCTION WOOD WALL (RESIDENCE)

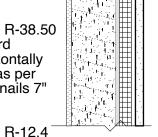

TOTAL R VALUE = 21 W3 (Historic Existing CMU), add continuous insulation (interior) at habitable spaces,

to add R-5 to R-9.3 to assembly for thermal comfort

DRAINAGE MAT (BELOW GRADE ONLY)


WATERPROOFING (BELOW GRADE ONLY)

HISTORIC BUILDING

3/4" AIR GAP

2 X 4 FRAMING

CONCRETE MASONRY UNIT

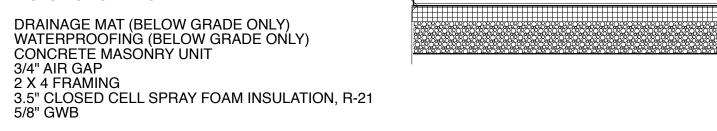

• PAVERS (AS PER LANDSCAPE PLAN) SAND BASE WSMM SNOW MELTING MAS • CRUSHED GRAVEL • 2" POLYISO RIGID INSUL = R 13.0

R Value of Assembly = R13.0 F2 (floor at entry)

• 4" GRAVEL

SLAB ON GRADE

• 4" GRAVEL

SUBGRADE


• 2" RIGID INSULATION

F1 (Existing Historic slab)

• 15 MIL VAPOR RETARDER

• UNDISTURBED OR COMPACTED

• UNDISTURBED OR COMPACTED

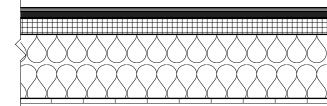

HISTORIC ROOF torch applied 3 layer asphalt1/2" DENSDECK, THERMAL, MOISTURE,

WIND BARRIER (Not on file) • 1 1/2" POLYISO RIGID INSUL R7.5 (Not on file, not with permit, COA client)

• 3/4" SHEATHING WOOD RAFTERS RE: STRUCT • SPRAY FOAM (7.5" @ R7 /in) R 52.5 HAT CHANNEL'S

WOOD T&G

TOTAL R VALUE = R60 THIS ROOF WAS INSTALLED BY THE CITY OF ASPEN, PLEASE SEE JEFF PENDARVIS' CUT SHEETS AND PERMIT. THIS IS A HISTORIC CITY OF ASPEN INSTALLATION BY THE CITY'S ROOFER

R1 (Removing drop ceiling, adding new insulation. Sistering new rafters 2 x 12", assuming 7.5" minimum spray foam)

5/8" GWB (OR TWO LAYERS MRG) R-.5625 10 GAUGE STEEL (BOX) FIBER CEMENT BOARD STRUCTURAL PLY R-.62 AIR AND VAPOR BARRIER 1 1/2" RIGID INSUL. W/ 1 X FURRING R-5 STUCCO TOTAL R-VALUE = 16.5

W 6 Chimney and Flu (Rebuilt)

2X4 FRAMING ACCOUSTIC BAT INSUL.


W5

Interior 5/8" DensArmor Plus Fireguard Interior Panels or ToughRock 5/8" Fireguard X gypsum board applied vertically or horizontally to stude with 1- 7/8" 6D coated nails 7" o.c. Stagger Joints Each Side Framing as per struct, SPRAY FOAM FOR ASPEN Exterior 2 x 5/8" DensGlass Fireguard Sheathing Applied Vertically or Horizontally to wood studs as per struct spaced as per struct with 1 3/4" galvanized roofing nails 7" o.c. AIR AND VAPOR BARRIER

2" RIGID INSUL. W/ 1" X FURRING 1" AIR SPACE (FURRING) R-12.4 R-NA STUCCO

TOTAL R-VALUE = 38.5 + 12.4 = 50.9 SO THE SPRAY FOAM AND THE INSULATION MEET THE AHJ 2021 REQUIREMENTS AS PER ASPENS TABLE R402-1-3 AS PER THE TABLE 34 + 12 CI, WE ARE 38.5 + 12.4 CI = 50.98 R-VALUE METHOD

W4-X 1 Hour Firewall @ Garage (AS PER GP CUT SHEET BELOW)

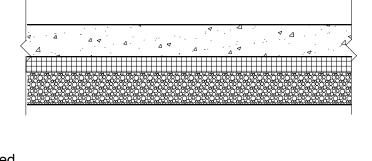

 CARPET AND PAD • 3/4" PLYWOOD(UNDERLAYMENT GRADE) • 1X2 SLEEPERS • 2" RIGID INSULATION • 15 MIL VAPOR RETARDER • 4" GRAVEL

F3 (Existing Historic slab)


SUBGRADE

CURRENT HISTORIC STRUCTURE ROOF, INSTALLED BY THE CITY OF ASPEN, CAPITAL ASSETS DIVISION Permit 0003.2013.ARGR

Owner (City of Aspen) contracted with GZO Sheet metal to replace tar and gravel roof with torch applied asphalt (3 layer torch down) this replaced the 1991 roof that was a mansville built up, spec 4GNG.


The work performed does not comply with grading and drainage. As per the City of Aspen, changed existing trim and fascia profile and gutter, 01/11/13 tear off existing deck membrane and roof, add box gutter to front of deck


0112.2012.ARGR A 14" aspen was removed in 2014, in order to install patio with pavers (assuming west patio)

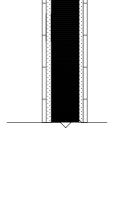

WOOD SIDING, T&G, ASTM E119 STRUCTURAL EXT PLY, DENSGLASS POSTS, AS PER STRUĆT STRUCTURAL EXT PLY, DENSGLASS WOOD SIDING, T&G, ASTM E119 TOTAL R-VALUÉ = NOT HEATED, EXTERIOR DECK

W12 (North Deck Exterior

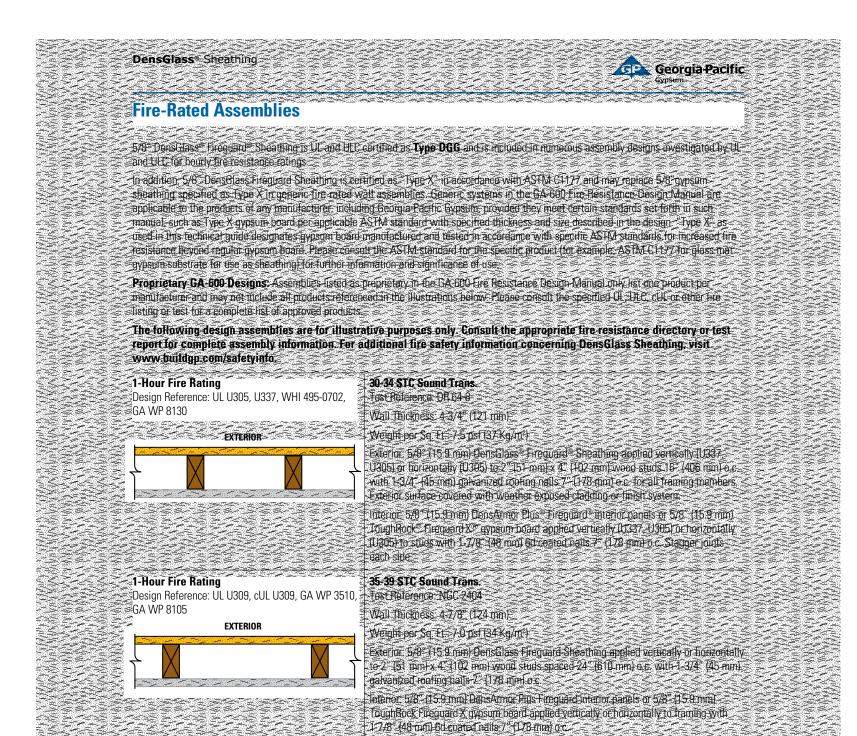


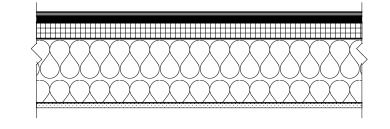

• 1/2" DENSDECK • THERMAL, MOISTURE, WIND BARRIER • 2" POLYISO RIGID INSÚL R13.0 • 3/4" SHEATHING • WOOD RAFTERS RE: STRUCT • SPRAY FOAM (7.5" @ R7 /in) R52.5 • HAT CHANNEL'S • INTERIOR GWG • EXTERIOR: FIBER CEMENT BOARD AT ALL EAVES (CLASS 1(A) FIRE/FLAME SPREAD RATING TOTAL R VALUE = R 66.06

• TEE-LOCK STANDING SEAM METAL ROOF

R2 (Garage, new), UL 790 CLASS A ROOF OR ASTM E108

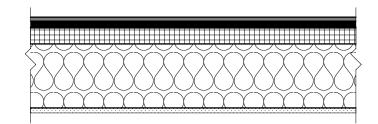

• SYTHETIC DECKING MATERIAL, TIMBERTECH IS TESTED IN ACCORDANCE WITH ASTM E84) • SLEEPERS AS PER ASTM E84 OR UL723 (FIRE RETARDANT TREATED WOOD)

• 1/2" DENSDECK TESTED IN ACCORDANCE WITH ASTM E-84

• CLASS A THERMAL, MOISTURE, WIND BARRIER • 2" POLYISO RIGID INSUL R13.0 FOAMULAR® & FOAMULAR® NGX® 250 ASTM E84 • WOOD RAFTERS RE: STRUCT (OVER CONDITIONED SPACE)

• SPRAY FOAM (7.5" @ 7 R/in) R52.5 HAT CHANNEL'S TOTAL R VALUE = R66.06

R3 (Primary Bed, Decking)

cloud hill design. llc

Jeffrey H. Woodruff AIA, NCARB, LEED AP Cloud Hill Design, LLC Snowmass CO 81654 USA

INTEGRATED DESIGN TEAM

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Landscape Architect Jennifer M. Dolecki-Smith, RLA Escape Garden Design, LLC

Structural Engineer Brian Rossiter, P.E. bwr.pe

Contractor Adam Rothberg Rothberg Development



312 W Hyman Ave 312 W Hyman Ave Lots P+Q,

Block 46 Aspen CO 81611 USA/ Pitkin County UGB, City of Aspen

312 W Hyman Ave Aspen CO 81611 USA

Powder Day Skiiing, LLC, David A Tarrab Mees

Account # R000145 Parcel ID # 273512464006

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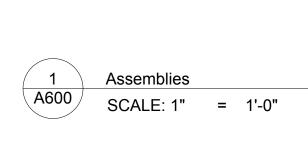
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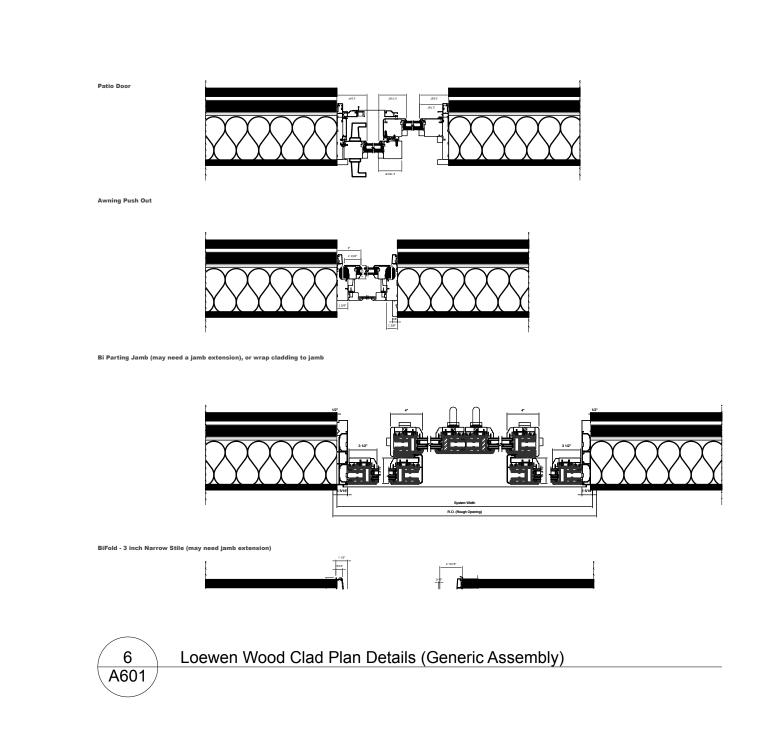
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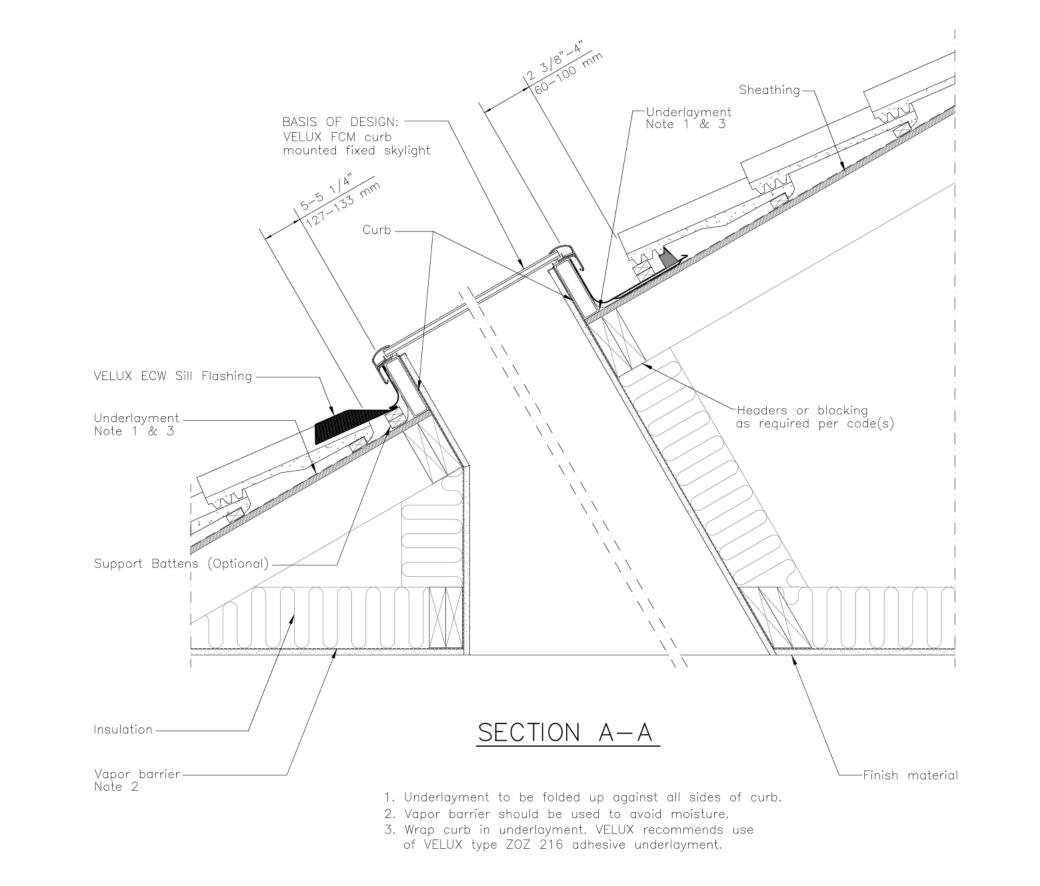
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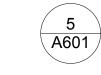
SHEET TITLE

Assemblies & Plan **Details**












light shaft DASI, VELUX Digital Asset Storage Infrastructure

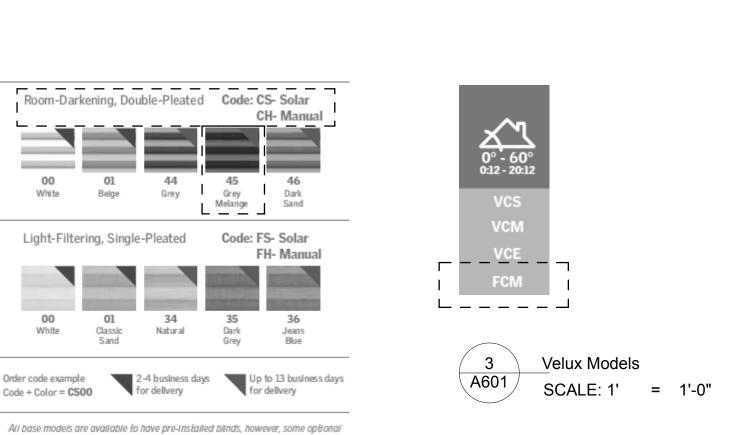


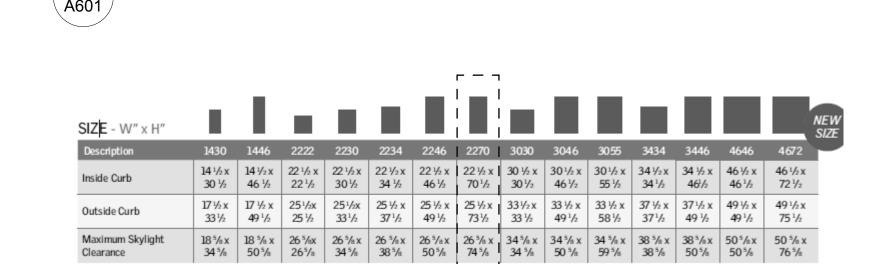

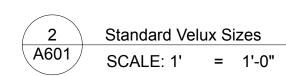

Code + Color = CS00

skylight models may not be available. VELUX Customer Service will confirm

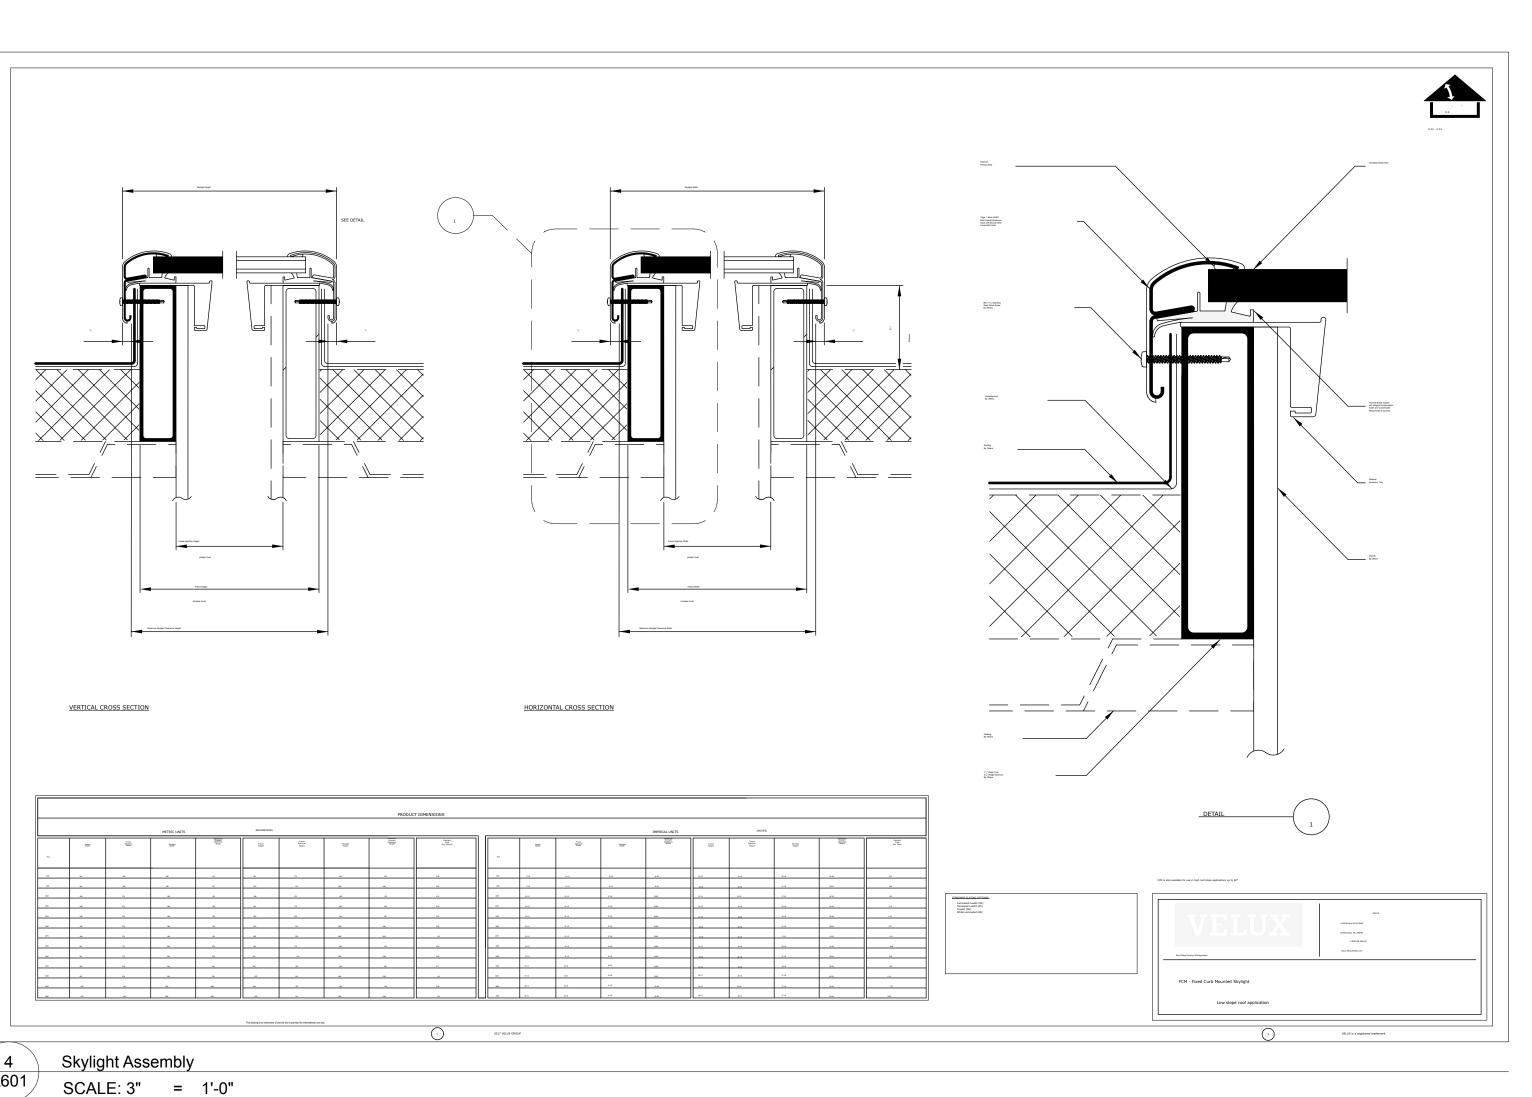

cloud hill design. Ilc

Jeffrey H. Woodruff AIA, NCARB, LEED AP Cloud Hill Design, LLC Snowmass CO 81654 USA


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312 W Hyman Ave

312 W Hyman Ave Lots P+Q, Block 46 Aspen CO 81611 USA/ Pitkin County UGB, City of Aspen

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MODEL FILE: 312_W_Hyman_10282024.pln

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SHEET TITLE

Assemblies- Skylights, Fenestration

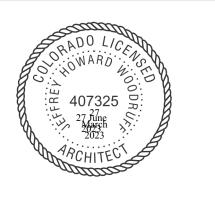A601



Light at the property line < .5 Foot Candles as per code. The existing lighting is a mix of jelly jars and exposed lamps.


ACCESSORIES

Optional



1. Heavy Metal and RDX only 2. Heavy Metal and RDX glasses are 7½" in height 3. Heavy Metal and RDX glasses are 4" in diameter

CAST GUARD WITH GLASS ENCLOSURE Cast guard can be specified in all standard and specialized finishes, and will match shade finish unless otherwise specified (Note: For galvanized shade finishes, cast guard is unfinished Raw Aluminum) • Glass is available in clear (-CGG), frosted (-FGG) or opal (-OGG) ¹ See fixture pages for availability

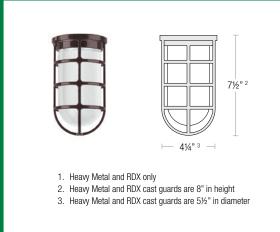

WIRE CAGE WITH GLASS ENCLOSURE • Wire cage can be specified in all standard and specialized finishes, and will match shade finish unless otherwise specified (Note: For galvanized shade finishes, wire cage is finished in Painted Natural Aluminum) Glass is available in clear (-CGWC) or frosted (-FGWC) See fixture pages for availability

-CGWC (Clear Glass w/ Wire Cage) -FGWC (Frosted Glass w/ Wire Cage)

GLASS ENCLOSURE


See fixture pages for availability

-CG (Clear Glass Enclosure)

-FGG (Frosted Glass w/ Cast Guard) -OGG (Opal Glass w/ Cast Guard)

• Glass is available in clear (-CG), frosted (-FG) or opal (-OG)



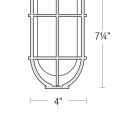





A- E101

City of Aspen

City of Aspen 312 W Hyman Ave #Upst 01-25036520-00

City of Aspen 312 W Hyman Ave #DWST 01-250360-00

Renewables - Energy Neutral- Renewable Electrification

pane glass of the thinnest dimension, with a dark spacer"

Thermal loads- assuming two units, need of 40 A/unit

Mitsubishi Hyper-Heat Electrical Requirements Model:

Current ACH > 1.2. Will provide blower door (pre and) post construction.

negative temperature and hyper heat performs with less efficiency)

Power Supply Voltage, Phase, Hertz 208 / 230V, 1-Phase, 60 Hz

LED lighting and controls all run on < 15 AMP (if all LED)

Hot tub <64 Sq Ft. (to avoid REMP fees), Crown XL

Eave snowmelt (linear feet, health safety at entry)

Walkway snowmelt (low albedo pavers)

Onsite renewable energy and storage

5 Tesla Powerwalls (work with CORE)

312 W Hyman Ave #DWST on a 100 Amp

No REMP (< 64 SQ FT hot tub, no snowmelt)

Building Mechanical Systems- Building Loads

MXZ-8C48NAHZ2 (48,000 BTU/H)

Recommended Fuse/Breaker Size

Voltage Indoor - Outdoor S1-S2 A

MXZ-8C60NA2 (60,000 BTU/H)

12 April 2023

Efficiency

MCA 35 A

C 208 / 230

Kitchen Needs

Indoor - Outdoor S2-S3

Electrical requirements

Outdoor energy consumption

Car charger in detached garage

Solar array (on garage roof)

+12 VDC to +24 VDC

Building Envelope

Jeffrey Woodruff, Cloud Hill Design, LLC, rep Powderdayskiing, LLC

RE: Electrical service needs at 312 West Hyman, as per HPC conceptual review and follow up

312 W Hyman Ave #Upst on a 200 Amp service (need to confirm again with provider)

Work with City of Aspen Electric (no incentives), CORE (rebates and grants), Federal ITC.

Currently we have 300 Amp total building services, far exceeding our current and anticipated needs

Windows- all outmoded, end of useful life single pane with no UV protection. Solution to existing single pane, "installing double

Thermal loads- assuming one or two units, need of 40 A/unit (assuming potential for electric back up - for low temp, id est

Electric refrigeration

Induction Electric cooking

AO Smith (and Water Softener)

Hot water heater/heat pump/Energy Star (heat pump/hybrid) (AO Smith or Rheem)

Dishwasher

WasherDryer(s)

Fossil fuel needs- outdoor gathering space outdoor electric space heaters (preferred)


16 RLM-Catalog_2022-V2 page 58-59 SCALE: 1' = 1'-0"



LED LIFETIME

ECO 3" LED DOWNLIGHT

ED3AIC, ED3ANC, ED3NC, ED3RM ED3LAIC, ED3LANC, ED3LNIC, ED3LRIC

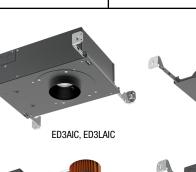

	8	ED3NC, ED3LN
C, ED3LAI	С	<u> </u>
M, ED3LRI	c	ED3SNIC
CS TECI	HNOLOGY	
	50° Installed 10° 20° 90°	available

SILENT VU™ OPTIC OPTICS 50° Installed, 10°, 30°, 80° available ADJUSTABLE 0° to 45° tilt (Adjustable housings only) Clear, Solite, Frosted, Linear Spread POWER SUPPLY INPUT VOLTAGE 120/277V, 50/60Hz DIMMING TRIAC, ELV, 0-10V, dims to 1%

SERVICABILITY	Below Ceiling Access
TRIM OPTIONS • Fixed or Adjustable • Round or Square • Standard or Trimless • Wall Wash • Wet Location	TRIM COLORS White Black Sliver w/ White Flange Champagne Champagne w/ White Flange

HOUSING INSTALLATION New Construction includes (2) galvanized steel adjustable hanger bars Remodel option available

• 5/8" ~ 2" ceiling thickness Min Plenum Height: 2½" Shallow Ceiling Material: Drywall, T-bar grid • Steel junction box with up to (4) ½" knockouts AIC, NIC, RIC, SNIC models are Air Tight

 AIC, SNIC models are CCEA compliant. (Note: polycell spray-in foam insulation must be kept 3" from housing)

IC Rated and Non IC Rated Available CCEA (Chicago Plenum) Approved (AIC, SNIC Models) Five (5) years limited warranty CA Title 24-JA8 Compliant (AIC, NIC, RIC, SNIC Models)



ASTM E283 Certified Airtight (AIC, NIC, RIC, SNIC Models)

RSI ECO DOWNLIGHTS SPEC-00272 NEW ECO, 3", V-7.1, UPDATED 12/29/2022

LED LIGHT ENGINE RATED WATTAGE 20.1W, 13.4W, 11.3W DELIVERED LUMENS Up to 1929 Im EFFICACY Up to 108 LPW 2700K, 3000K, 3500K, 4000K, Warm Dim CCT @ 90CRI 90+ CRI, 2-Step SDCM COLOR QUALITY

55,000 hours @ L90

DELIVERED LUMENS N	MATRIX			
ED3 (20.1W)	10° Optic	30° Optic	50° Optic	80° Optic
2700K (90CRI)	1669 lm	1744 lm	1592 lm	1125 lm
3000K (90CRI)	1803 lm	1884 lm	1720 lm	1216 lm
3500K (90CRI)	1846 lm	1929 lm	1761 lm	1244 lm
4000K (90CRI)	1900 lm	1985 lm	1812 lm	1281 lm
ED3 NIC, RIC (13.4W)	10° Optic	30° Optic	50° Optic	80° Optic
Warm Dim (98 CRI, R9>90)	868 lm	938 lm	846 lm	604 lm
ED3 AIC, ANC (20.1W)	10° Optic	30° Optic	50° Optic	80° Optic
Warm Dim (98 CRI, R9>90)	1195 lm	1291 lm	1165 lm	832 lm
ED3L (11.3W)	10° Optic	30° Optic	50° Optic	80° Optic
2700K (90CRI)	1061 lm	1108 lm	1012 lm	715 lm
3000K (90CRI)	1146 lm	1198 lm	1093 lm	773 lm
3500K (90CRI)	1173 lm	1226 lm	1119 lm	791 lm
4000K (90CRI)	1207 lm	1262 lm	1152 lm	814 lm
ED3S (13.4W)	10° Optic	30° Optic	50° Optic	80° Optic
, ,				•
2700K (90CRI)	1214 lm	1269 lm	1158 lm	819 lm
3000K (90CRI)	1312 lm	1371 lm	1252 lm	885 lm
3500K (90CRI)	1343 lm	1403 lm	1281 lm	905 lm
4000K (90CRI)	1382 lm	1445 lm	1319 lm	932 lm


Warm Dim (98 CRI, R9>90) 868 lm 938 lm 846 lm 604 lm

CULUS WET IC SSS DIMMABLE COMPLIANT WARM DIM SYEAR LIMITED WARRANTY

LISTINGS AND WARRANTY

cULus Listed

14508 Nelson Ave. City of Industry. CA 91744 • tel: 626.336.4511 • fax: 626.330.4266 • www.csllighting.com ©2022 Creative Systems Lighting, A Division of Troy-CSL Lighting, Inc. All rights reserved. Subject to change without notice.

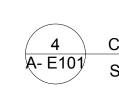

Patent: csllighting.com/patents

Cloud Hill Design, LLC Snowmass CO 81654 USA

cloud hill

design. Ilc

Jeffrey H. Woodruff

AIA, NCARB, LEED AP

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bwr.pe



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Pitkin County UGB, City of Aspen

Powder Day Skiiing, LLC, David A **Tarrab Mees**

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SHEET TITLE

COPYRIGHT:

Electrical- Lamps

A- E101



SUNPOWER®


390–400 W Residential A-Series Panels

SunPower® Maxeon® Technology

SunPower® Maxeon® cell-based panels maximize energy production and savings by combining industry-leading power, efficiency, and durability with the most comprehensive power, product, and service warranty in the industry.^{1,2}



unPower's new Maxeon Gen 5 cell is 65% larger than prior generations, delivering the most powerful cell and highest efficiency panel in residential solar.² The result is more power per square meter than any commercially available solar.¹

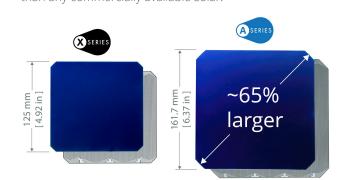

Solar Cell Technology



Fundamentally Different. And Better.

SunPower Maxeon

- Cell efficiencies of over 25% Delivers leading reliability³ Patented solid metal foundation
- prevents breakage and corrosion As sustainable as the


energy it produces.

 Achieved the #1 ranking on the Silicon Valley Toxics Coalition's Solar Scorecard for 3 years running

your business's LEED certification⁴


SunPower modules can contribute to

Highest Power Density Available

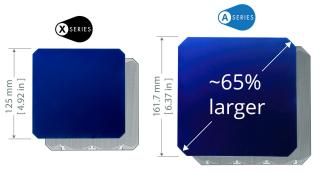

Maximum Lifetime Energy and Savings

Designed to deliver up to 54% more energy from the same space over the first 25 years in real-world conditions like partial shade and high temperatures.1

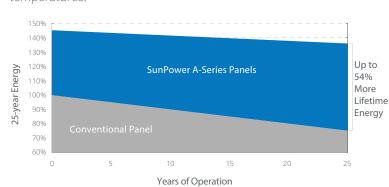

312 W Hyman

Lower Level



Best Reliability, Best Warranty

SunPower technology is proven to last and we stand behind our panels with the industry's most comprehensive 25-year Combined Power, Product and Service Warranty.



POWERWALL

Tesla Powerwall is a fully-integrated AC battery system for residential or light commercial use. Its rechargeable lithium-ion battery pack provides energy storage for solar self-consumption, time-based control, and backup.

Powerwall's electrical interface provides a simple connection to any home or building. Its revolutionary compact design achieves market-leading energy density and is easy to install, enabling owners to quickly realize the benefits of reliable, clean power.

PERFORMANCE SPECIFICATIONS

MECHANICAL SPECIFICATIONS

AC Voltage (Nominal)	120/240 V	Dimensions ¹		nm x 755 mm x 147 mm
Feed-In Type	Split Phase	\A/-! -	`	in x 29.6 in x 5.75 in)
Grid Frequency	60 Hz	Weight ¹	114 kg	(251.3 lbs)
Total Energy	14 kWh	Mounting options	Floor	or wall mount
Usable Energy	13.5 kWh	¹ Dimensions and weight diffe Contact Tesla for additional		ufactured before March 2019
Real Power, max continuous	5 kW (charge and discharge)		mm .6 in)	147 mm (5.75 in)
Real Power, peak (10 s, off-grid/backup)	7 kW (charge and discharge)	-	•	<u> </u>
Apparent Power, max continuous	5.8 kVA (charge and discharge)			
Apparent Power, peak (10 s, off-grid/backup)	7.2 kVA (charge and discharge)	TE	5 L R	(2000)
Maximum Supply Fault Current	10 kA			
Maximum Output Fault Current	32 A			Į.
Overcurrent Protection Device	30 A			1150 mm (45.3 in)
Imbalance for Split-Phase Loads	100%			
Power Factor Output Range	+/- 1.0 adjustable			
Power Factor Range (full-rated power)	+/- 0.85			A
Internal Battery DC Voltage	50 V			
Round Trip Efficiency ^{1,3}	90%		П	∓

COMPLIANCE INFORMATION

²In Backup mode, grid charge power is limited to 3.3 kW.

³AC to battery to AC, at beginning of life.

¹Values provided for 25°C (77°F), 3.3 kW charge/discharge power.

Warranty

TESLA

Certifications	UL 1642, UL 1741, UL 1973, UL 9540, IEEE 1547, UN 38.3
Grid Connection	Worldwide Compatibility
Emissions	FCC Part 15 Class B, ICES 003
Environmental	RoHS Directive 2011/65/EU
Seismic	AC156, IEEE 693-2005 (high)

10 years

Dimensions ¹		1150 mm x 755 mm x 147 mm (45.3 in x 29.6 in x 5.75 in)				
Weight ¹	114	114 kg (251.3 lbs)				
Mounting opti	ons Flo	or or wall mount				
	nd weight differ slightly if n for additional information. 753 mm (29.6 in)	nanufactured before March 201 147 mm (5.75 in)				
	TESLR					
		1150 mr (45.3 in				

TESLA

ENVIRONMENTAL SPECIFICATIONS

perating Temperature	-20°C to 50°C (-4°F to 122°F)
ecommended Temperature	0°C to 30°C (32°F to 86°F)
perating Humidity (RH)	Up to 100%, condensing
torage Conditions	-20°C to 30°C (-4°F to 86°F) Up to 95% RH, non-condensing State of Energy (SoE): 25% initial
laximum Elevation	3000 m (9843 ft)
nvironment	Indoor and outdoor rated
nclosure Type	NEMA 3R
ngress Rating	IP67 (Battery & Power Electronics) IP56 (Wiring Compartment)
Vet Location Rating	Yes
loise Level @ 1m	< 40 dBA at 30°C (86°F)

TESLA.COM/ENERGY

-chargepoin+

ChargePoint Home Flex

Specifications and Ordering Information

Ordering Information

Description		Model Number
Station and Cable Model	16A-50A, NEMA 6-50 plug, 7010.4 mm (23') Charging Cable	CPH50-NEMA6-50-L23
	16A-50A, NEMA 14-50 plug, 7010.4 mm (23') Charging Cable	CPH50-NEMA14-50-L23
Replacement Cable	7010.4 mm (23') Charging Cable	CPH50Cable-T1-50A-L23-F



ChargePoint® Home Flex

works with amazon alexa



INTEGRATED DESIGN TEAM

Civil Grading and Drainage Jay Engstrom, P.E. Crystal River Civil, LLC

Structural Engineer Brian Rossiter, P.E.

Contractor Adam Rothberg Rothberg Development

bwr.pe

Landscape Architect Jennifer M. Dolecki-Smith, RLA Escape Garden Design, LLC

design. Ilc

Jeffrey H. Woodruff

AIA, NCARB, LEED AP

Cloud Hill Design, LLC

Snowmass CO 81654 USA

312 W Hyman Ave Lots P+Q,

Block 46 Aspen CO 81611 USA/ Pitkin County UGB, City of Aspen

312 W Hyman Ave Aspen CO 81611 USA

Powder Day Skiiing, LLC, David A **Tarrab Mees**

Account # R000145 Parcel ID # 273512464006

08/22/21 COA- HPO Site Visit

02/26/22 COA- HPC Conceptual I

04/27/22 COA- HPC Conceptual II

07/27/22 COA- HPC Final

10/12/22 COA- City Council Call Up

04/12/23 COA- HPC Substantial

06/28/23 COA- Permit Submittal

07/29/24 COA- Building comments, #4 10/25/24 COA- Vault Setback, #5

10/28/24 Interiors

PROJECT NO: Project No. 116 MODEL FILE:

312_W_Hyman_10282024.pln DRAWN BY: Jeffrey H Woodruff

SHEET TITLE

COPYRIGHT:

Electrical- Exterior

A- E102

SHEET 74

PUZ-HA42NKA1 0.0 ft Pipe Dia. Liquid / Gas Model 1941115 7.9 357 Pipe Length (Elbows) Address/Group / Room / Tag Ref. 1.2

LL Living/Mud Bath 2 6.2 32,351 BTU/h (30,523 BTU/h) Est. Cooling Discharge Air Temp: 60.6 34,086 BTU/h Est. Heating Discharge Air Temp: 91.3 2.7 7.7 Bed 3 16.0ft (4) 2.3 34.1 16 770 PVA-A42AA7 33.3 32.1 1040 PUZ-HA42NKA1 Pipe Dia. Liquid / Gas Model Number Elevation Clg Total (5 Htq.Total | 1 Htq.Total | 1 Address/Group / Room / Tag Ref. PUZ-HA42NKA1 0.0 ft Upper Level Great Room 12.2 609 32,142 BTU/h (28,161 BTU/h) Est. Cooling Discharge Air Temp: 62.1 33,345 BTU/h Est. Heating Discharge Air Temp: 90.8 4.3 Bedroom 1 2.3 124 Bath 1 & closet 34.3 18.8 32.4 1024 PEAD-A42AA7



PUZ-HA42NKA1

EH10-MPA-LB

312 W Hyman Cold Sourced Heat Pump- Manual J

NORDIC HOT TUBS

CROWN XL DIMENSIONS Seating

6 person 84 in (213 cm) Diameter Depth 38.5 in (89 cm) 400 lbs (181 kg) Weight (Dry) 330 gal (1249 L) Operating Capacity

JETS Total Jets

CLASSIC SERIES

5" Nordic Star™ Directional Whirlpool 5" Nordic Star™ Dual Rotational 3" Nordic Star™ Directional 3" Nordic Star™ Dual Rotational 2" Nordic Star™ Directional 1" Ozone Ready Jet (Ozonator Optional)

ECOIPIVIEN	N I
Volts	220v
Amps	40a
Control Pad	4 button Topside w/LED Display
Insulation:	Foam (Standard) Nordic Wrap (Optional)
Heater	4kw
Light	Footwell LED (Standard) Mood Lighting Package (Optional)
Pump	(1) 3hp Continuous Duty



Bluetooth Stereo



Optional Upgrade

Color samples are for reference only. Actual product color may vary slightly.

Nordic Products Inc. reserves the right to change any specifications without notice.





Shell: Eclipse | Cabinet: Charcoal

